




St Leonards


13-19 Canberra Ave St Leonards

SJB Architects Level 2, 490 Crown Street Surry Hills NSW 2010 Australia T 61 2 9380 9911 F 61 2 9380 9922


Project Number: Date: Client: 6429 05/04/2024 HYECORP



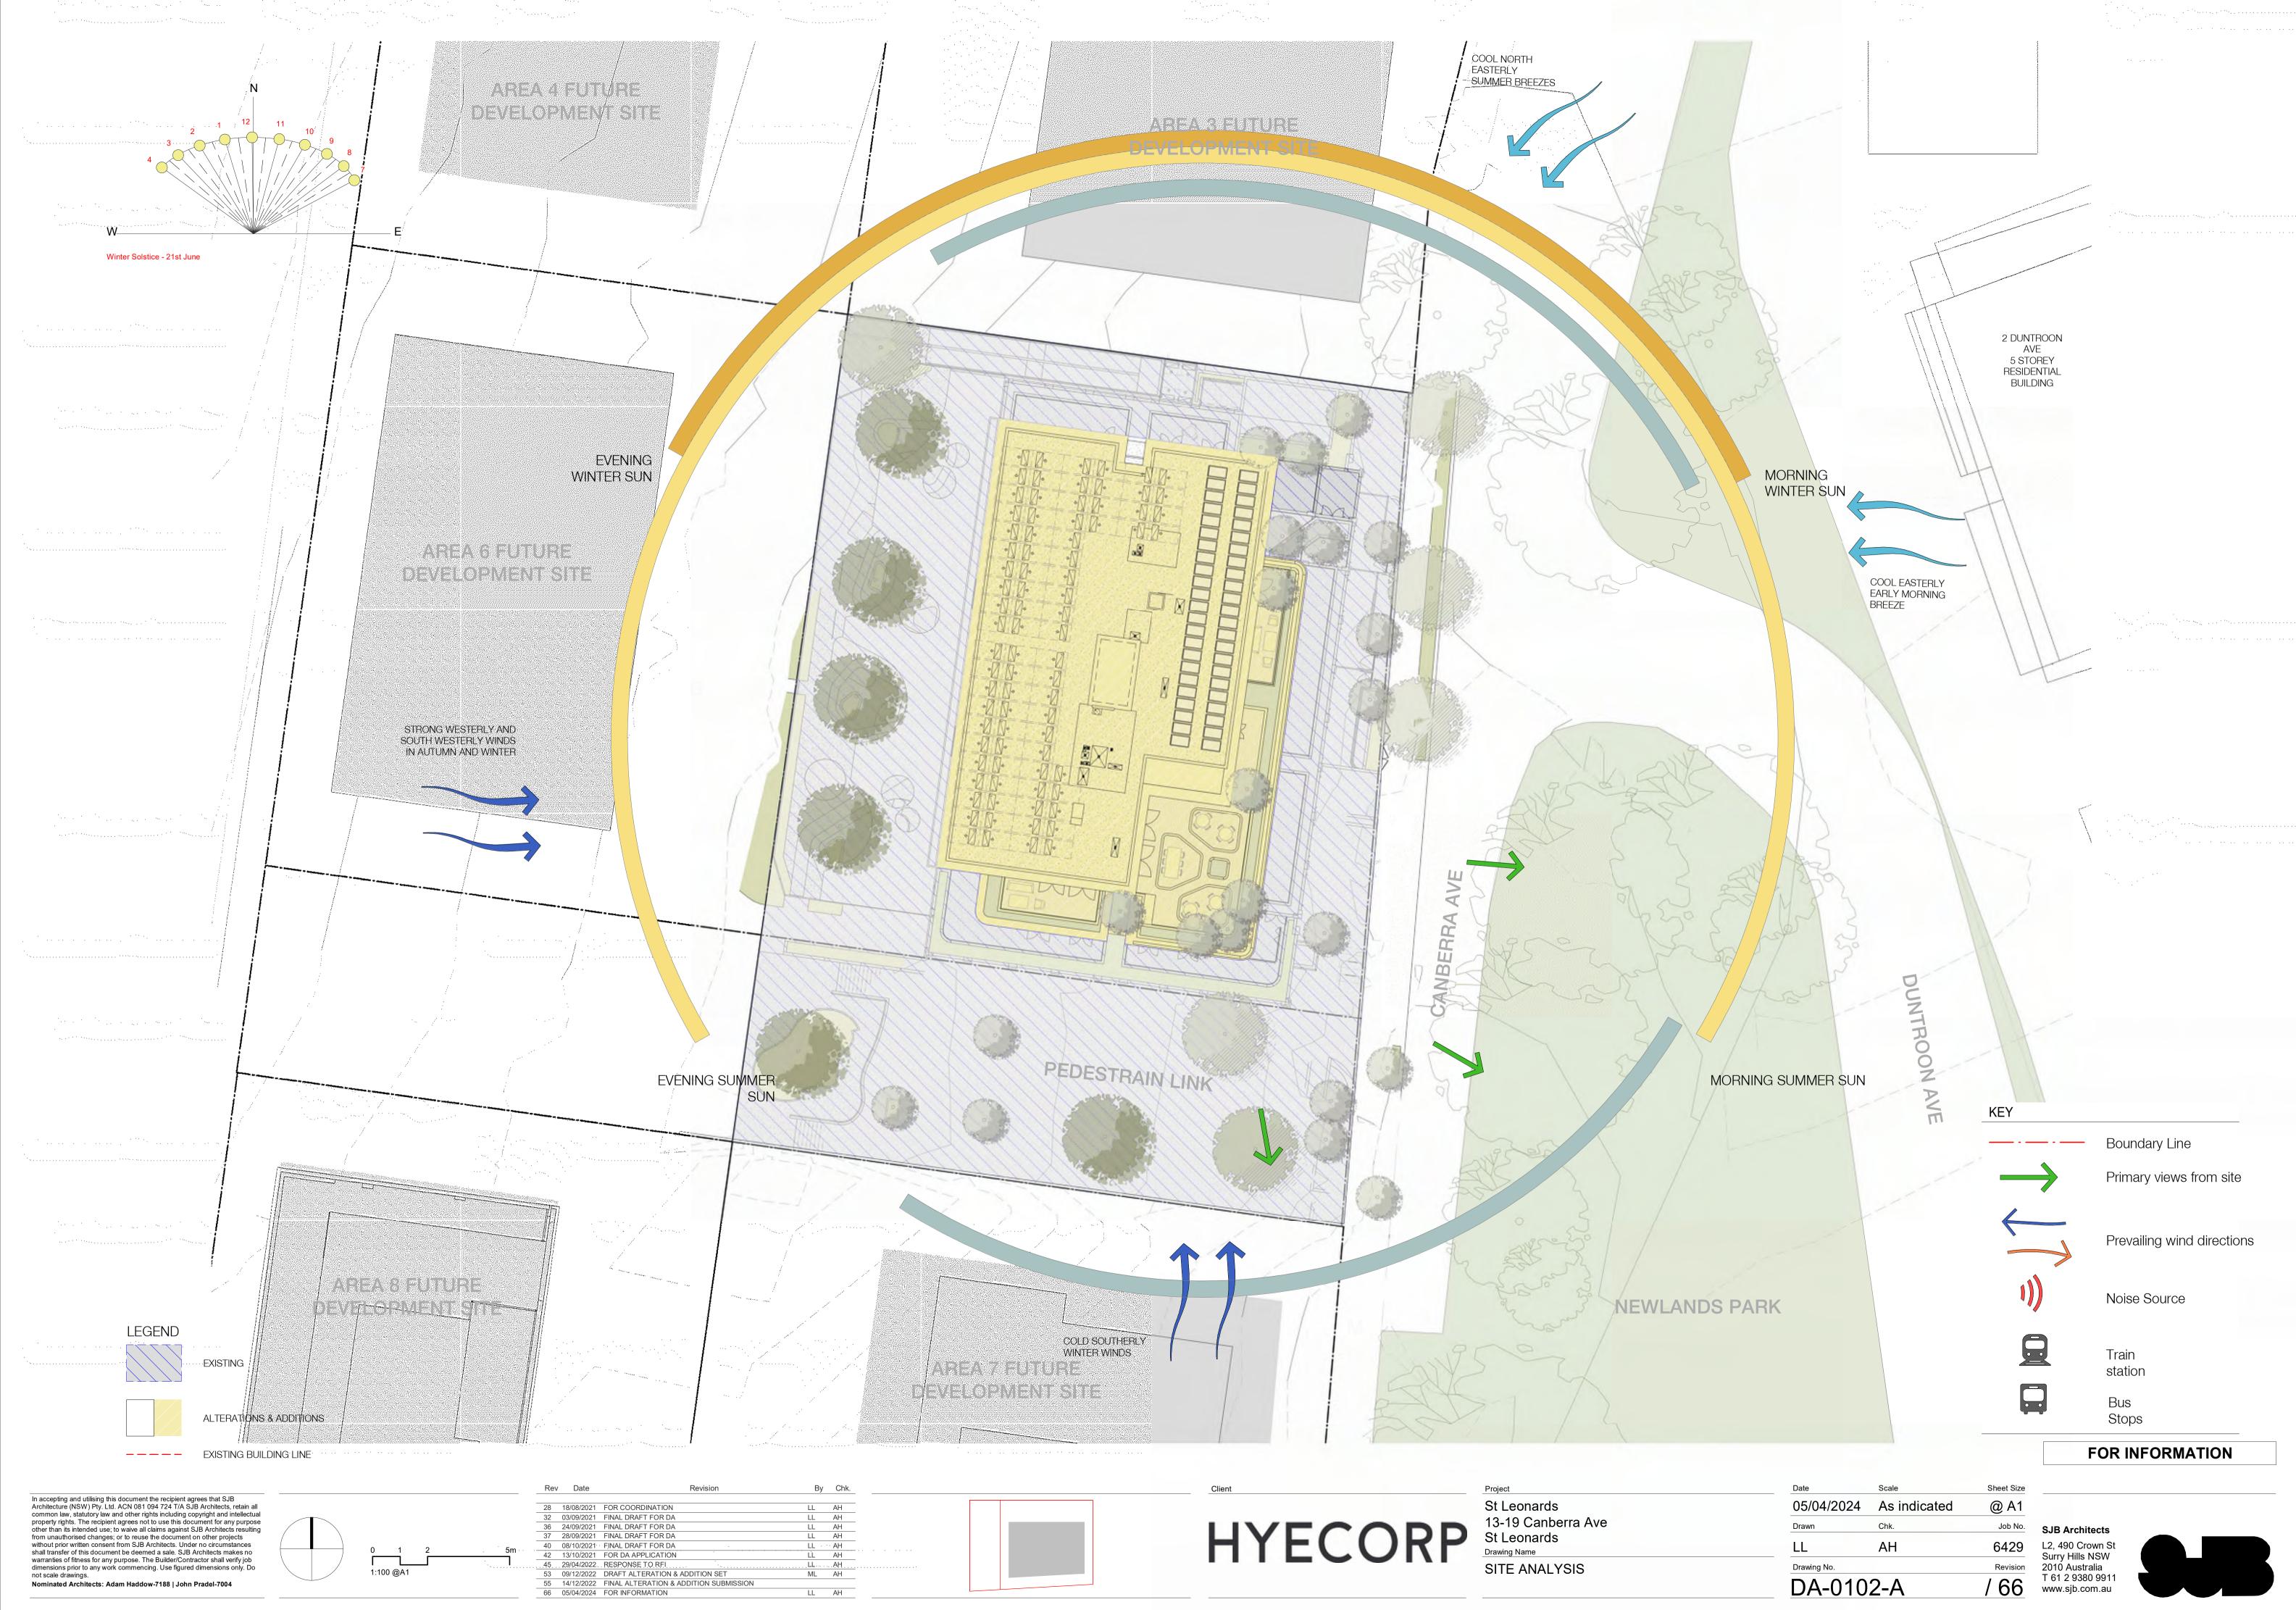


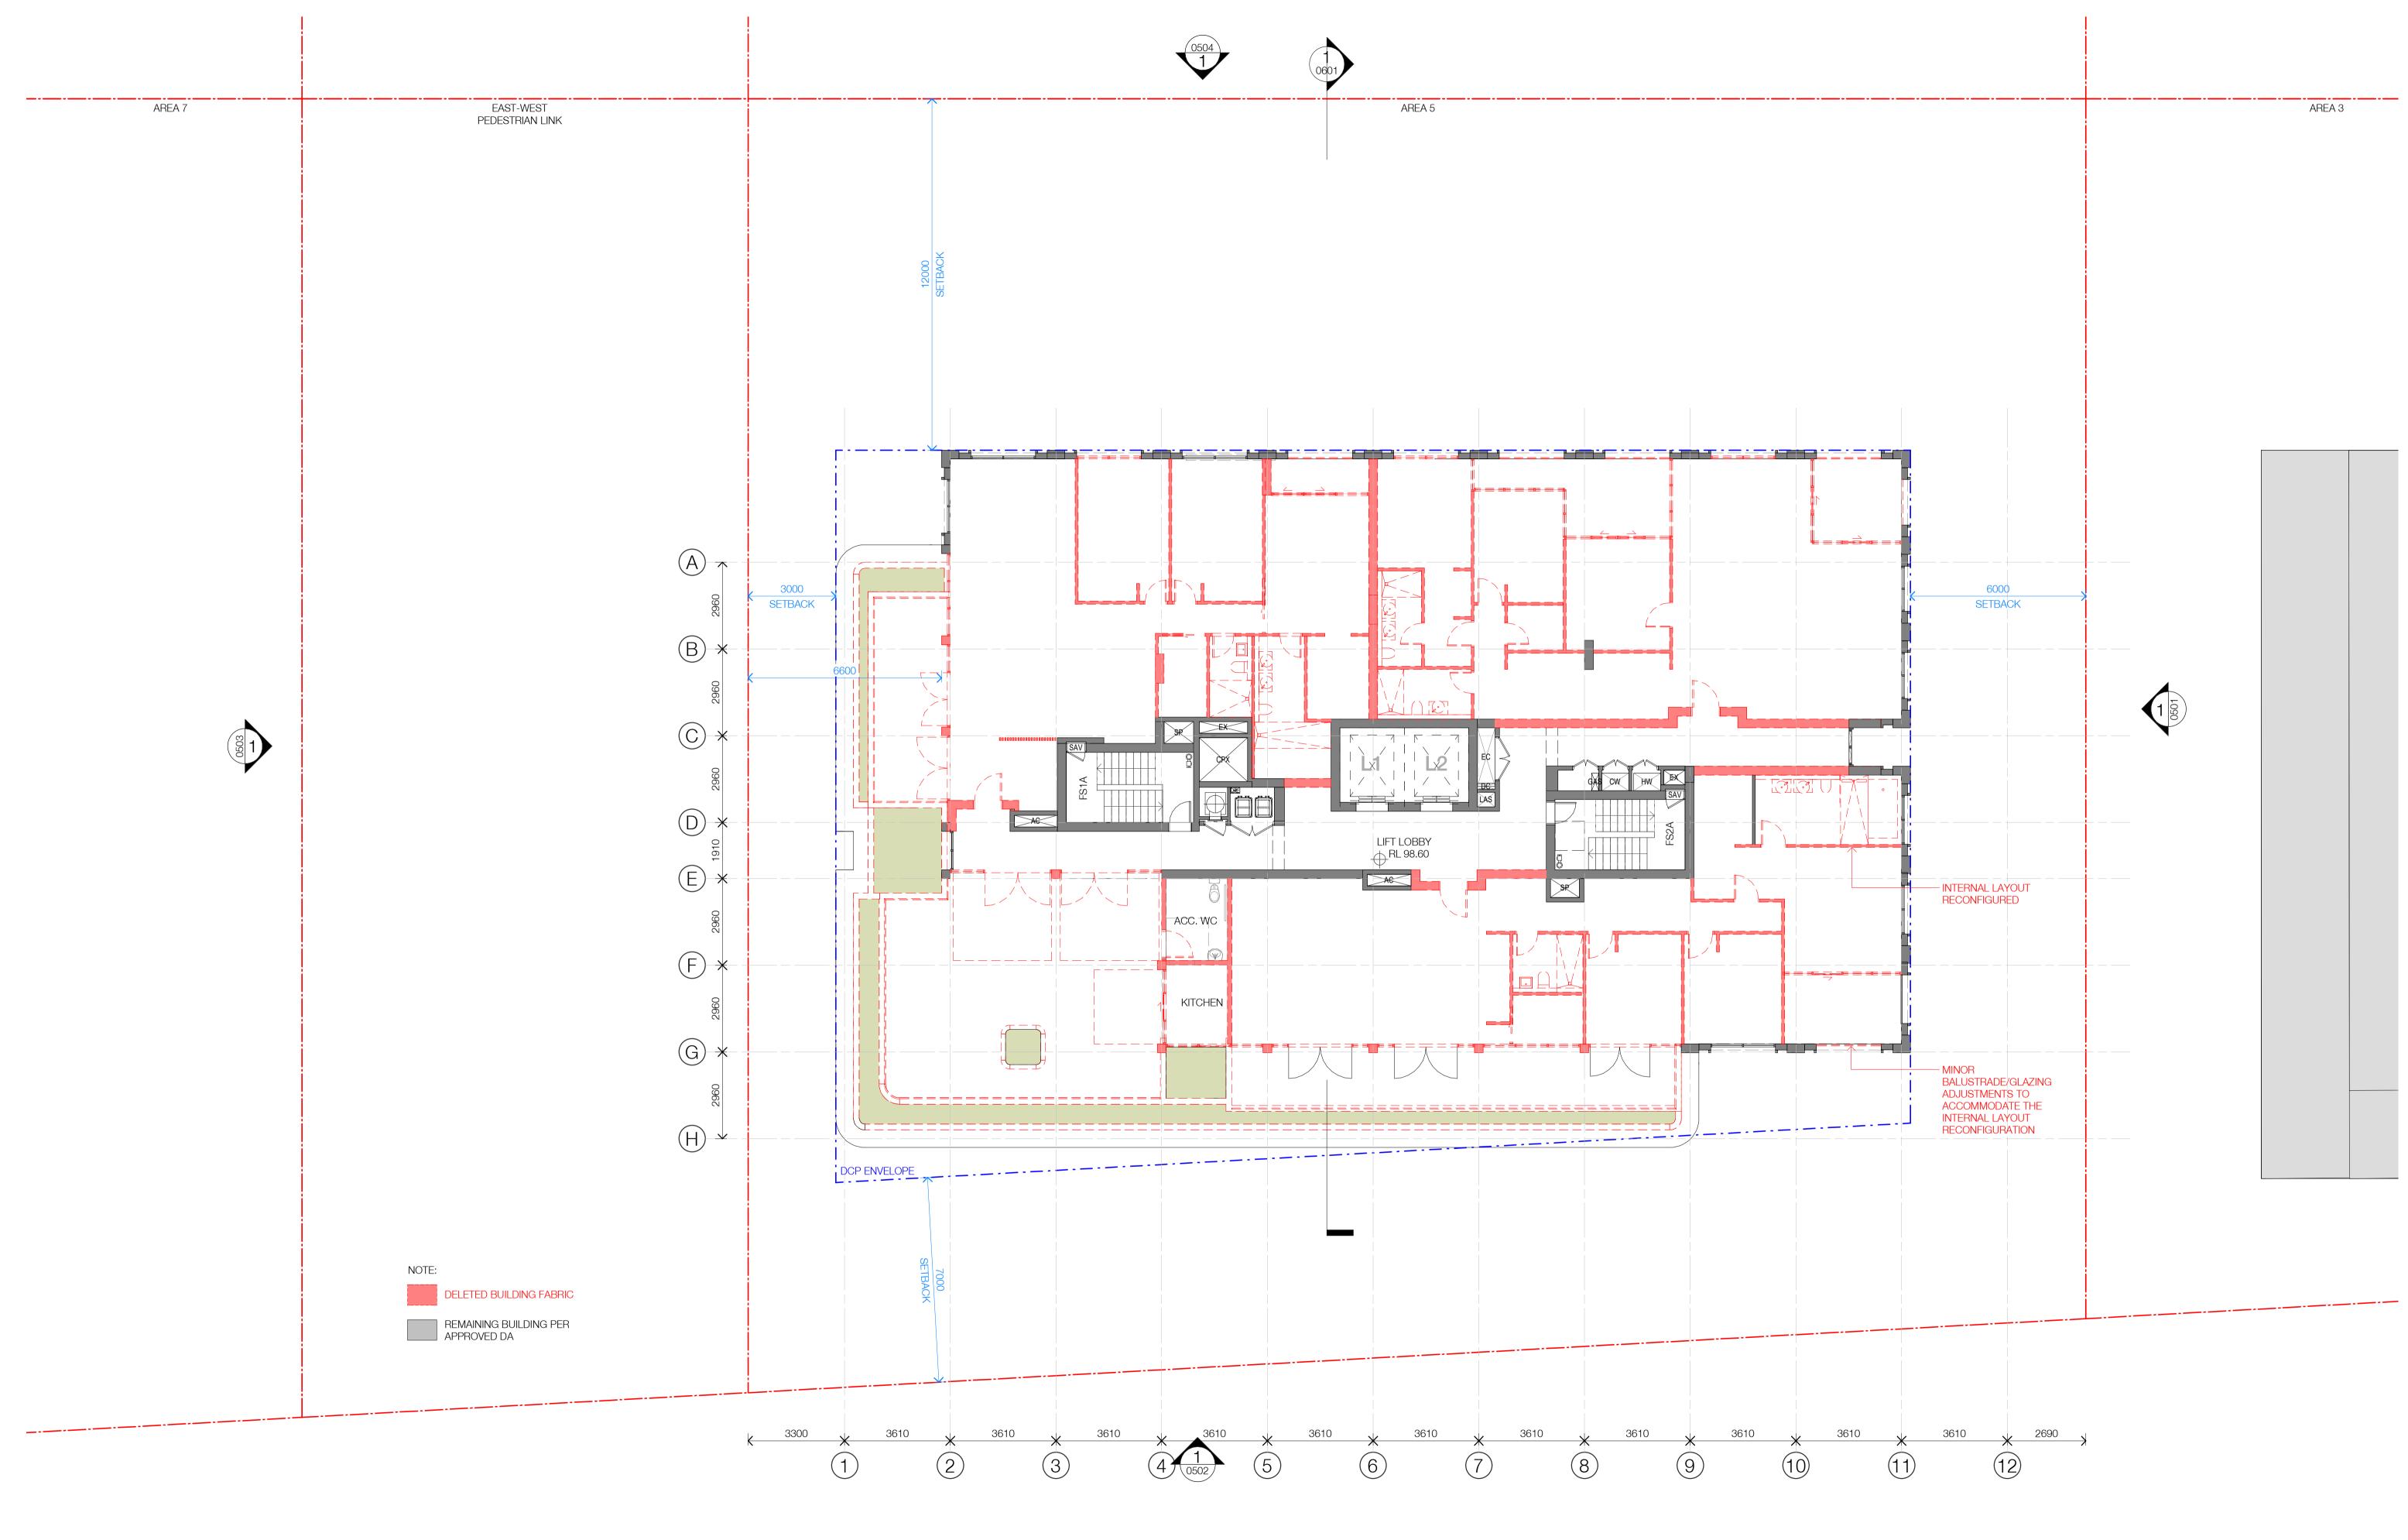


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Rev	Date	Revision	Ву	Chk.
50	26/02/2024	FOR INFORMATION	LL	AH
51	05/04/2024	FOR INFORMATION	LL	AH

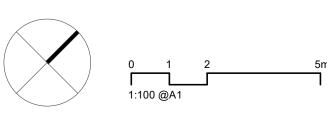

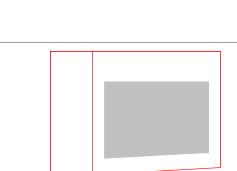


Client

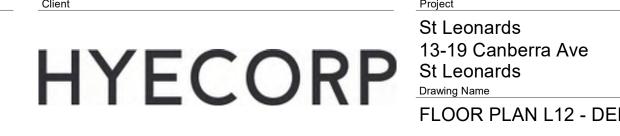Project FLOOR PLAN L12 - DELETION PLAN


Date	Scale	Sheet Size
05/04/2024	1:100	@ A1
Drawn	Chk.	Job No.
LL	AH	6429
Drawing No.		Revision
DA-021	/ 51	

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Rev	Date		Revision	By	Chk.
67	04/06/2024	FOR INFORMATION		YL	AH


FLOOR PLAN L13 - DELETION PLAN

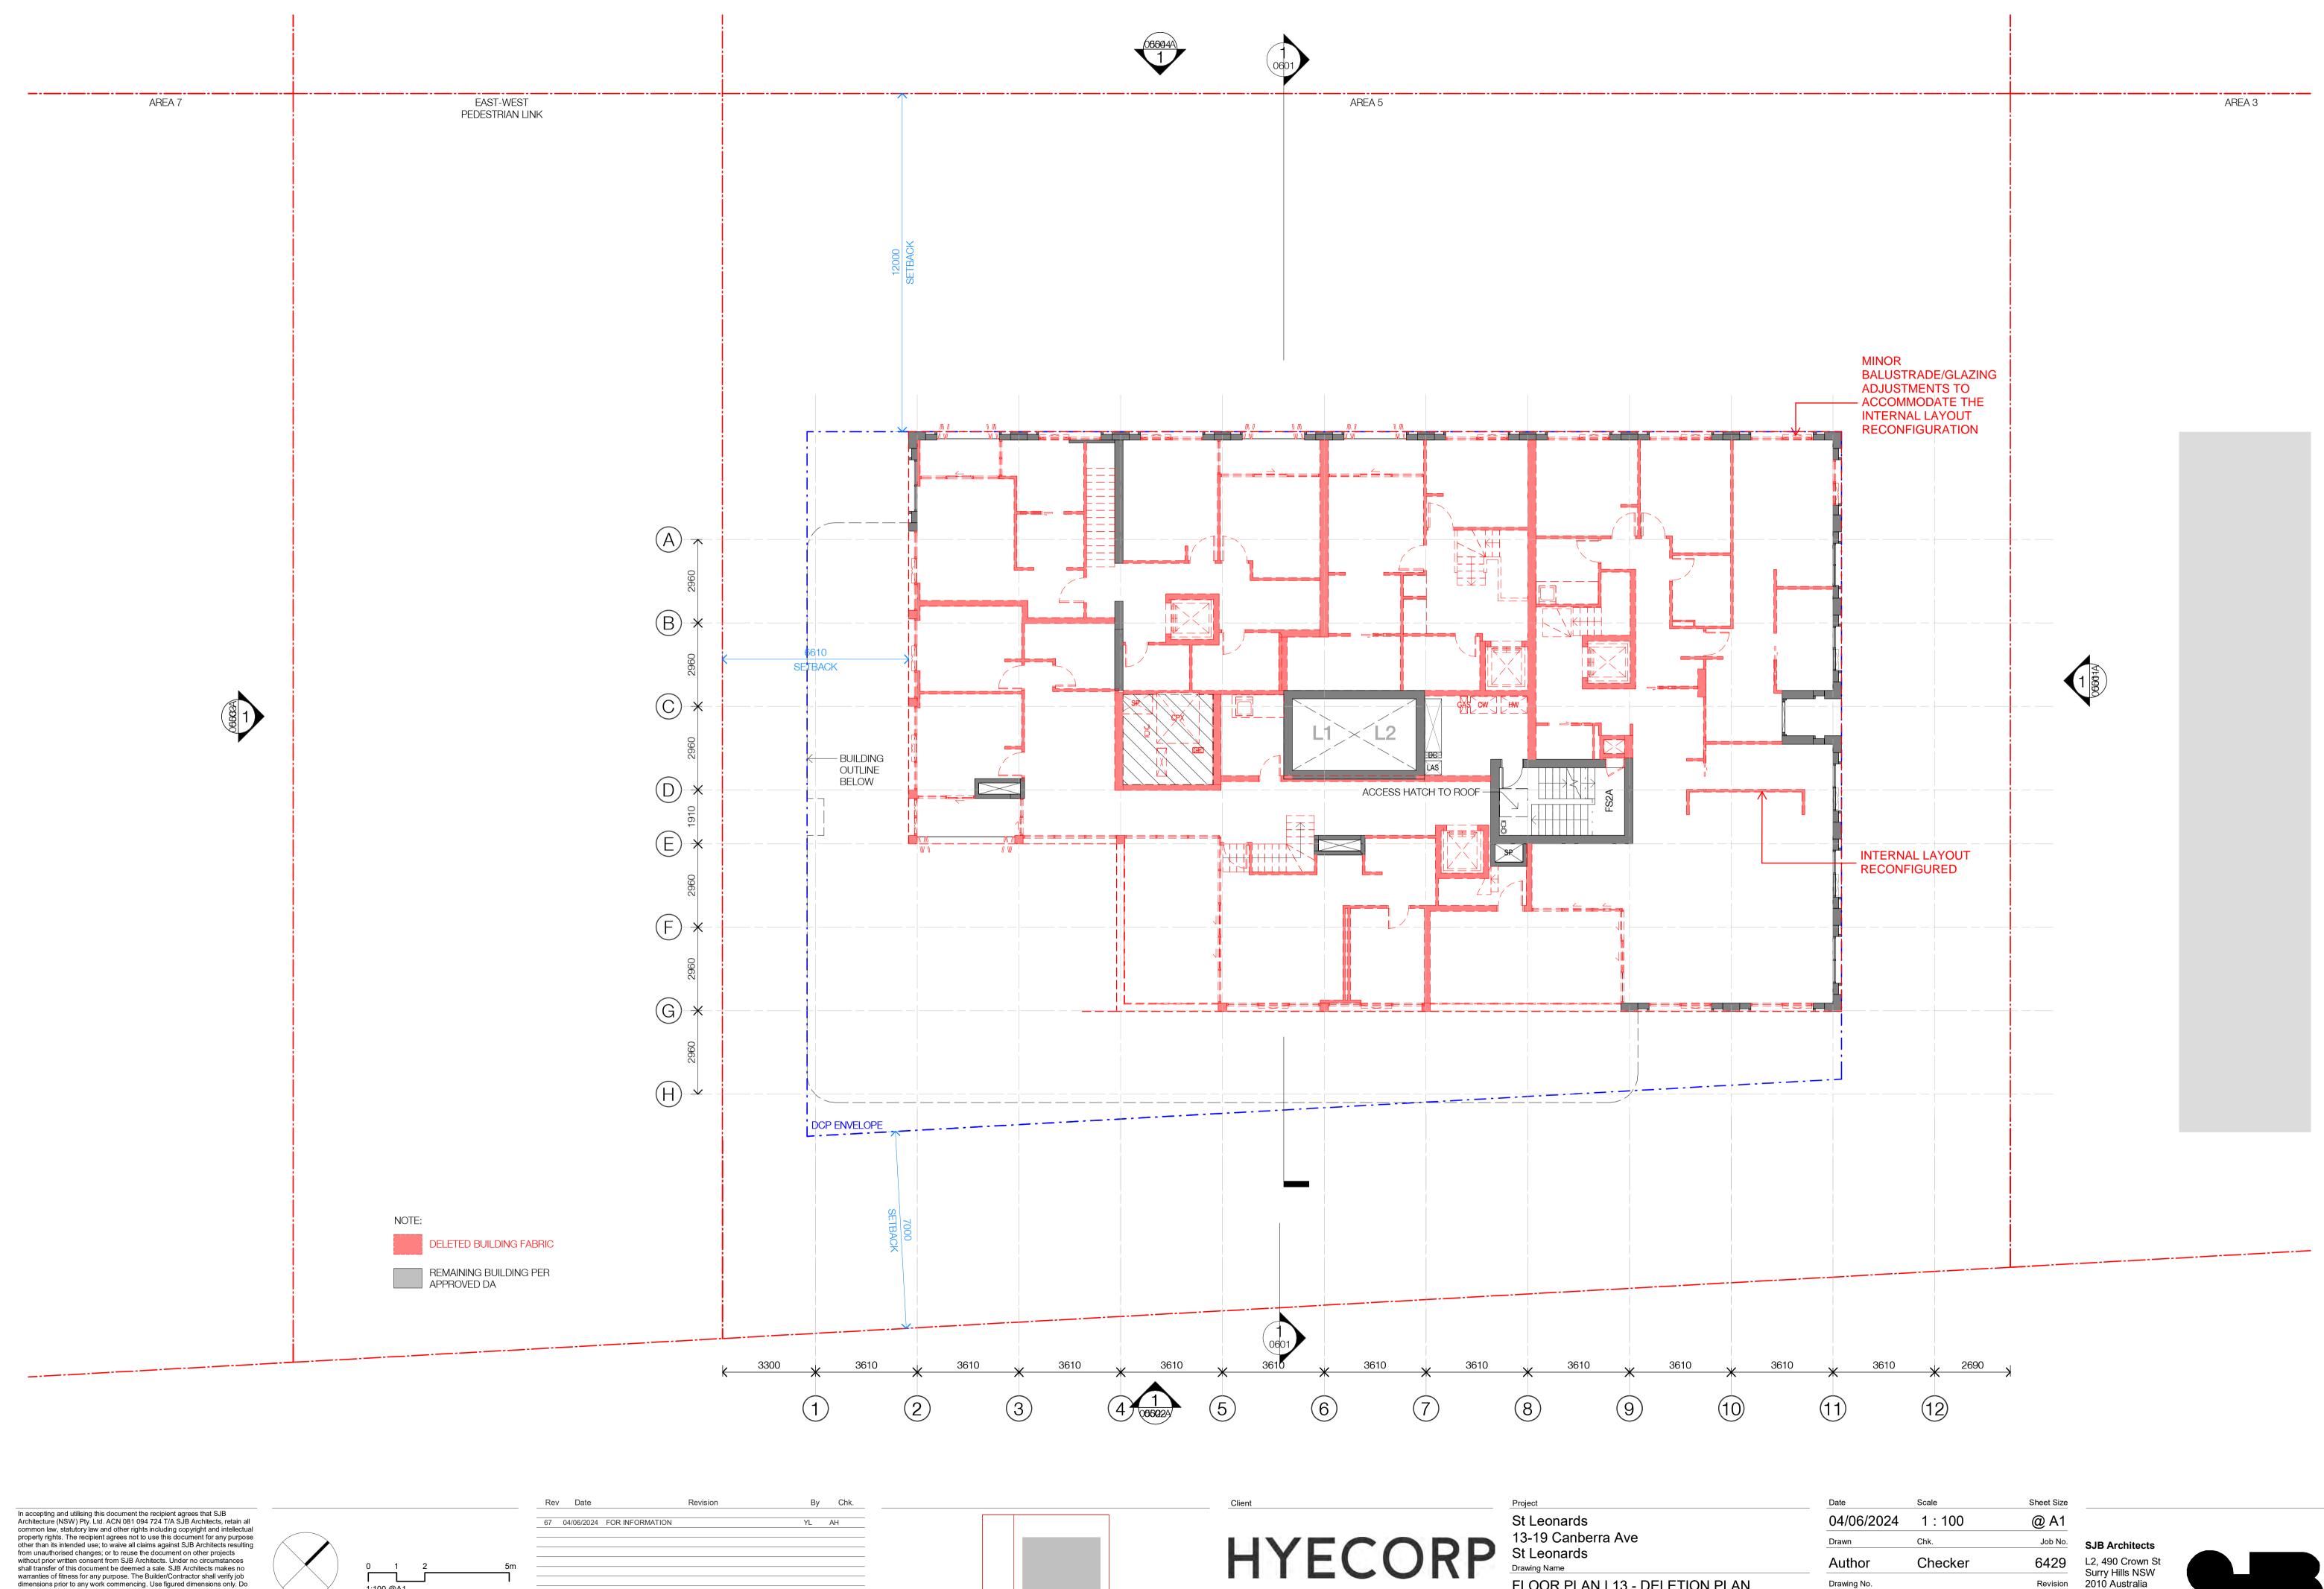Drawing No. DA-0219-D


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Rev	Date	Revision	B	y (Chk.
51	05/04/2024	FOR INFORMATION	LL	AH	

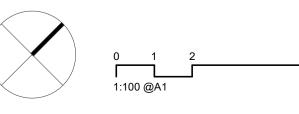05/04/2024 1 : 100 Chk. Job No. Drawn 6429 AH LL Drawing No. DA-0223-D / 51


ROOF PLAN - DELETION PLAN
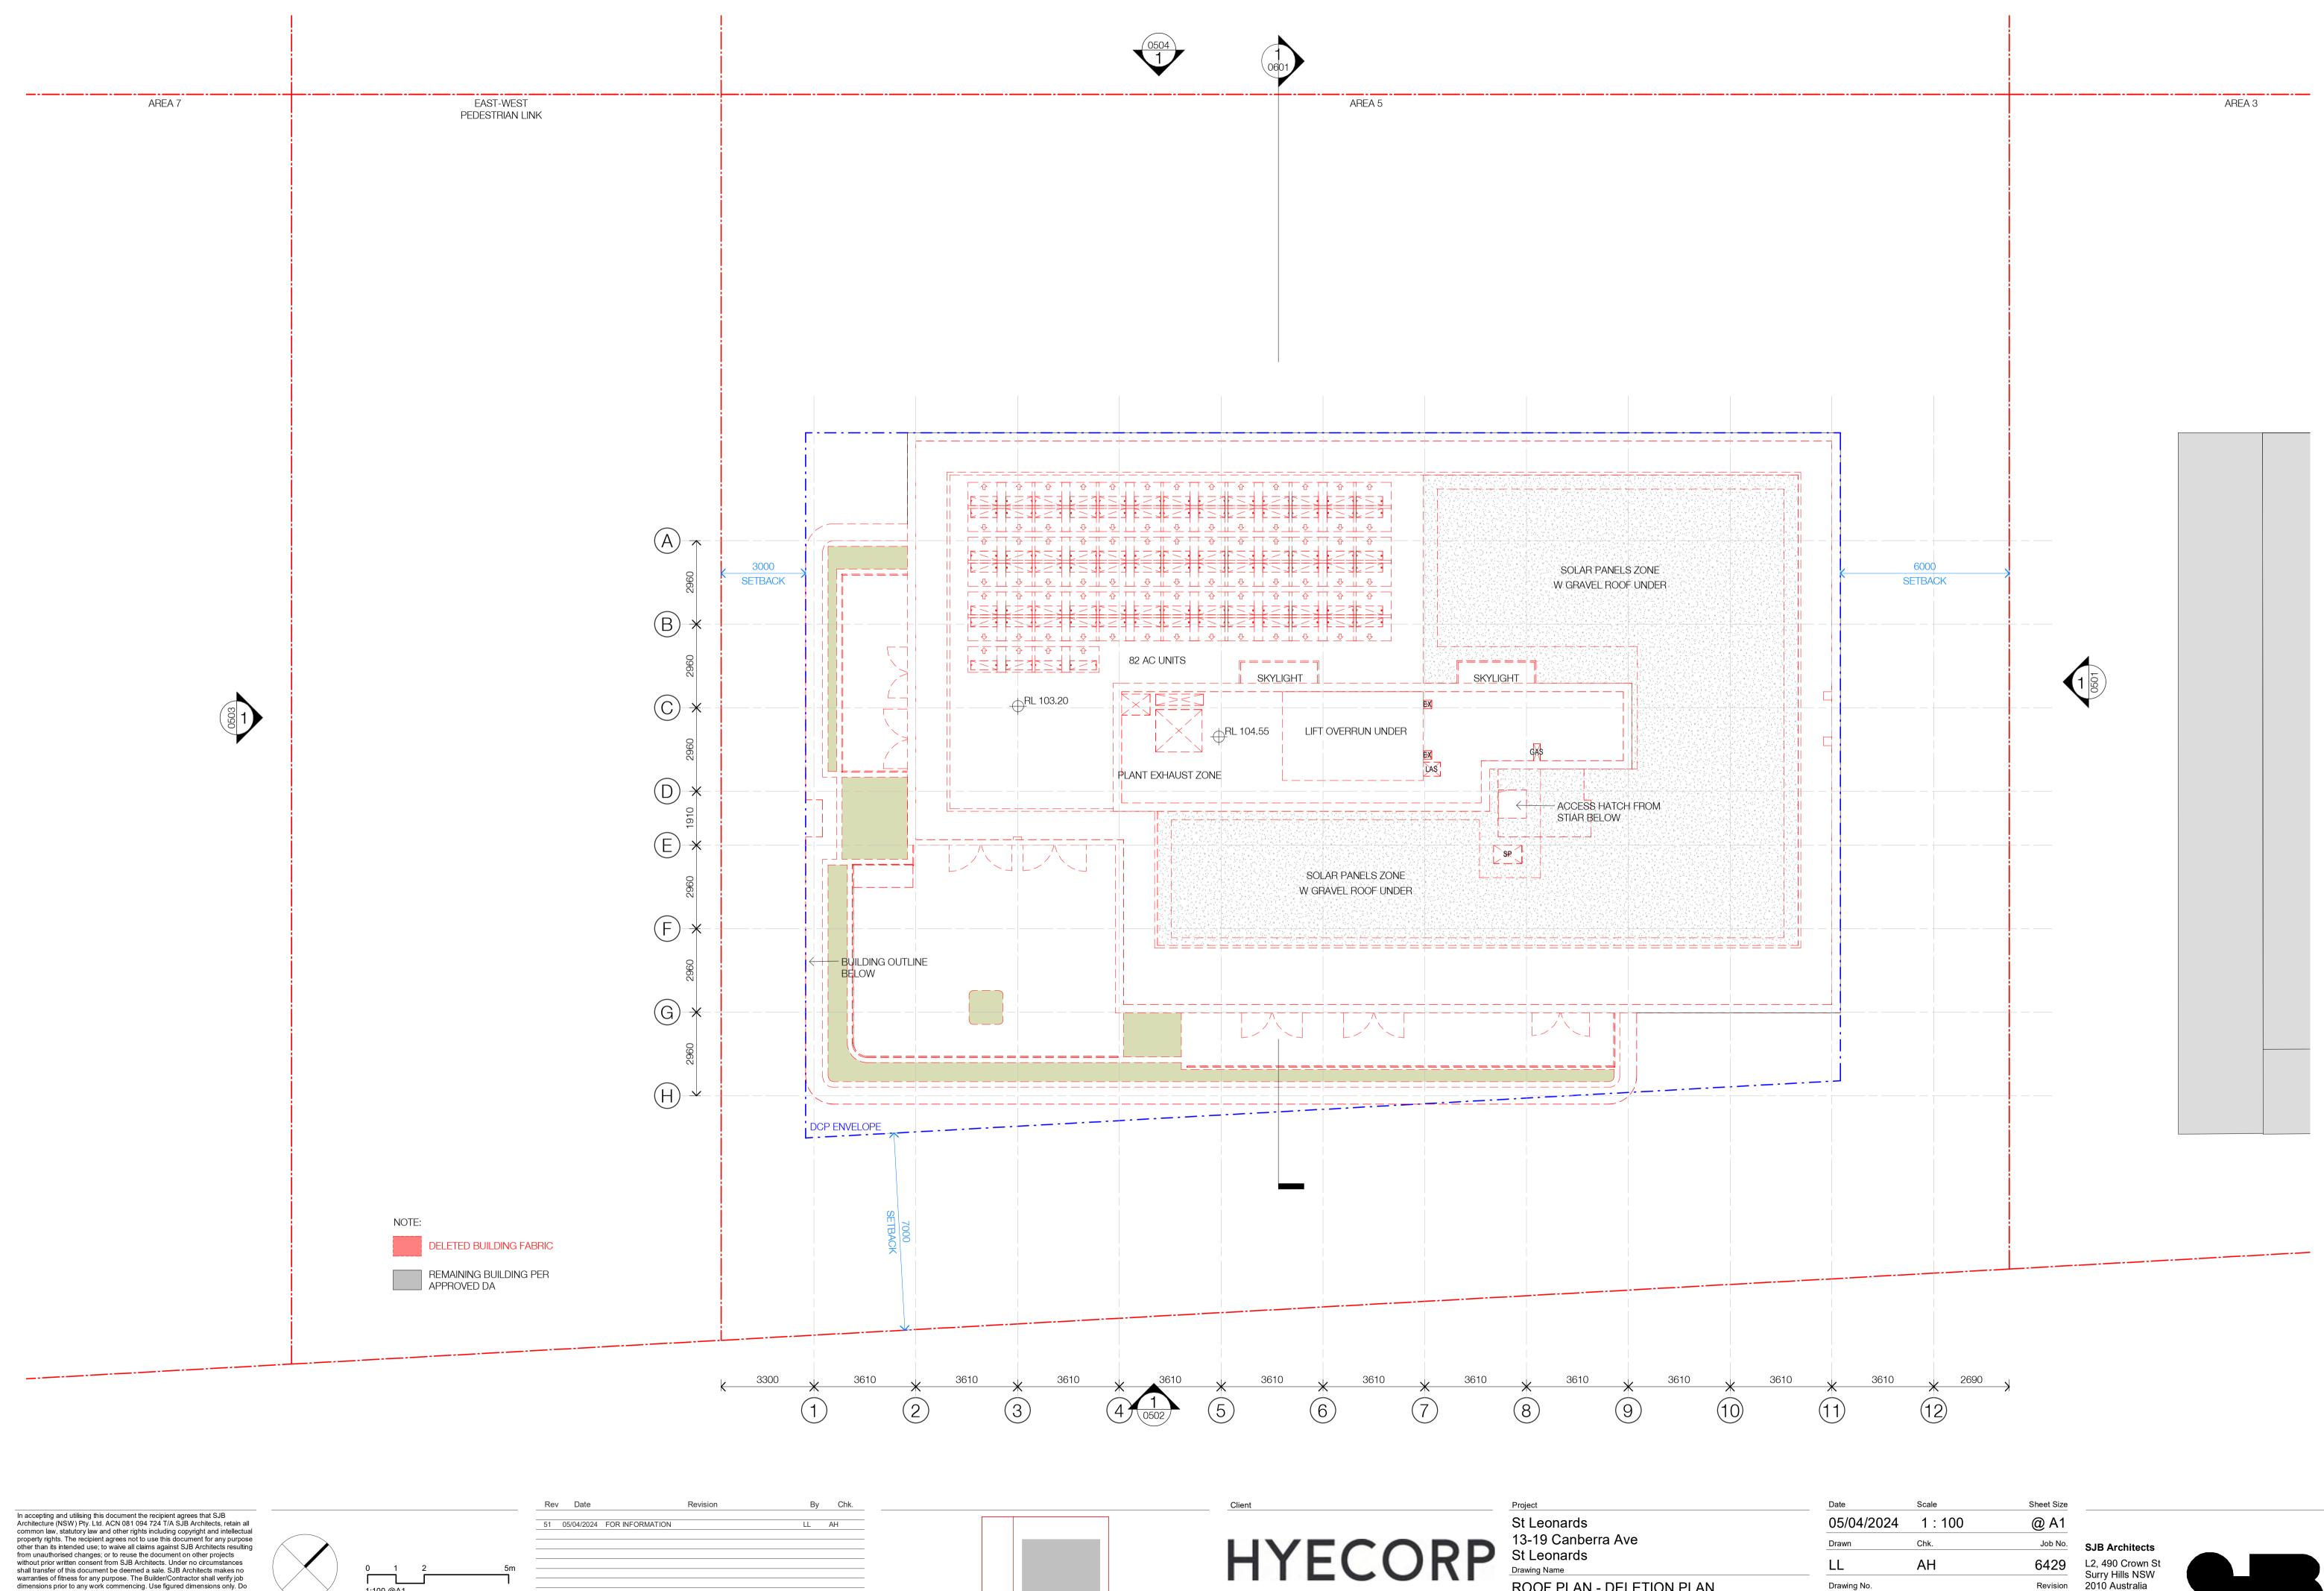
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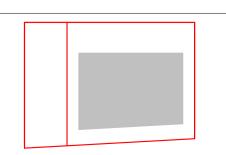


AREA 7	EAST-WEST PEDESTRIAN LINK	0960 3360 Total and a second
	DEEP SOIL ZONE	
	CAR PARKING SCHEDULETYPECOUNTBASEMENT 4RESIDENTIALRESIDENTIAL 2SRESIDENTIAL ACCESSIBLE734BASEMENT 3RESIDENTIAL 2RESIDENTIAL 26RESIDENTIAL ACCESSIBLE735	
	BASEMENT 2 RESIDENTIAL 2 RESIDENTIAL 2 4 RESIDENTIAL ACCESSIBLE 6 RETAIL ACCESSIBLE 1 VISITOR PARKING 1 35 BASEMENT 1 CHILDCARE 9 CHILDCARE ACCESSIBLE 1 CHILDCARE STAFF 7 SHARED 2 VISITOR ACCESSIBLE 2	C * UPPS 3000 - OIL SEPERATOR 0962 KPPS 3000 - OIL SEPERATOR 0161 E * UPPS 3000 - OIL SEPERATOR 0161 C * UPPS 3000 -
	VISITOR PARKING 14 35 Grand total 139 BICYCLE PARKING SCHEDULE TYPE LEVEL COUNT	
	BIKE PARKING - RESIDENTBASEMENT 24BIKE PARKING - RESIDENTBASEMENT 123BIKE PARKING - VISITORGROUND FLOOR83535Grand total35MOTORBIKE PARKING SCHEDULETYPELEVELCOUNT	2960 × 2960 × 2960
LEGEND	MOTORCYCLEMOTORBIKE 1200X2500BASEMENT 33MOTORBIKE 1200X2500BASEMENT 271010Grand total10	
		(1)
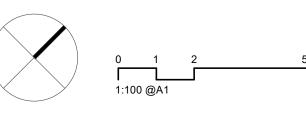
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Rev	Date		Revision	Ву	Chk.
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FLOOR PLAN B4

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Project

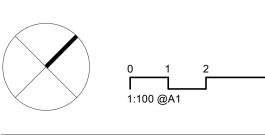


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DEEP SOIL ZONE


AREA 5

1 DA-0601

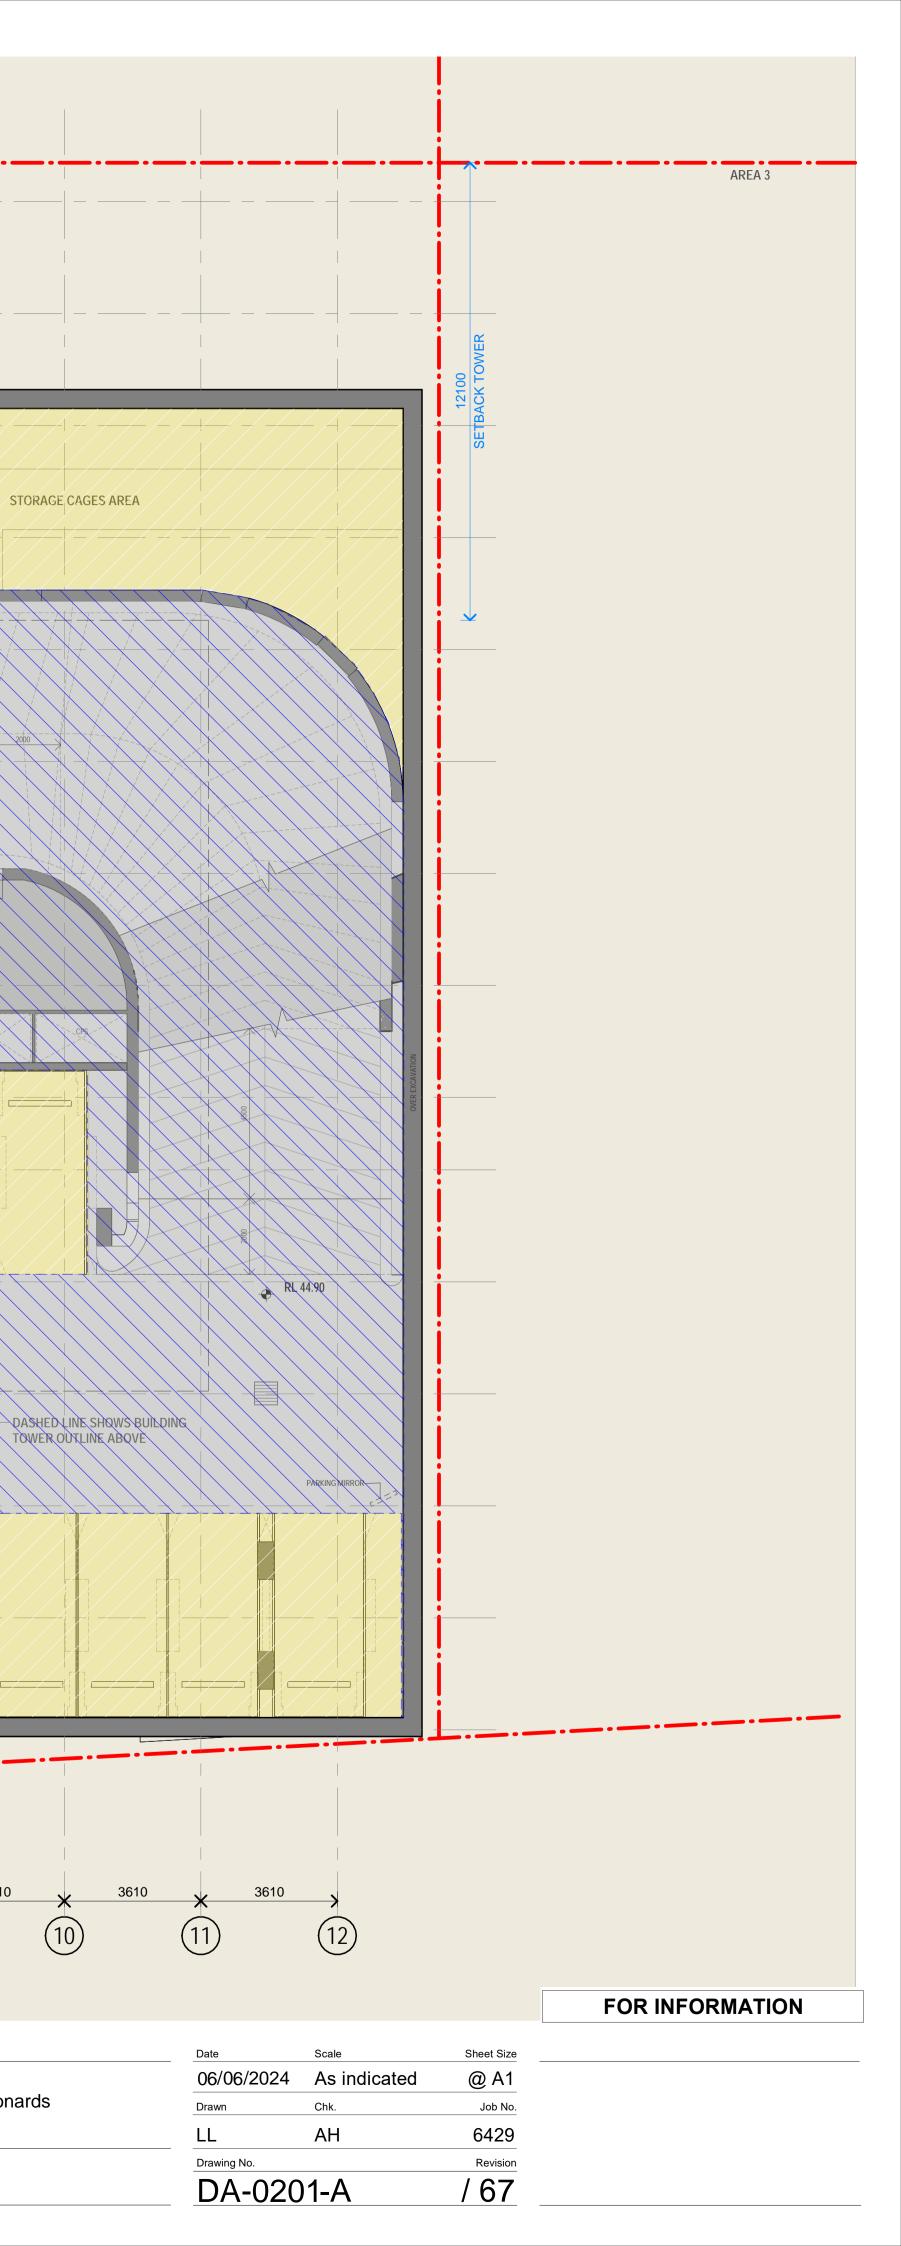


AREA 7	EAST-WEST PEDESTRIAN LINK	EE * 0960 DD * 0965	AREA 5
	DEEP SOIL ZONE	CC * 0962 BB * 0965	
	CAR PARKING SCHEDULETYPECOUNTBASEMENT 4RESIDENTIALRESIDENTIAL 2RESIDENTIAL ACCESSIBLE734BASEMENT 3RESIDENTIAL22	AA * 0960 5360	
	RESIDENTIAL 26RESIDENTIAL ACCESSIBLE735BASEMENT 2RESIDENTIAL23RESIDENTIAL 24RESIDENTIAL ACCESSIBLE6RETAIL ACCESSIBLE1VISITOR PARKING135	KPPS3000 - OIL SEPERATOR	
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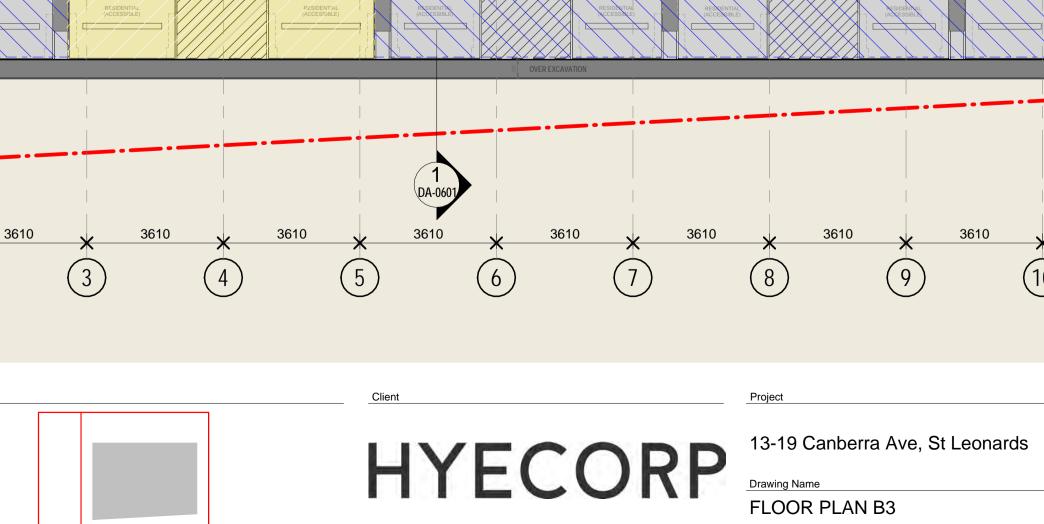
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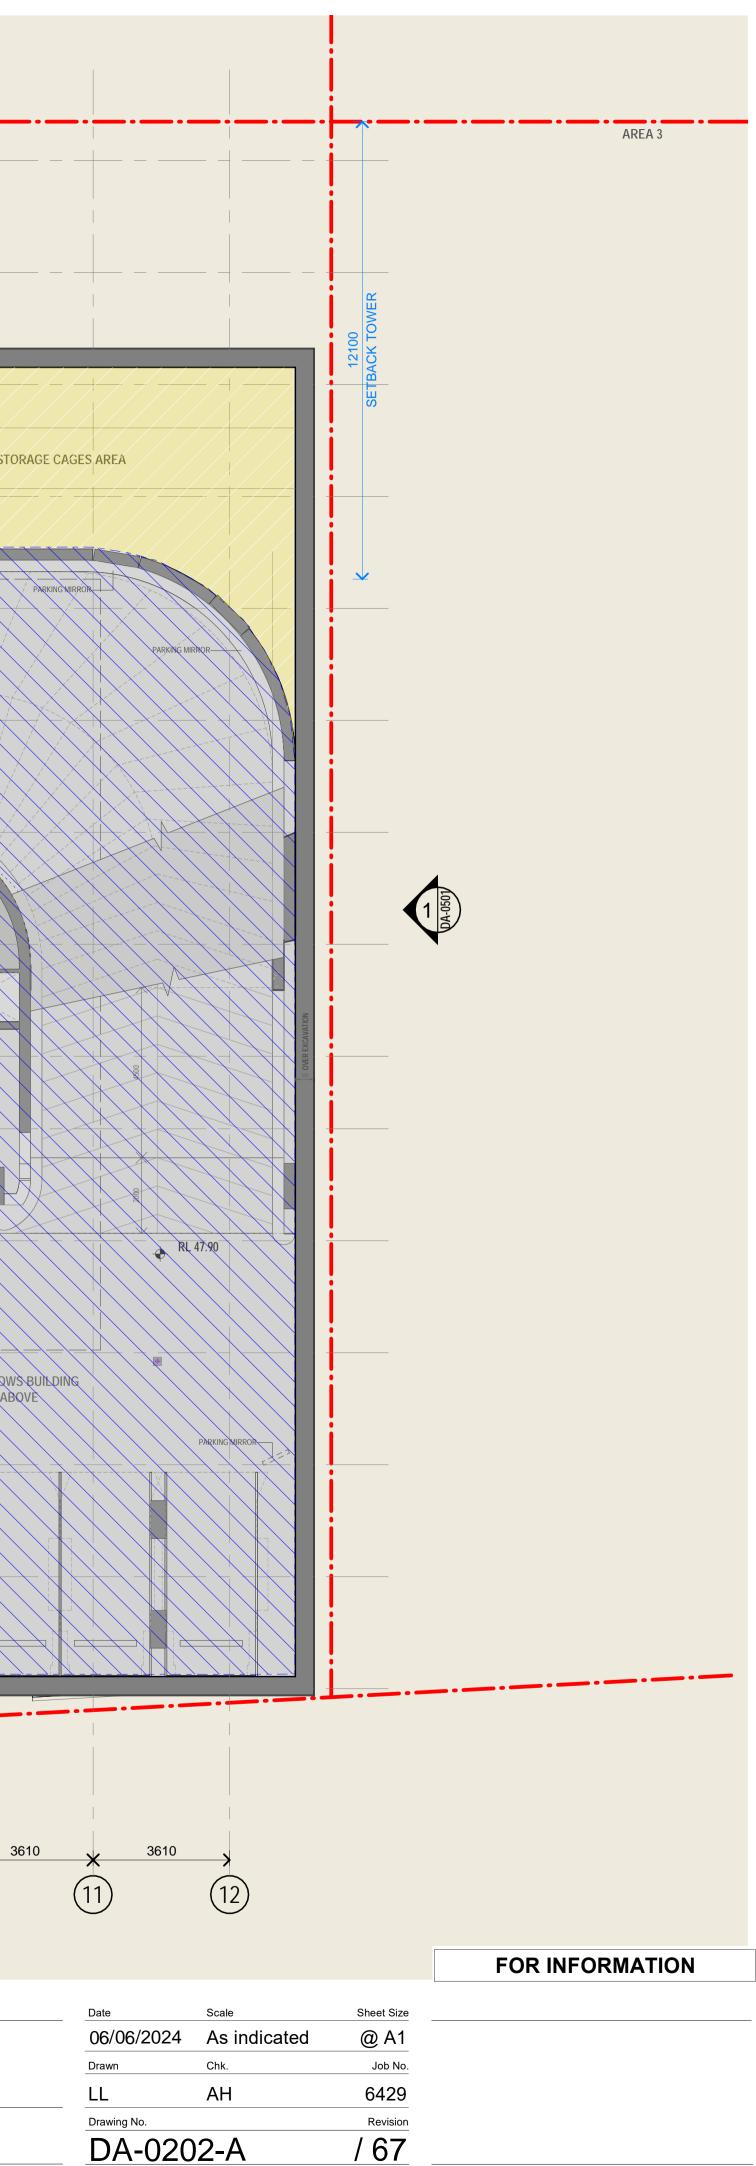
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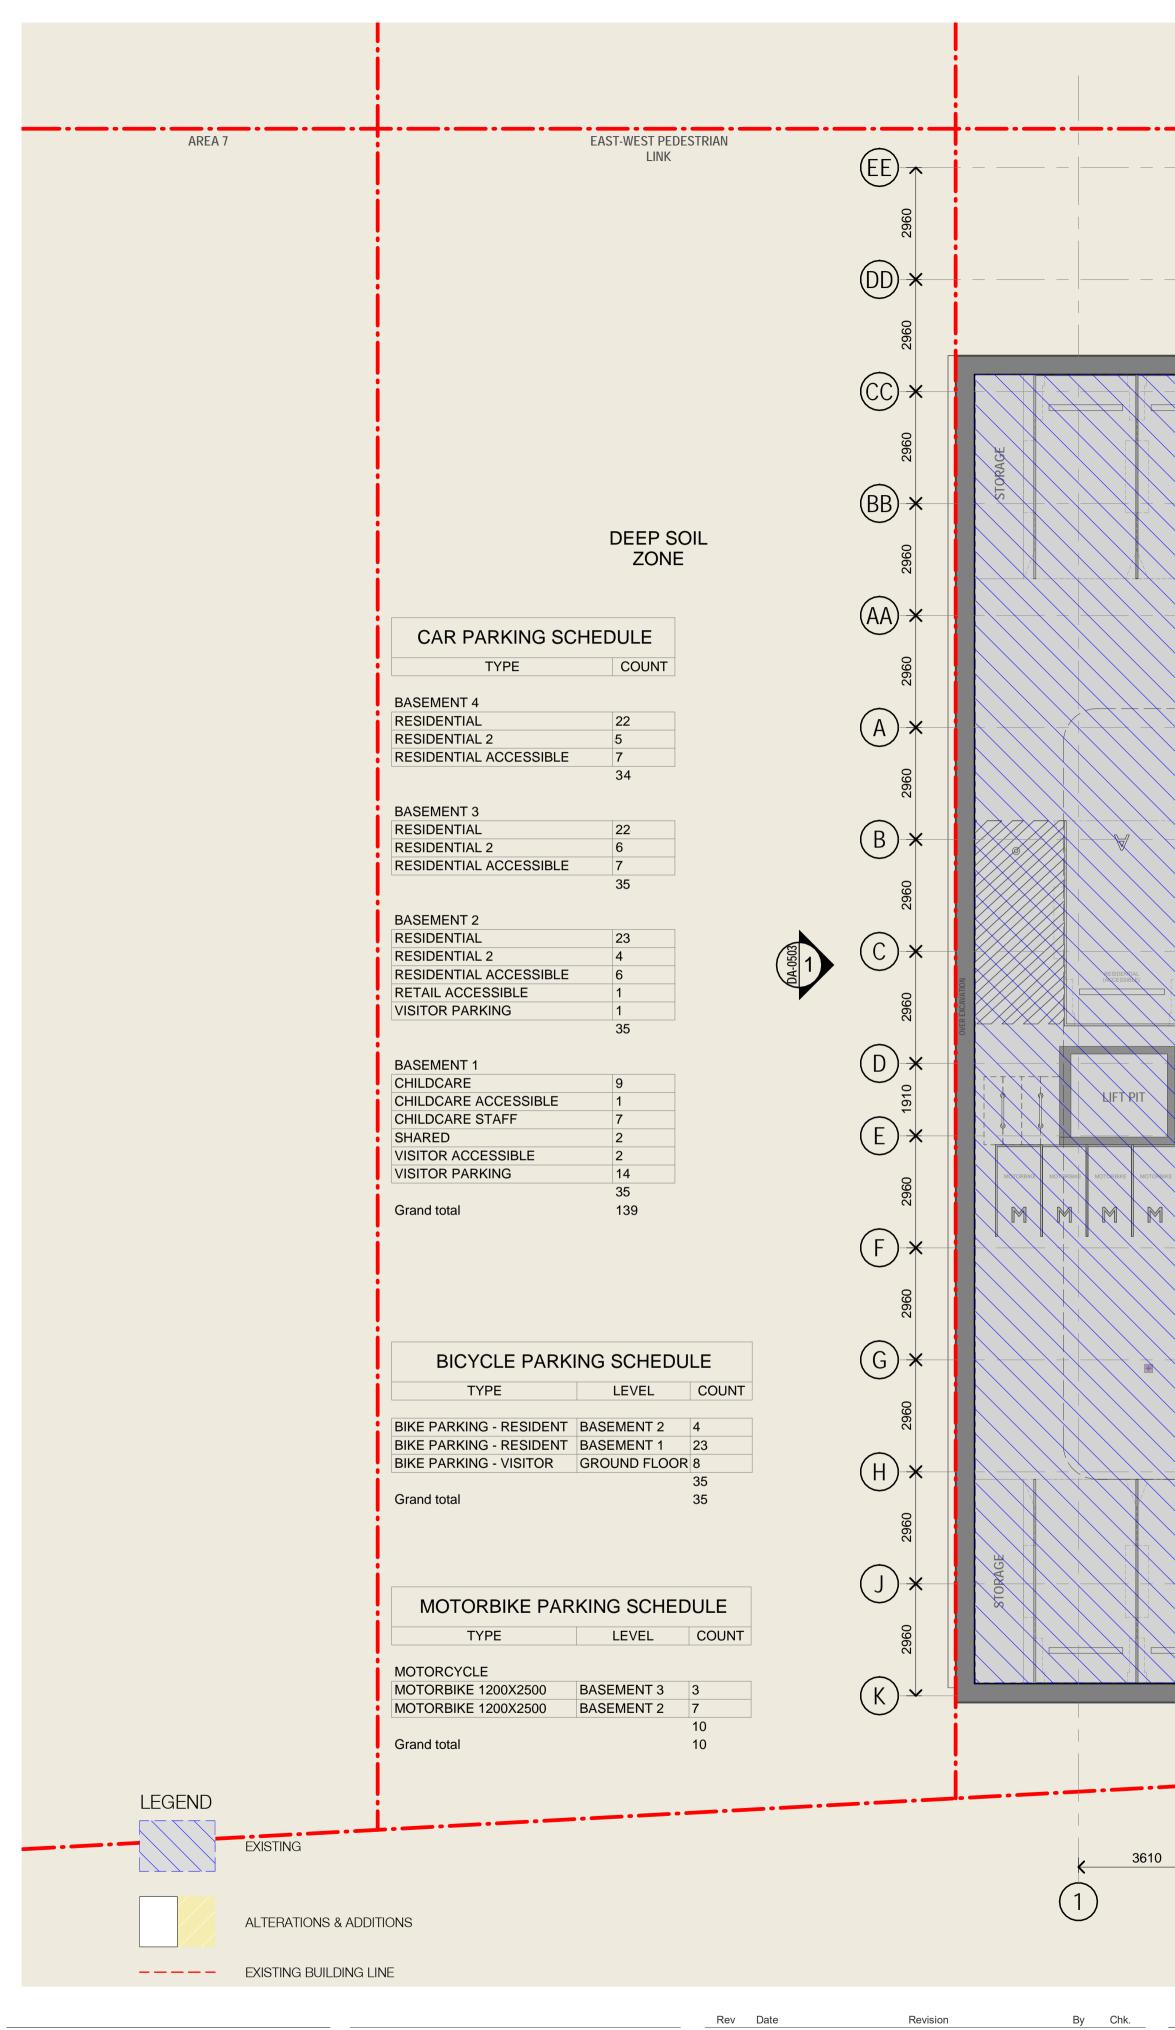




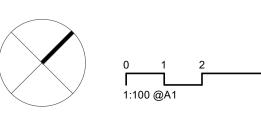


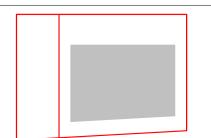


DA-0202-A



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	Project
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LURP	Drawing Name

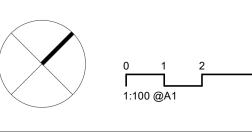

Drawing Name	
FLOOR PLAN B2	
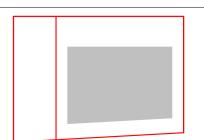
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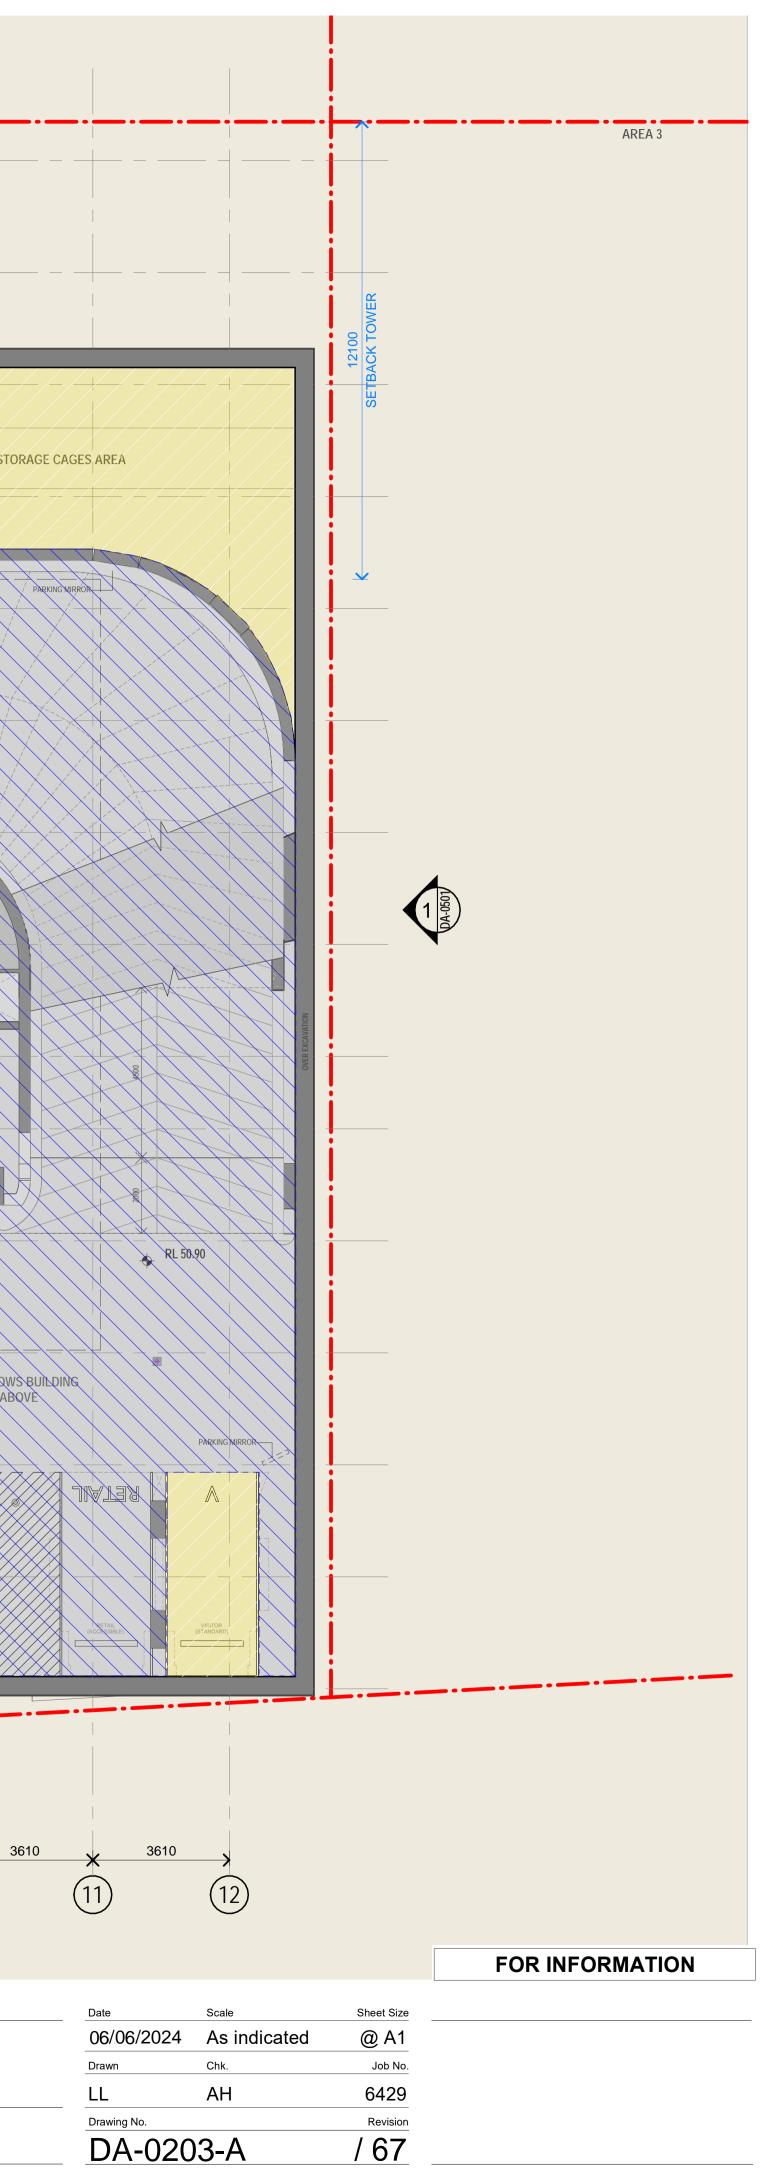
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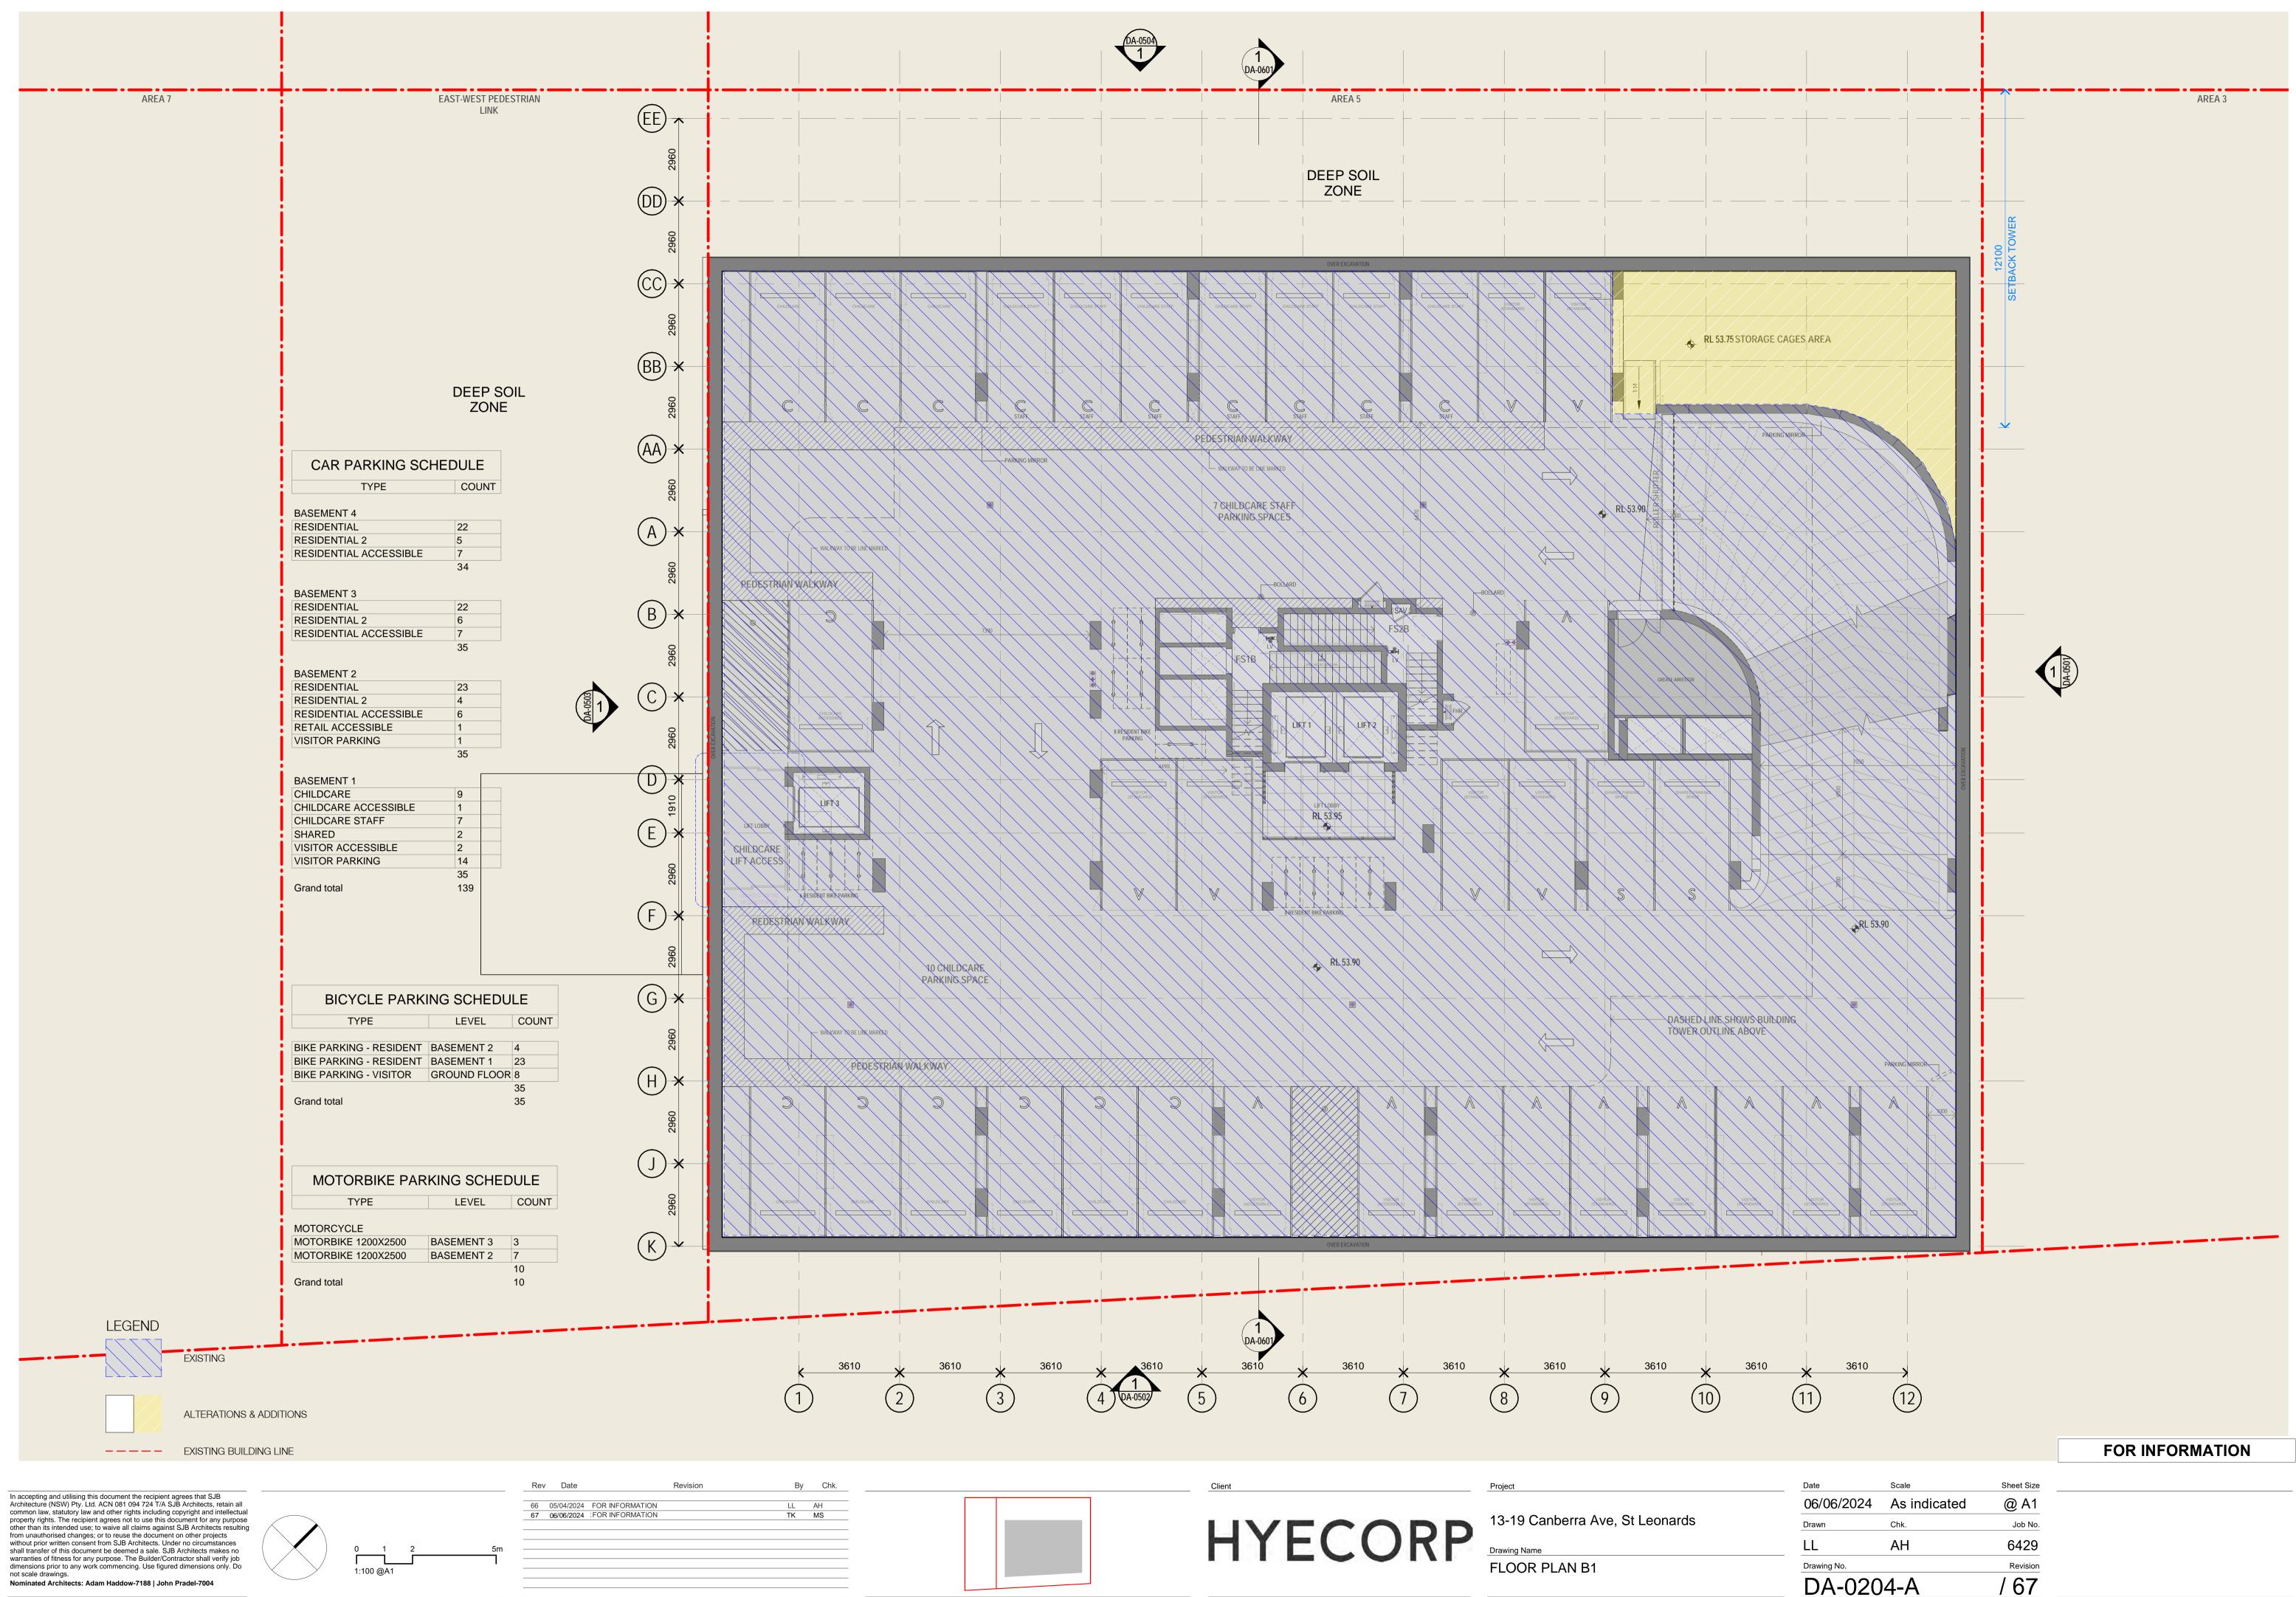
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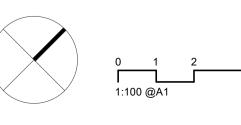
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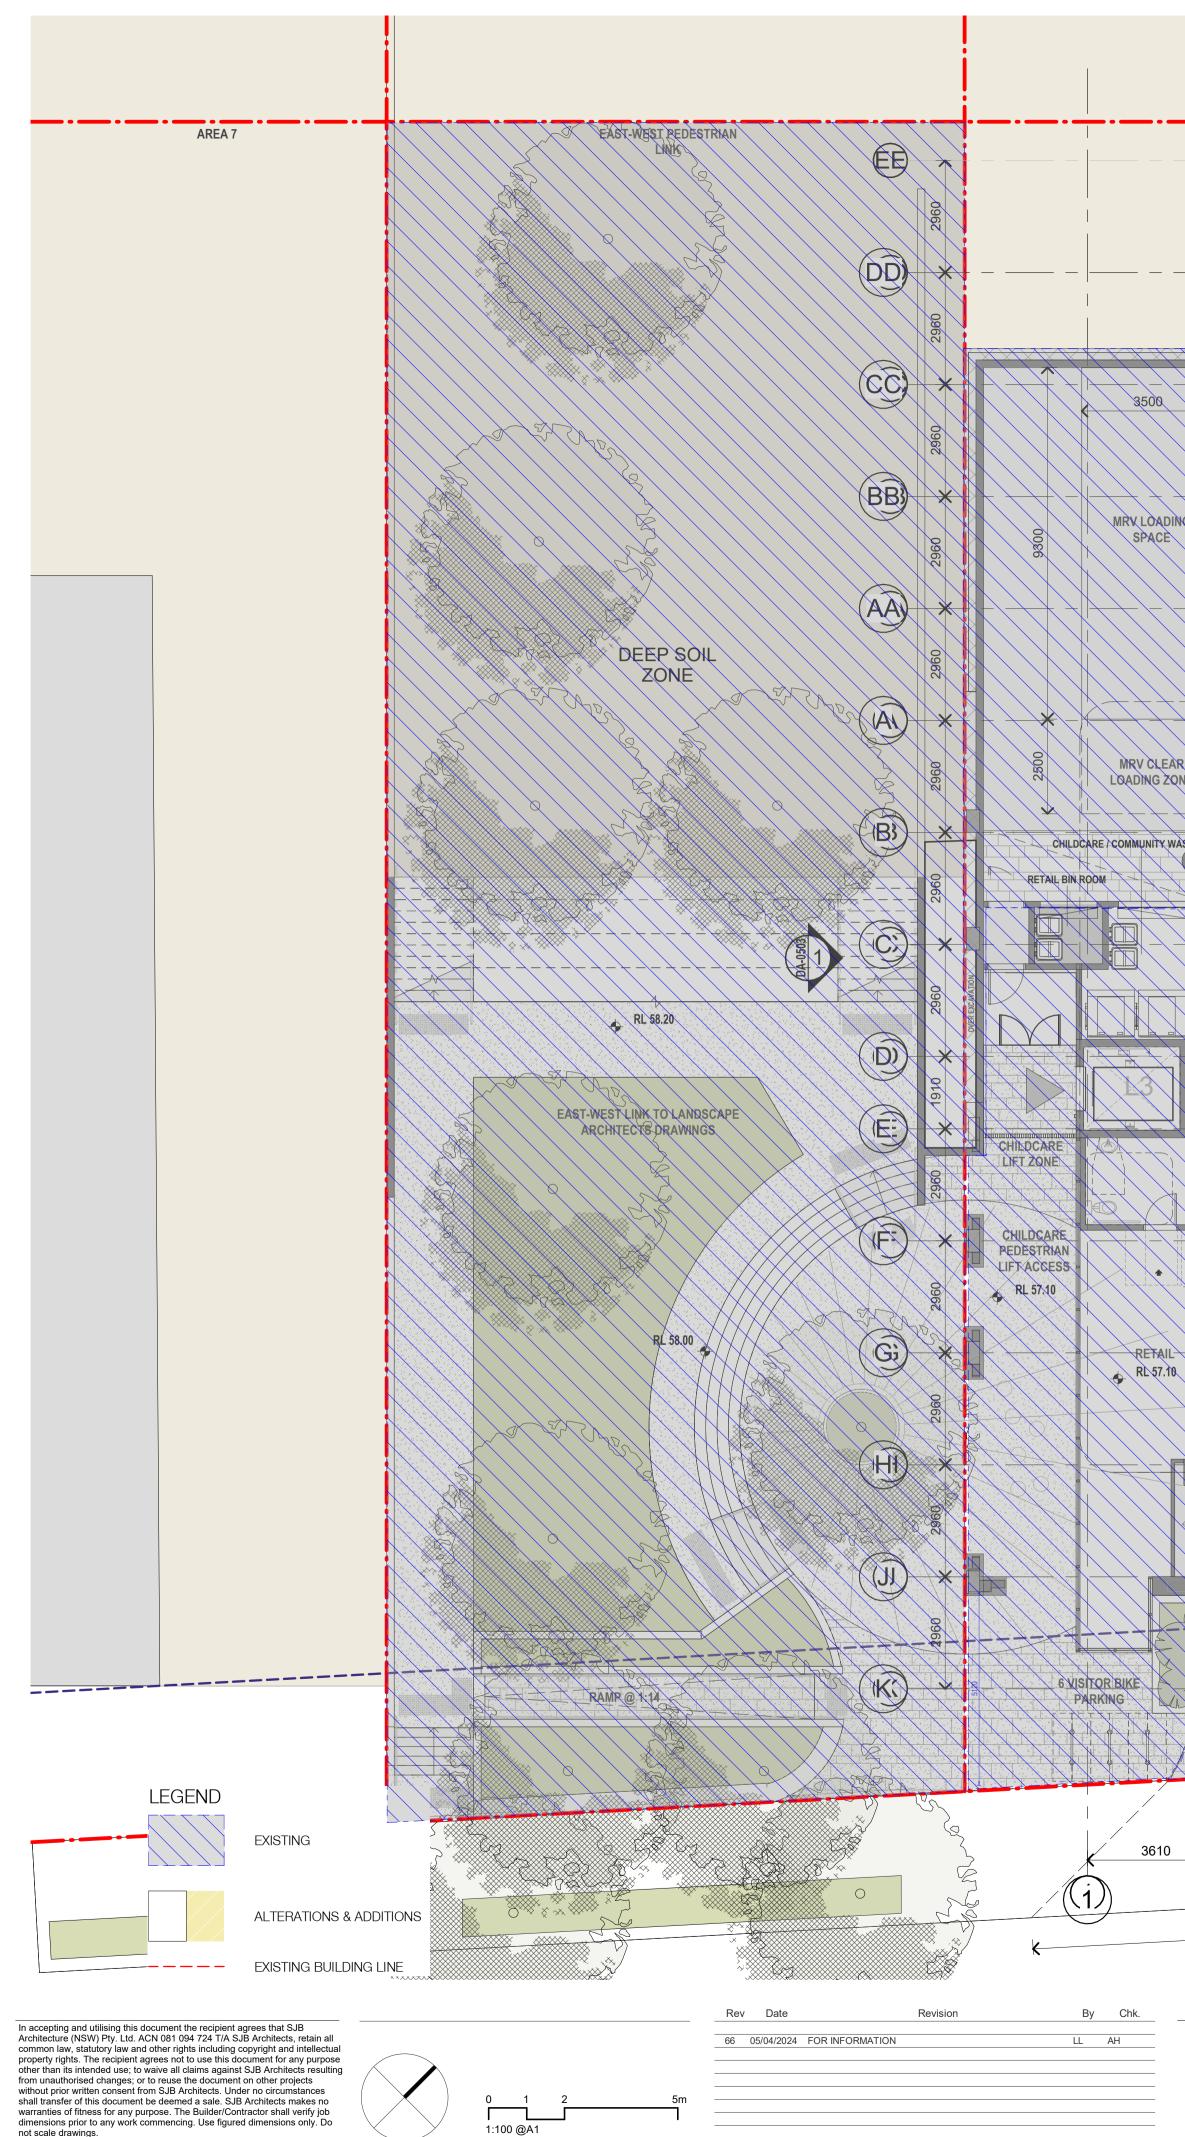


Nominated Architects: Adam Haddow-7188 | John Pradel-7004




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66	05/04/2024	FOR INFORMATION	LL	AH
67	06/06/2024	FOR INFORMATION	TK	MS

DA-0204-A




not scale drawings. Nominated Architects: Adam Haddow-7188 | John Pradel-7004

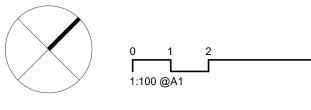

		DA-0504 1	AREA 5 DEEP SOIL		
	MANAGERRD	M RES. BIN HOLDING RL 56.90		ROC RL 56.90	S STORAGE 56.90 M
AR CONE WASTE ROOM		ARBAGE CHUTE			RAMP @1:8 VISITOR BIKE PARKING
	CHILDCARE CARPARIX ENTRY 3240	RL 57.57 RL 57.57 CARD READER RL 57.30 RL 57.30 RL 57.30	3 FIRE CONTROL ROOM	FS2B FCD FCD FCD FCD FCD FCD FCD FCD	
	IETER SUPBOARDS	PARCEL CUPBOARD 2.5m x 2m CLI LINE ZONE 3610	RL 58.26	SALC OSD TANK UNDER SALC OSD TANK UNDER TEPRACE 39 11 RAINWATER TANK UNDER TERRACE 3610 3610 3610	RL 58.30
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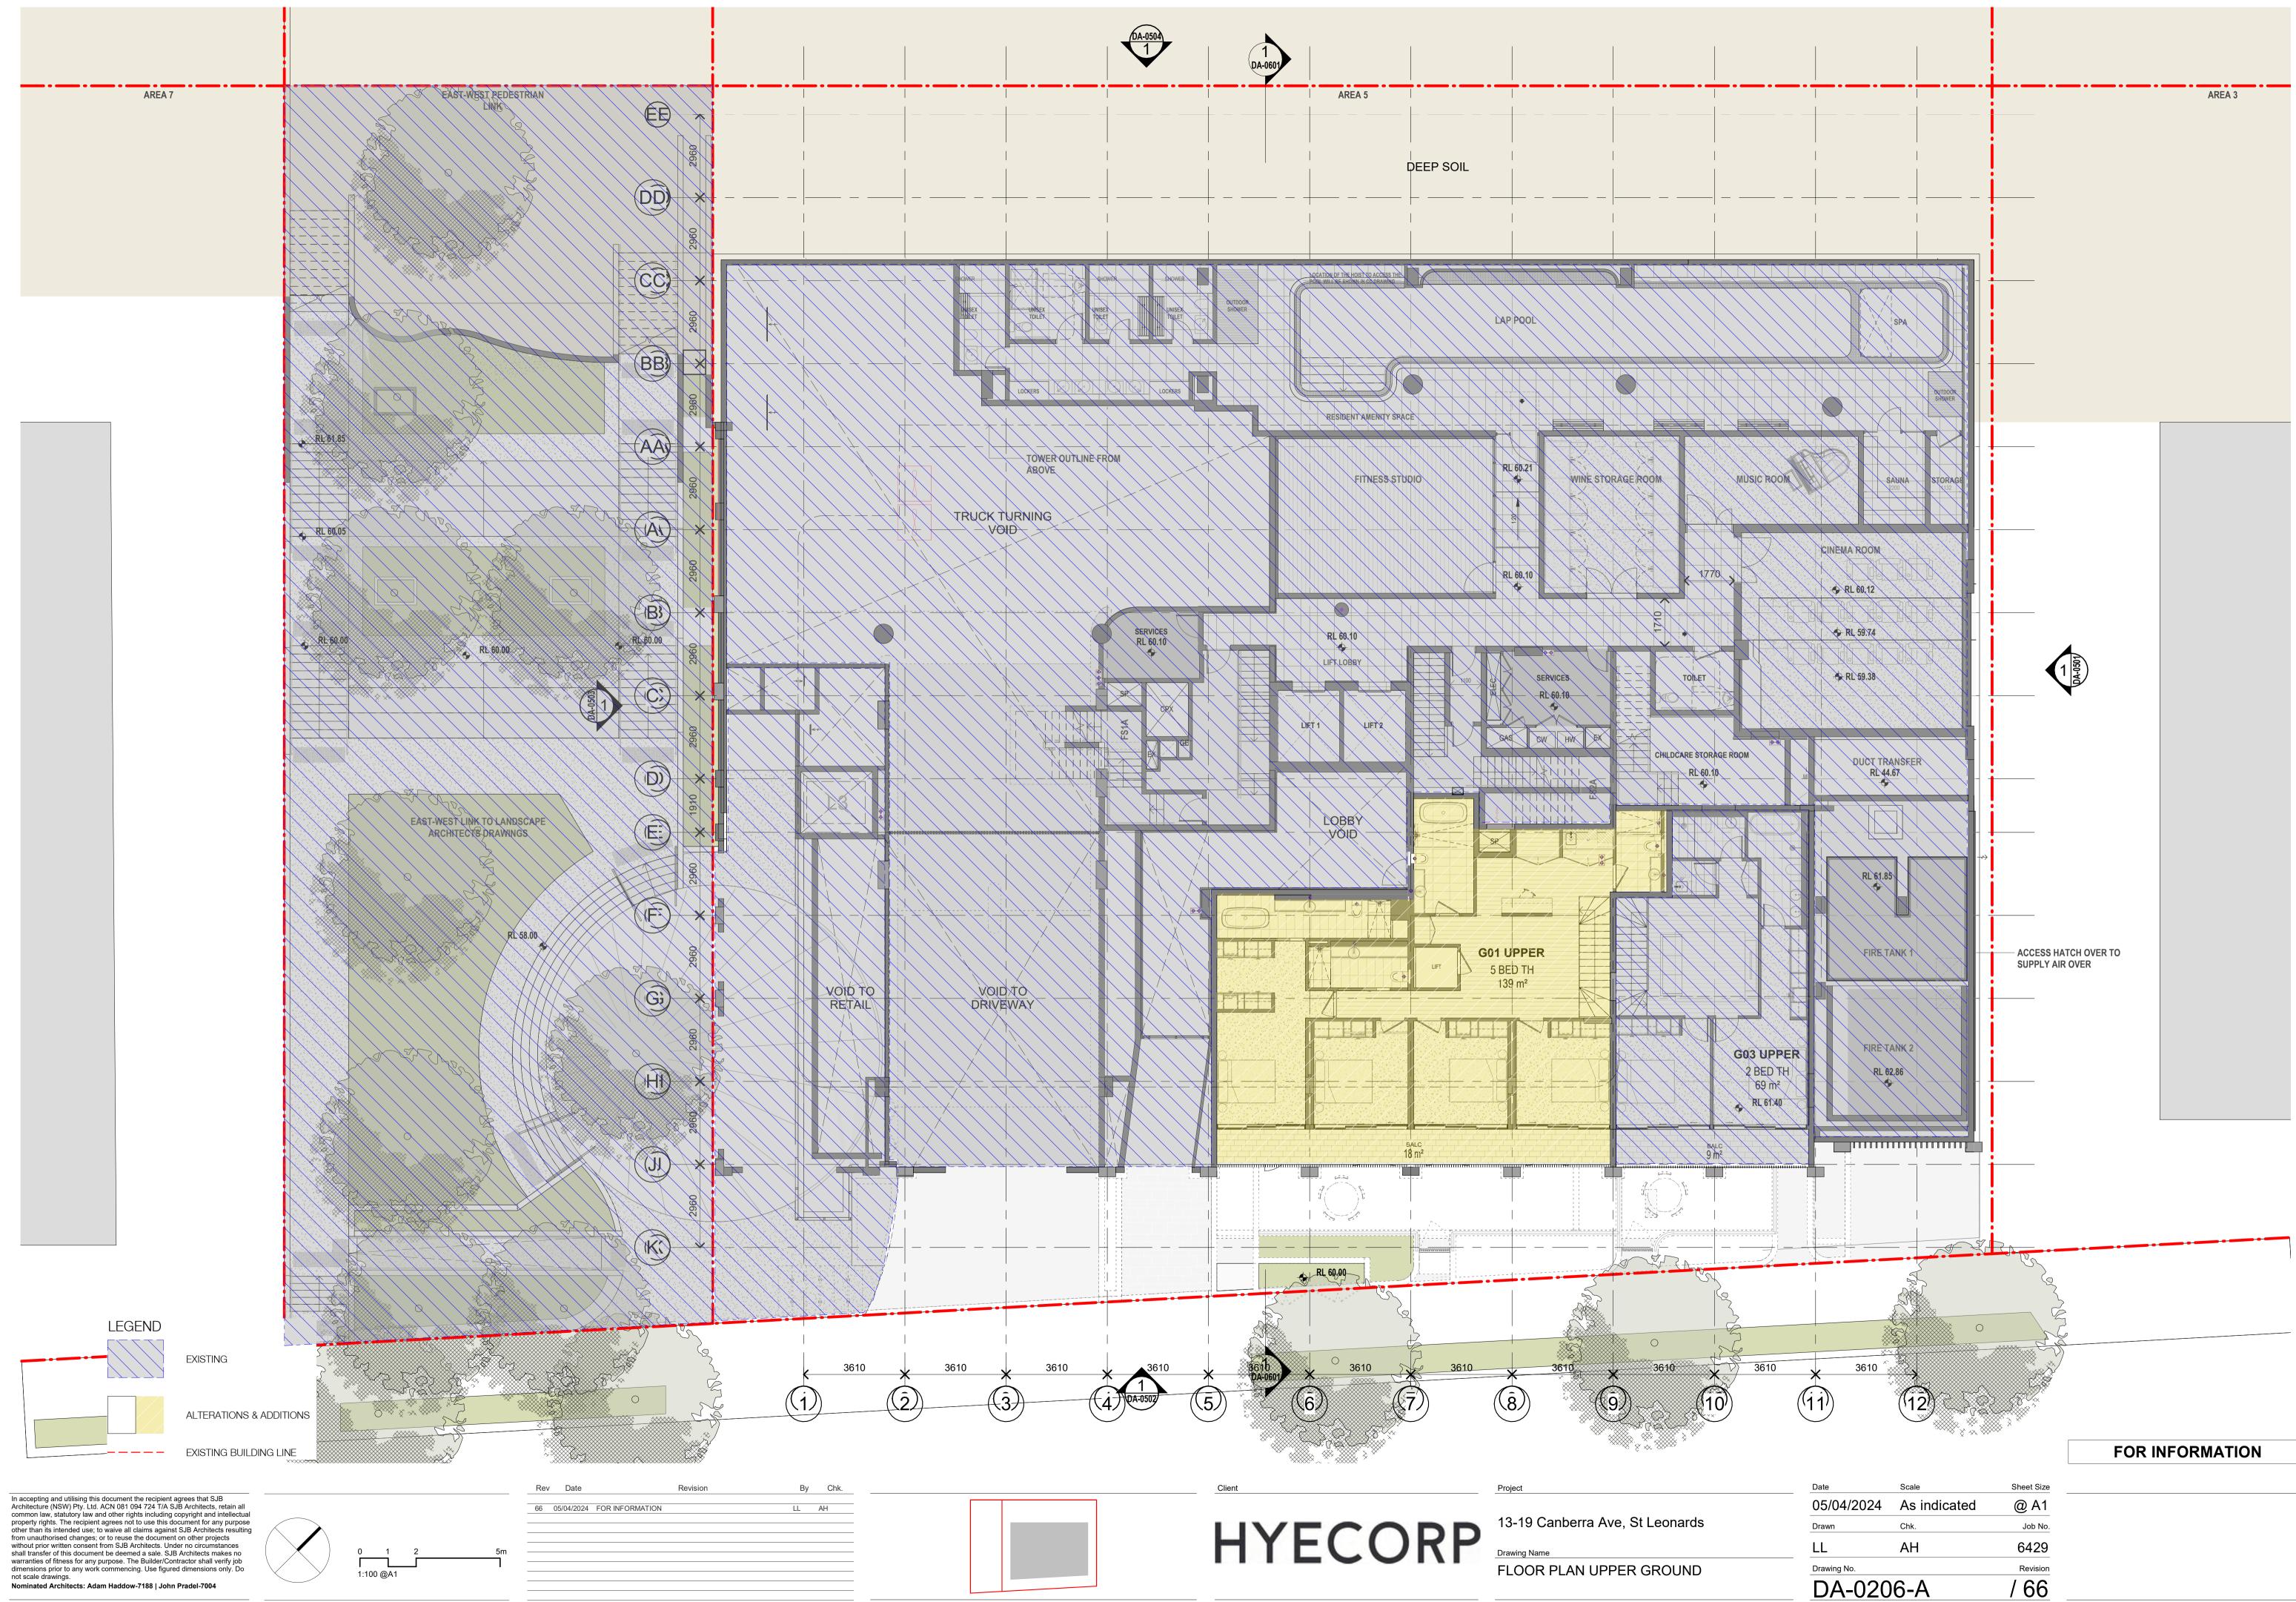
HYECORP 13-19 Canberra Ave, St Leonards Drawing Name FLOOR PLAN GROUND




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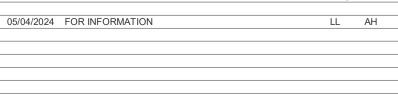
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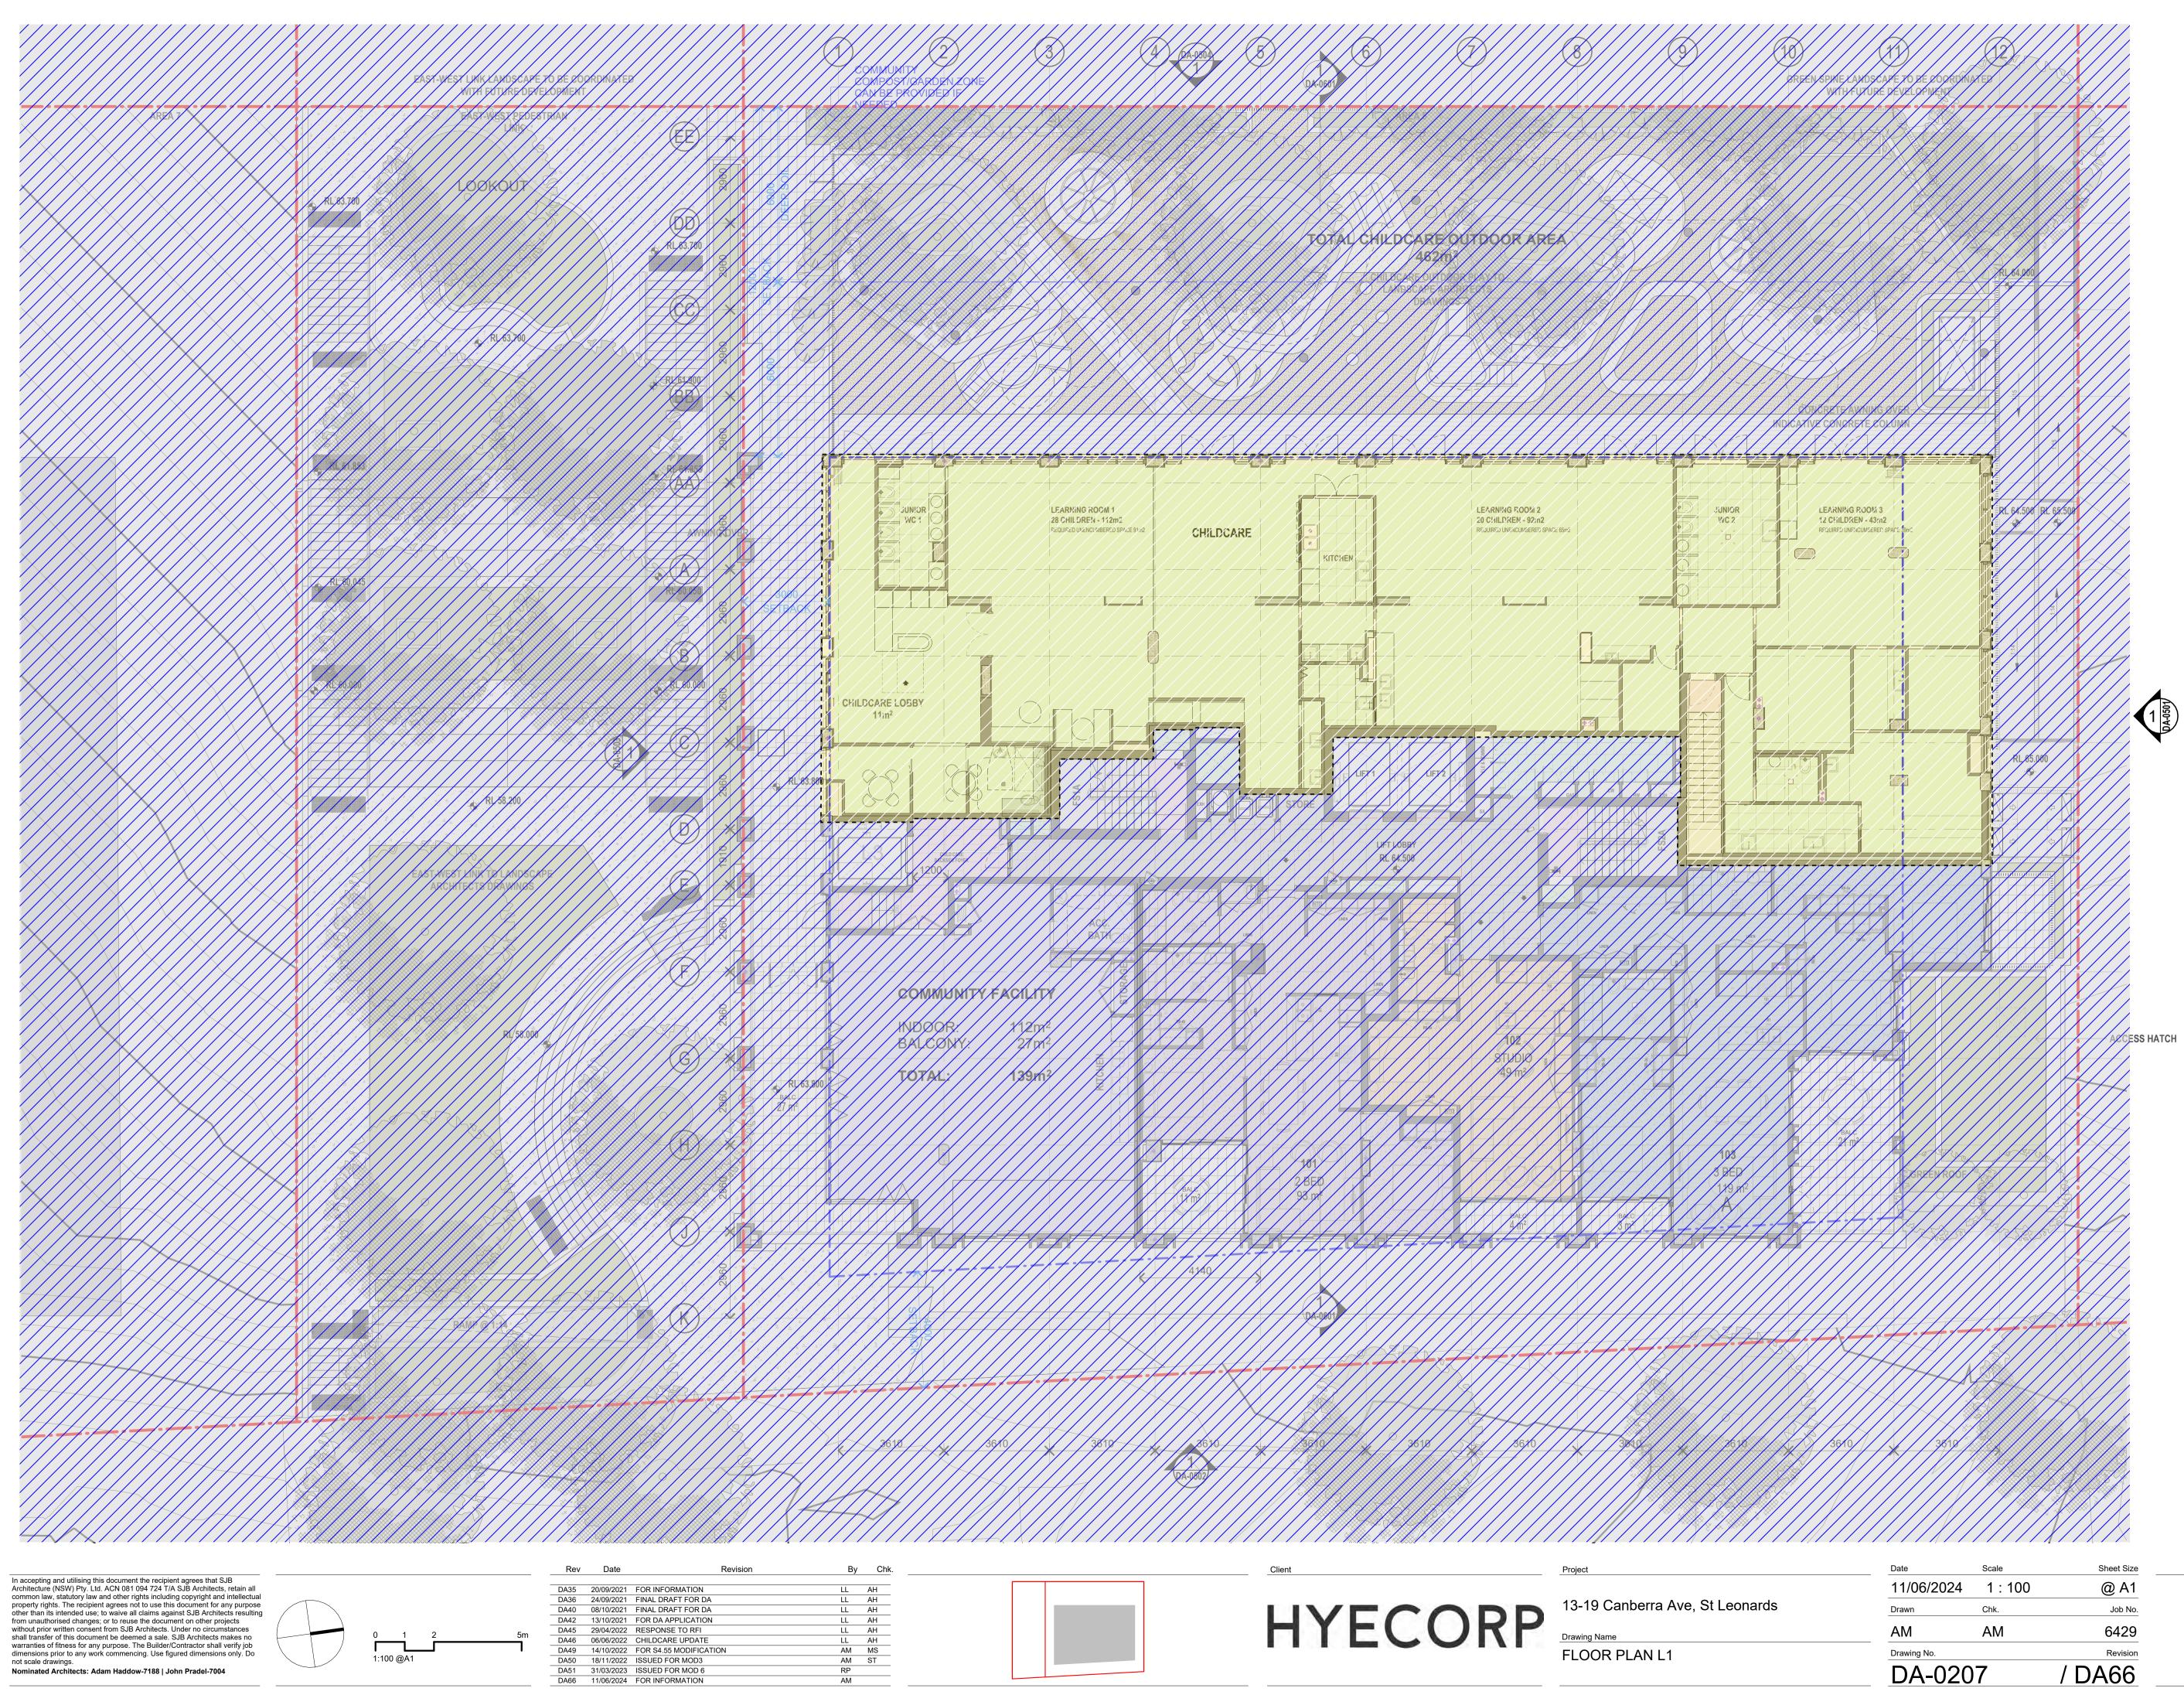
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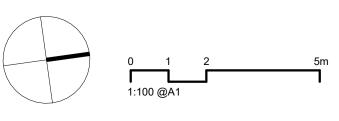
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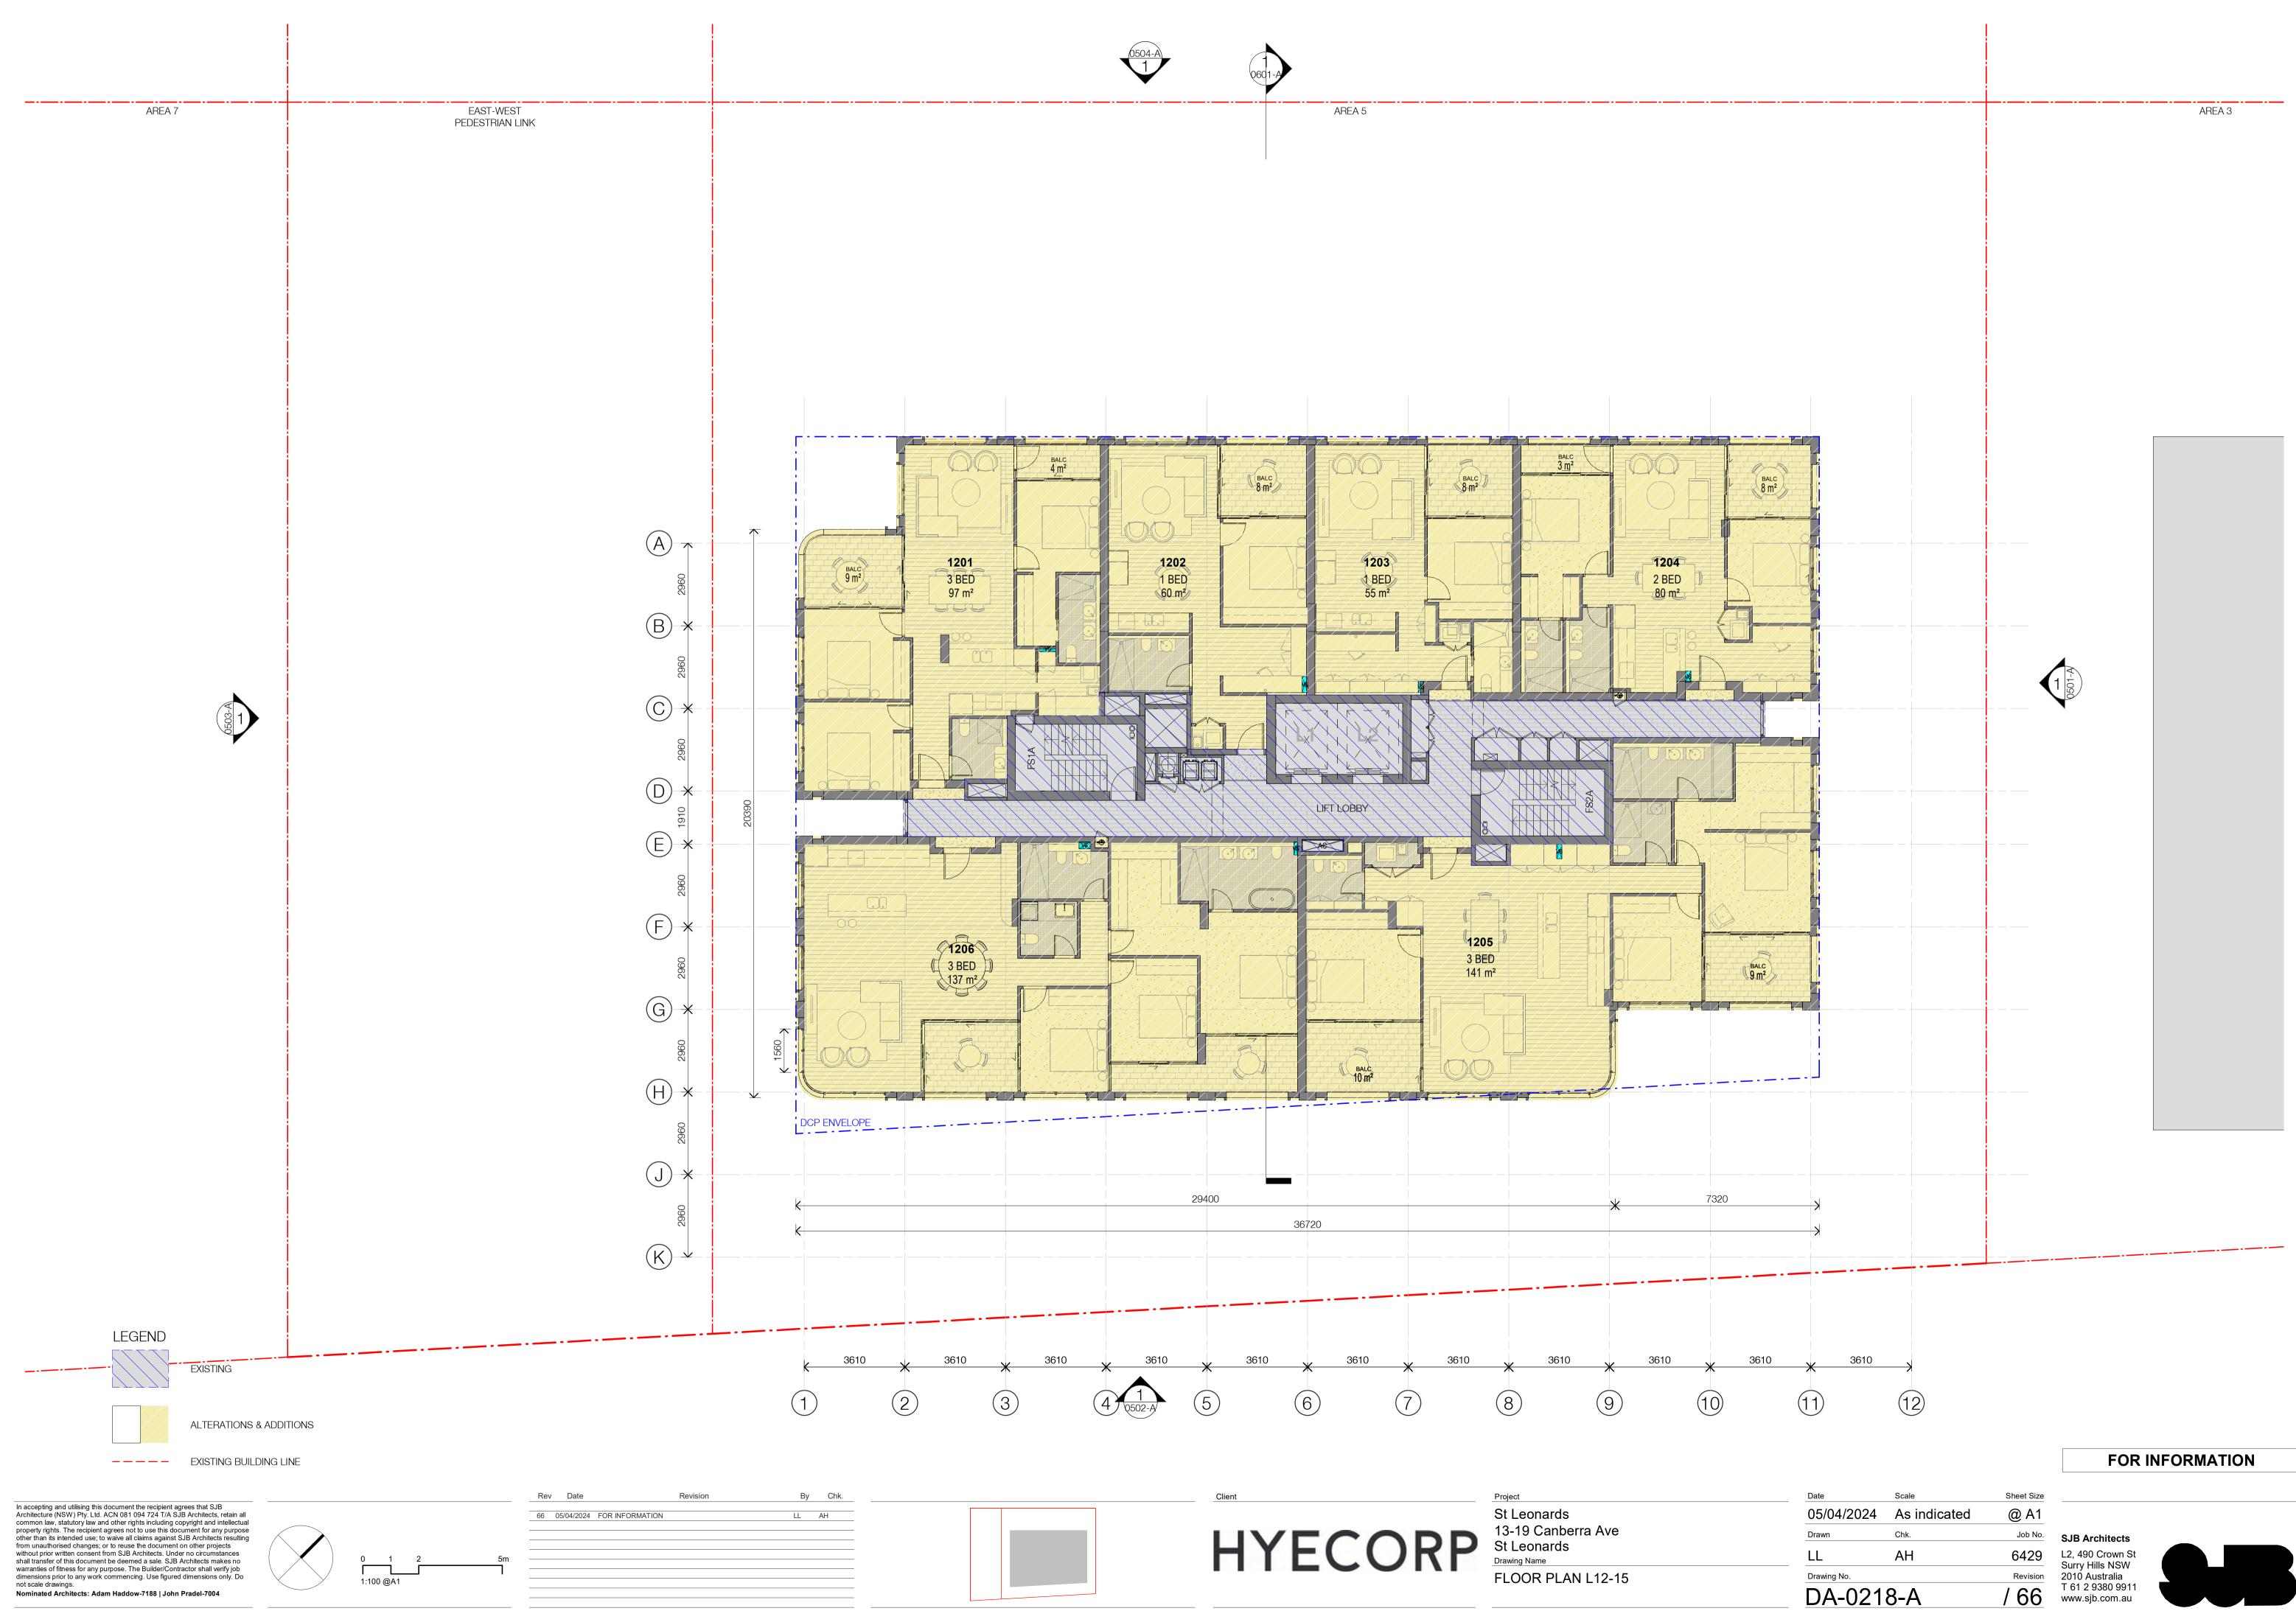


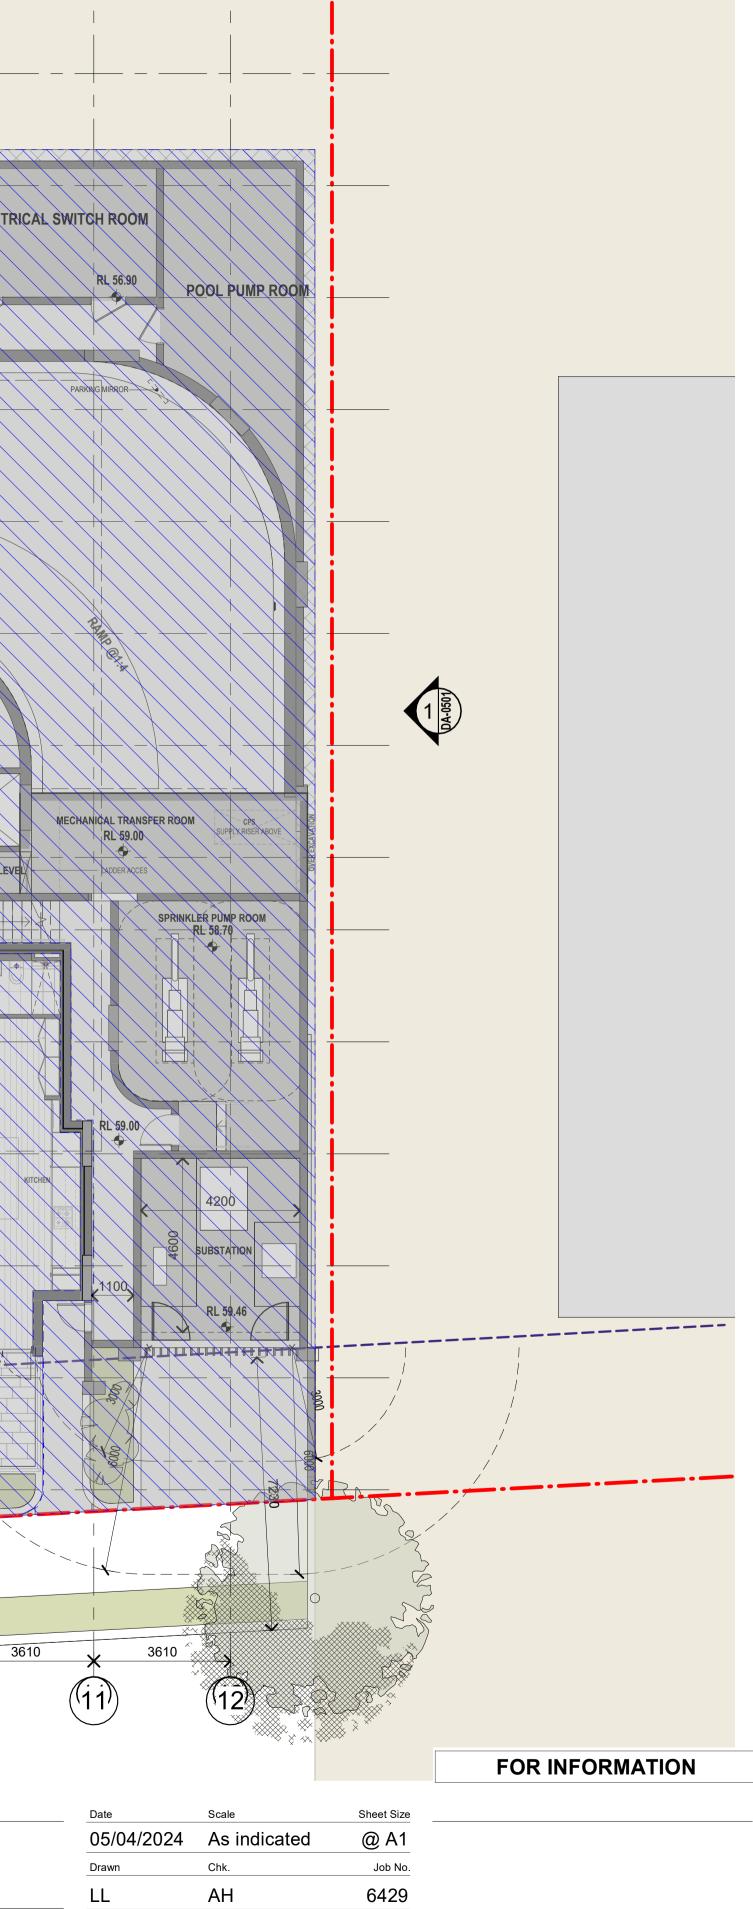
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DA35	20/09/2021	FOR INFORMATION	LL	AH
DA36	24/09/2021	FINAL DRAFT FOR DA	LL	AH
DA40	08/10/2021	FINAL DRAFT FOR DA	LL	AH
DA42	13/10/2021	FOR DA APPLICATION	LL	AH
DA45	29/04/2022	RESPONSE TO RFI	LL	AH
DA46	06/06/2022	CHILDCARE UPDATE	LL	AH
DA49	14/10/2022	FOR S4.55 MODIFICATION	AM	MS
DA50	18/11/2022	ISSUED FOR MOD3	AM	ST
DA51	31/03/2023	ISSUED FOR MOD 6	RP	
DA66	11/06/2024	FOR INFORMATION	AM	








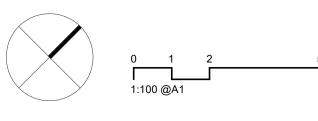


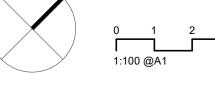

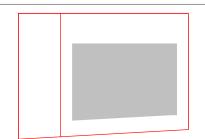




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Drawn	Chk.	Job No
LL	AH	6429
Drawing No.		Revision
DA-021	8-A	/ 66

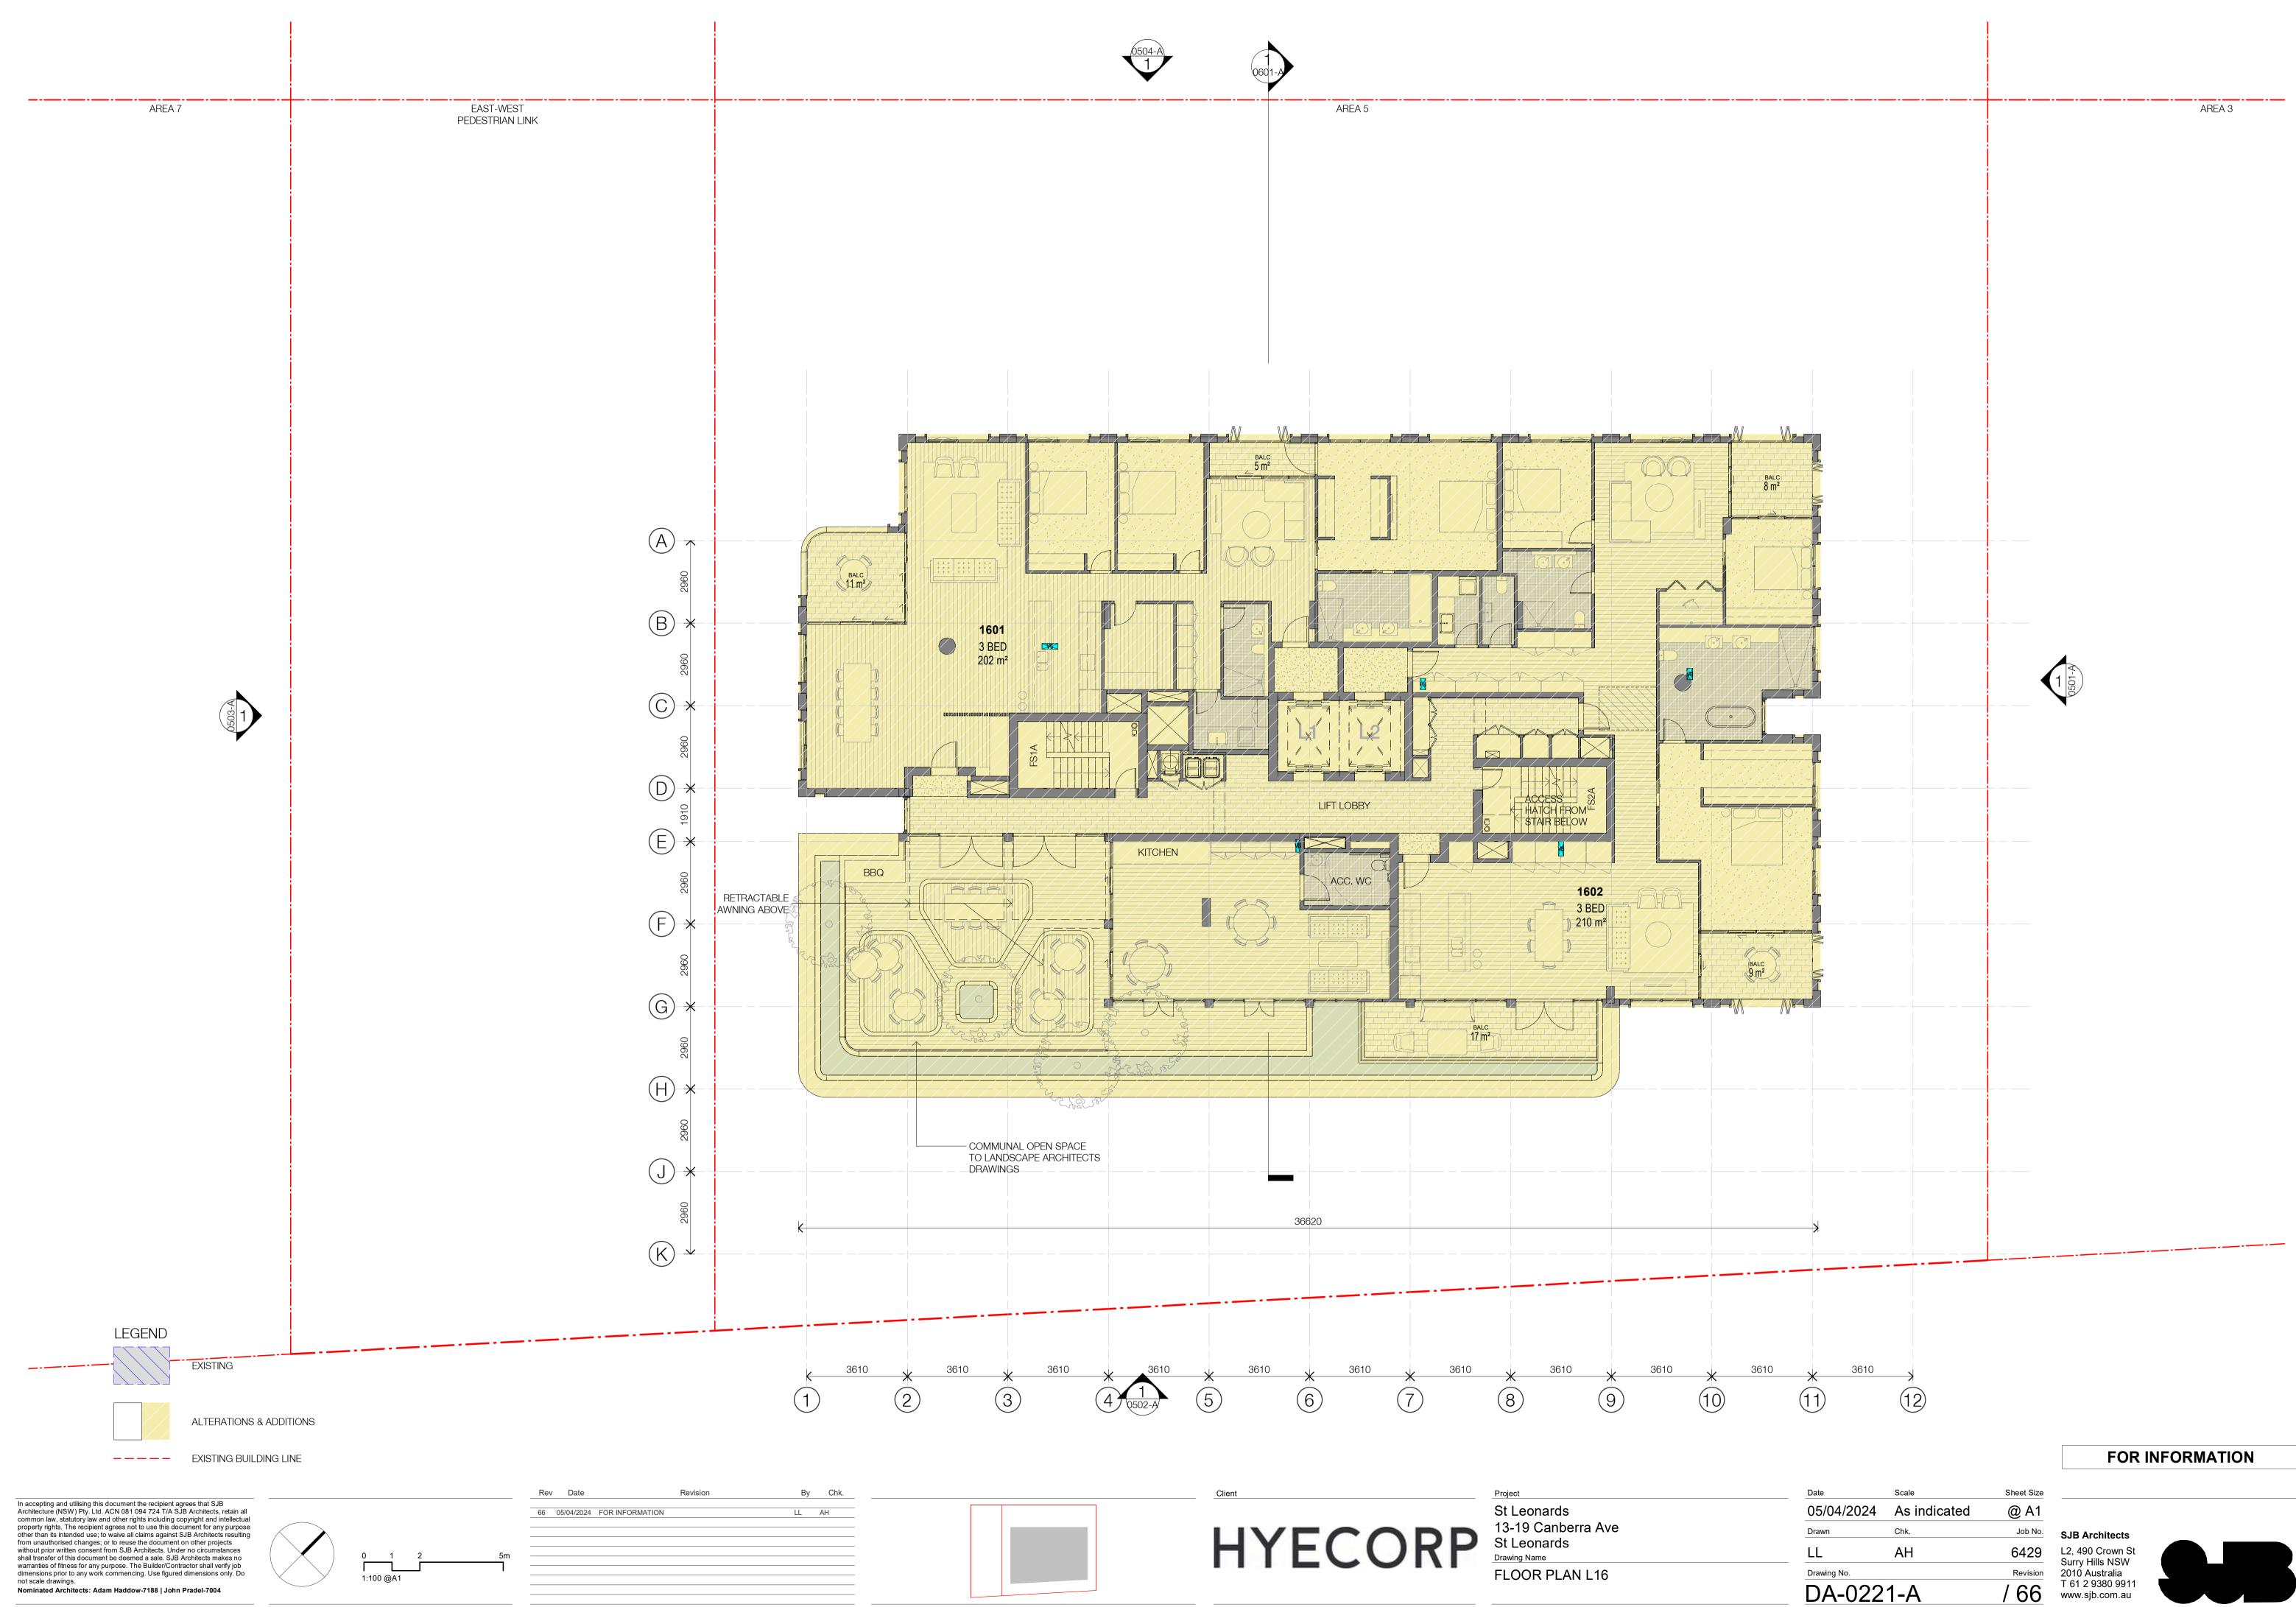







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LL	AH	6429
Drawing No.		Revision
DA-022	1-A	/ 66

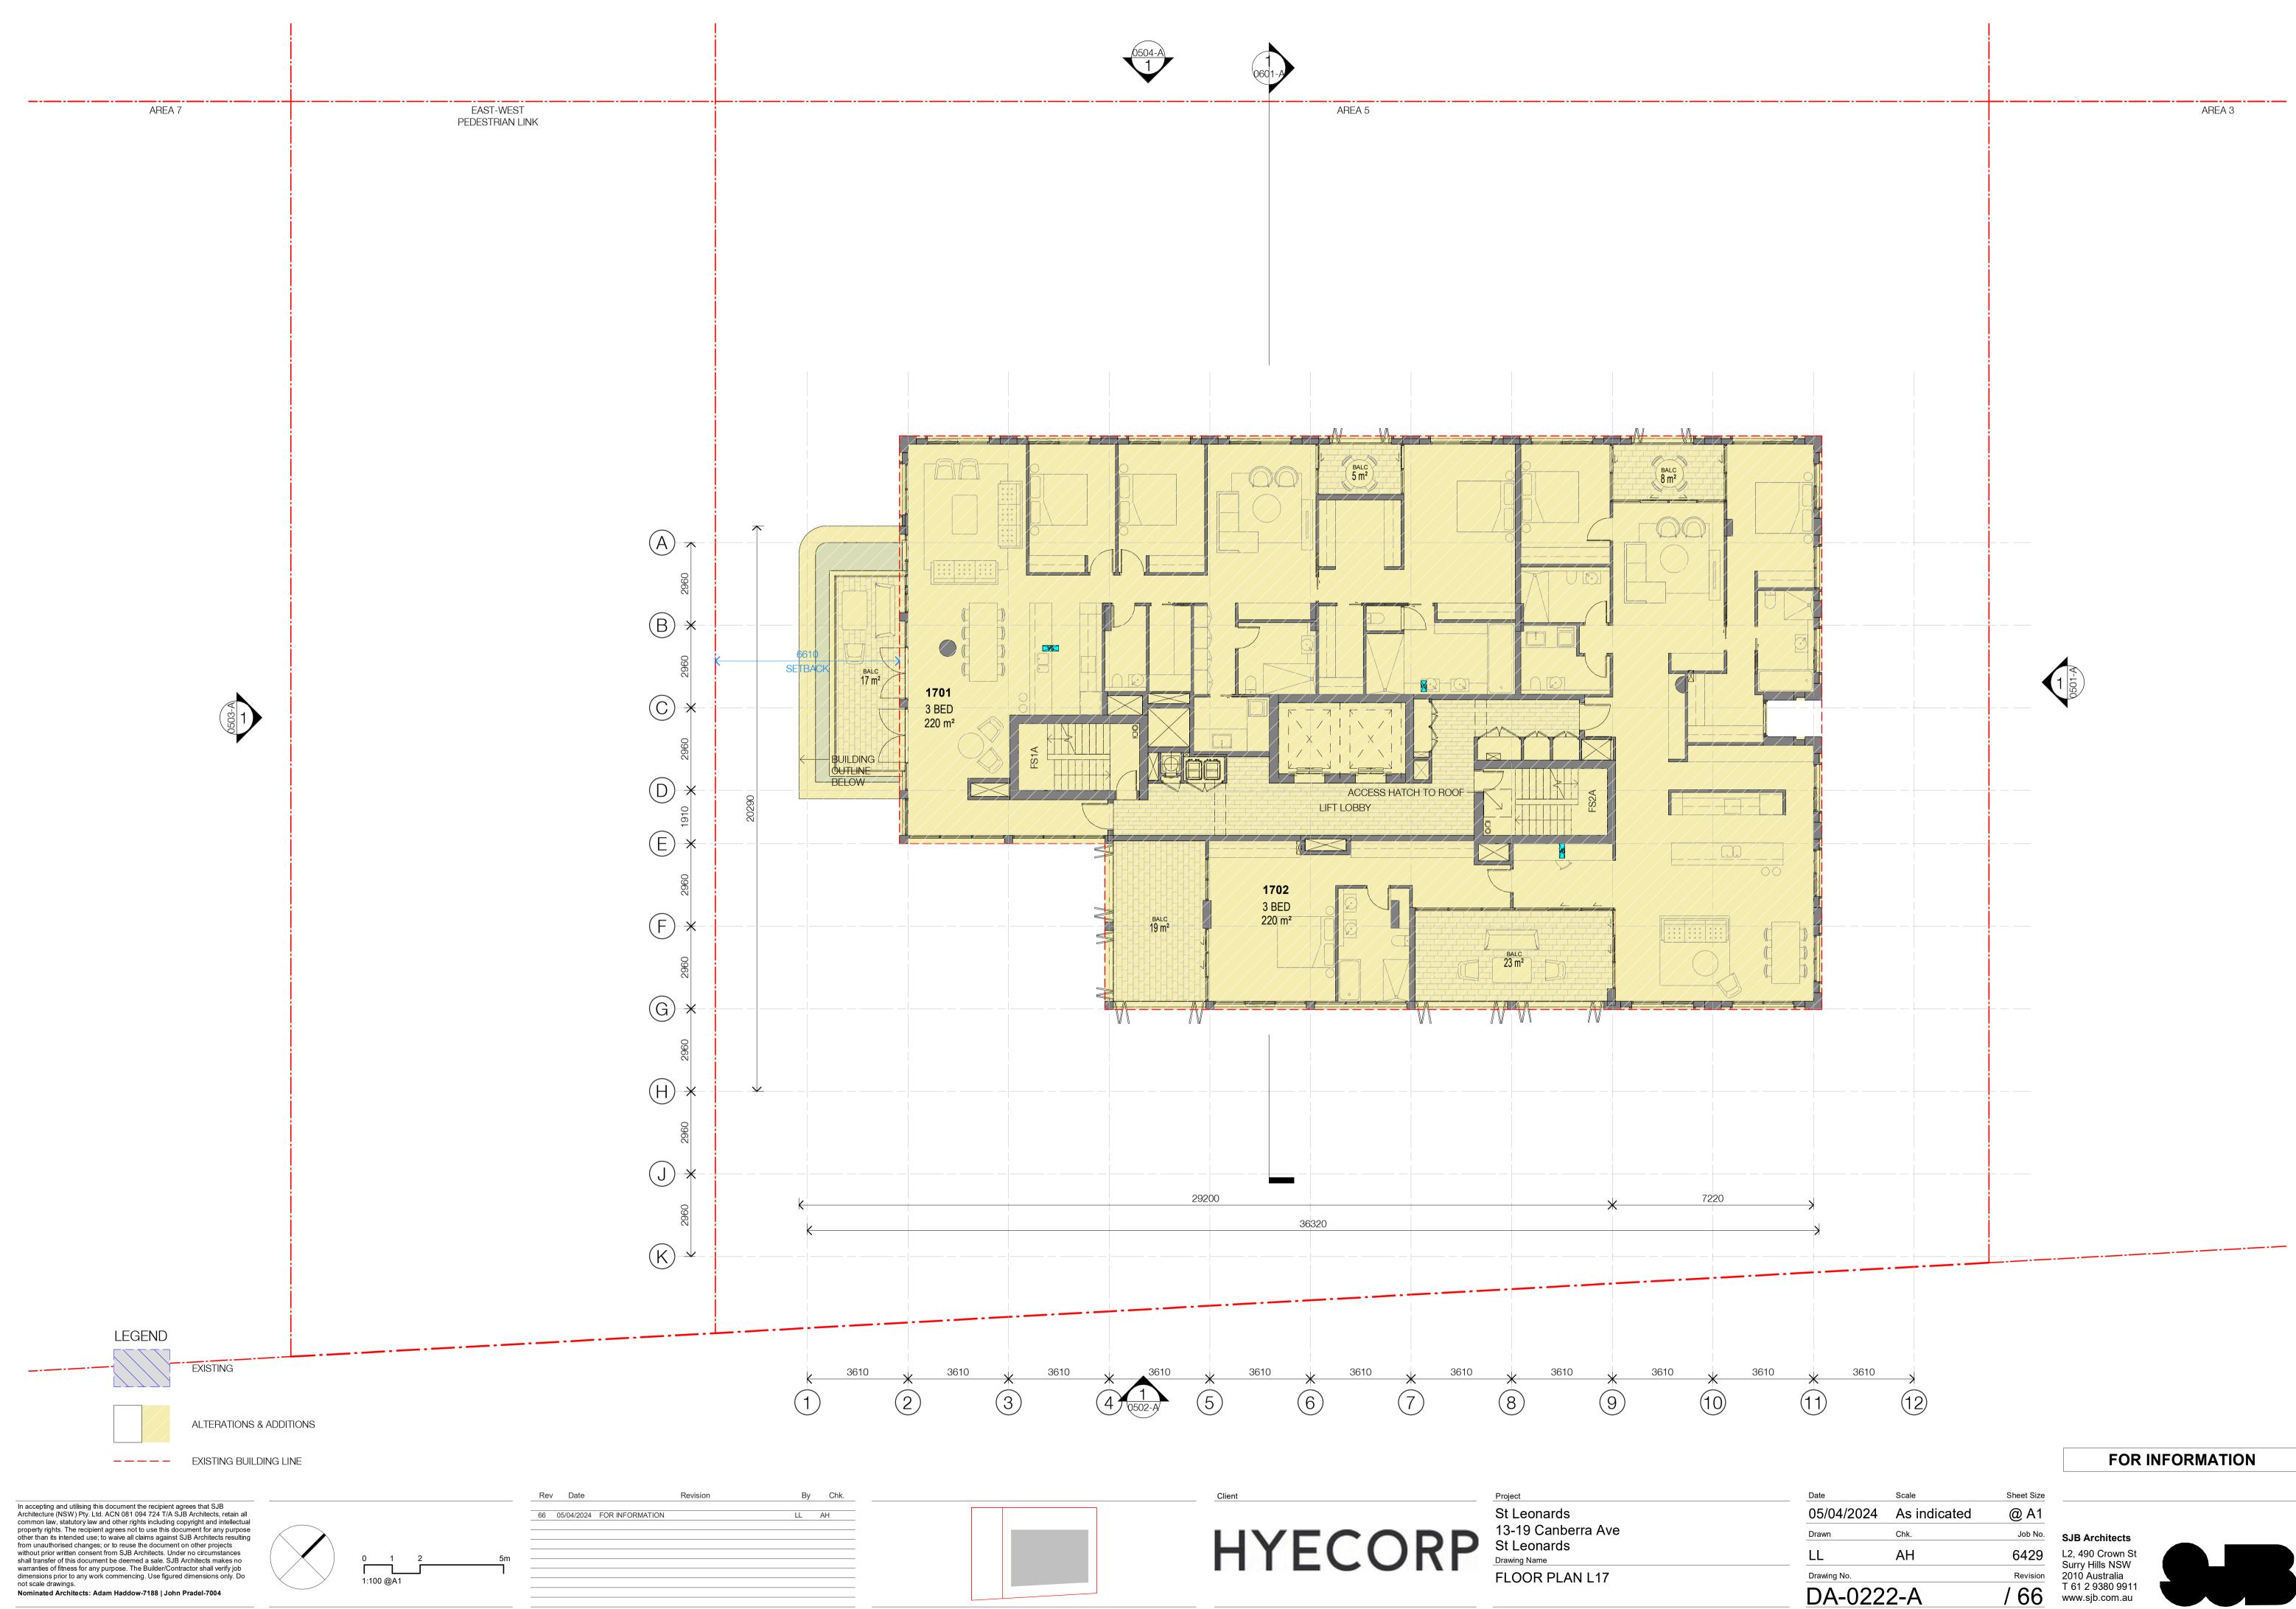


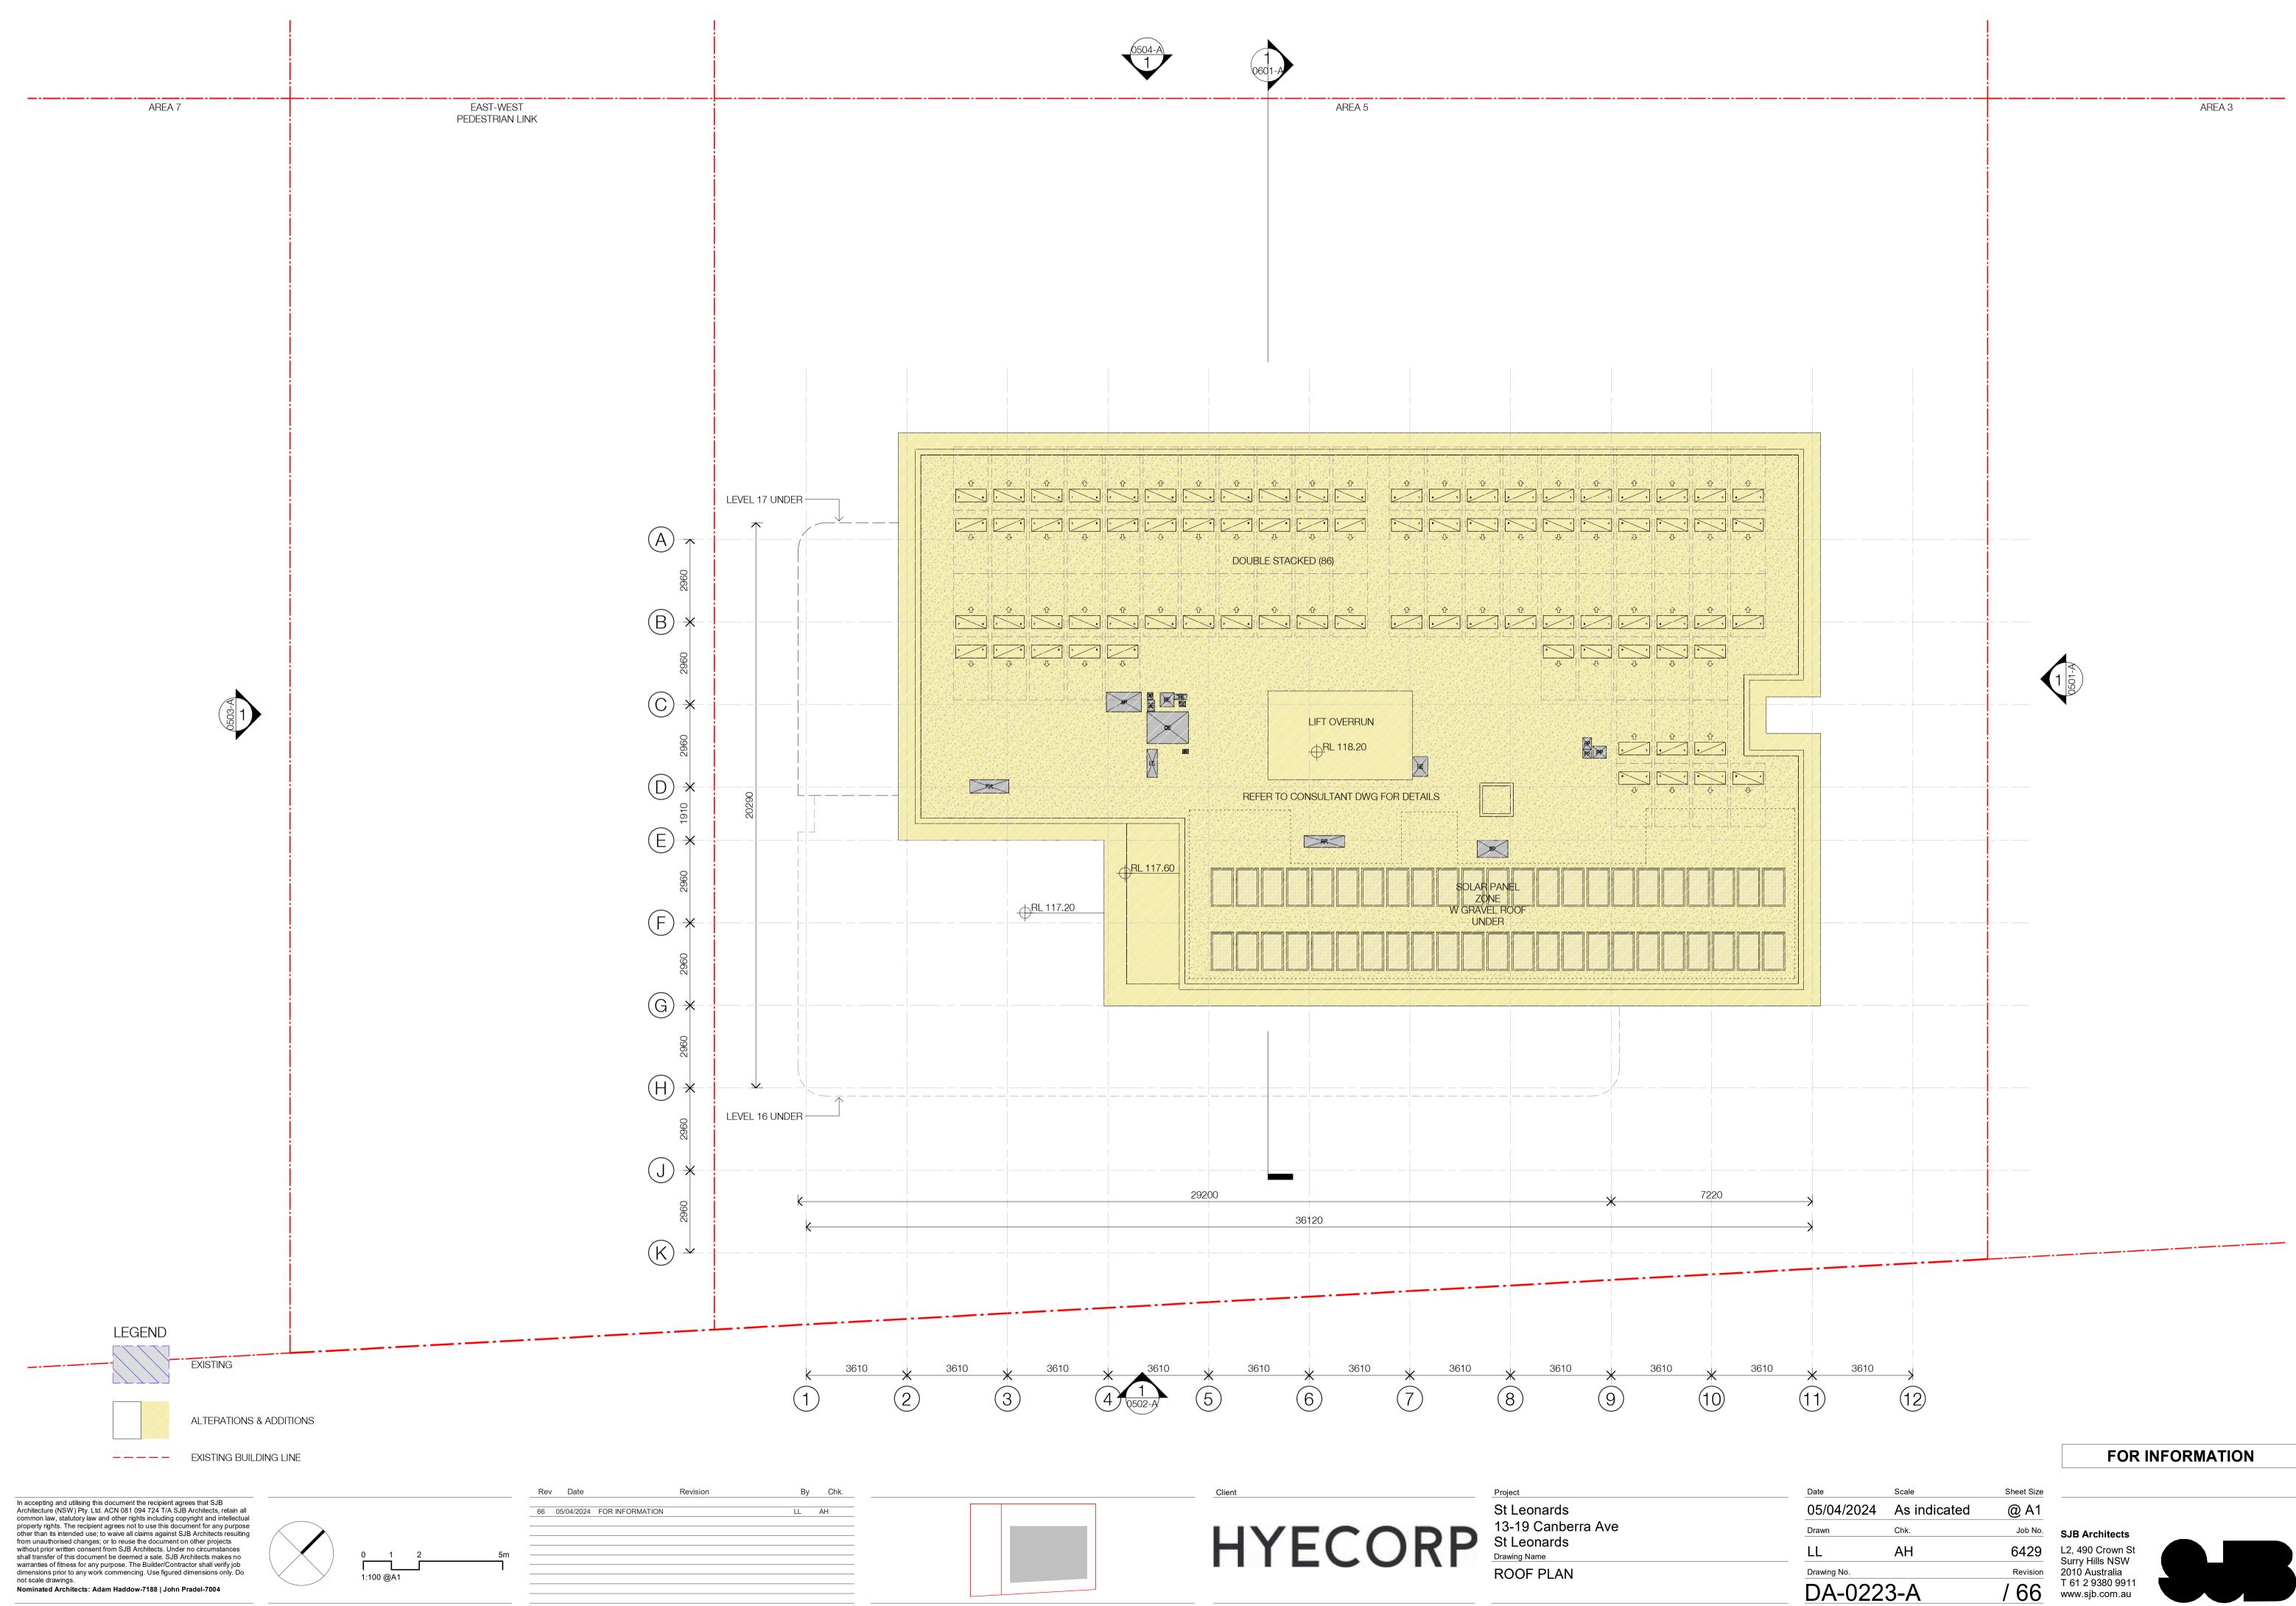

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Drawn	Chk.	Job No.
LL	AH	6429
Drawing No.		Revision
DA-022	23-A	/ 66

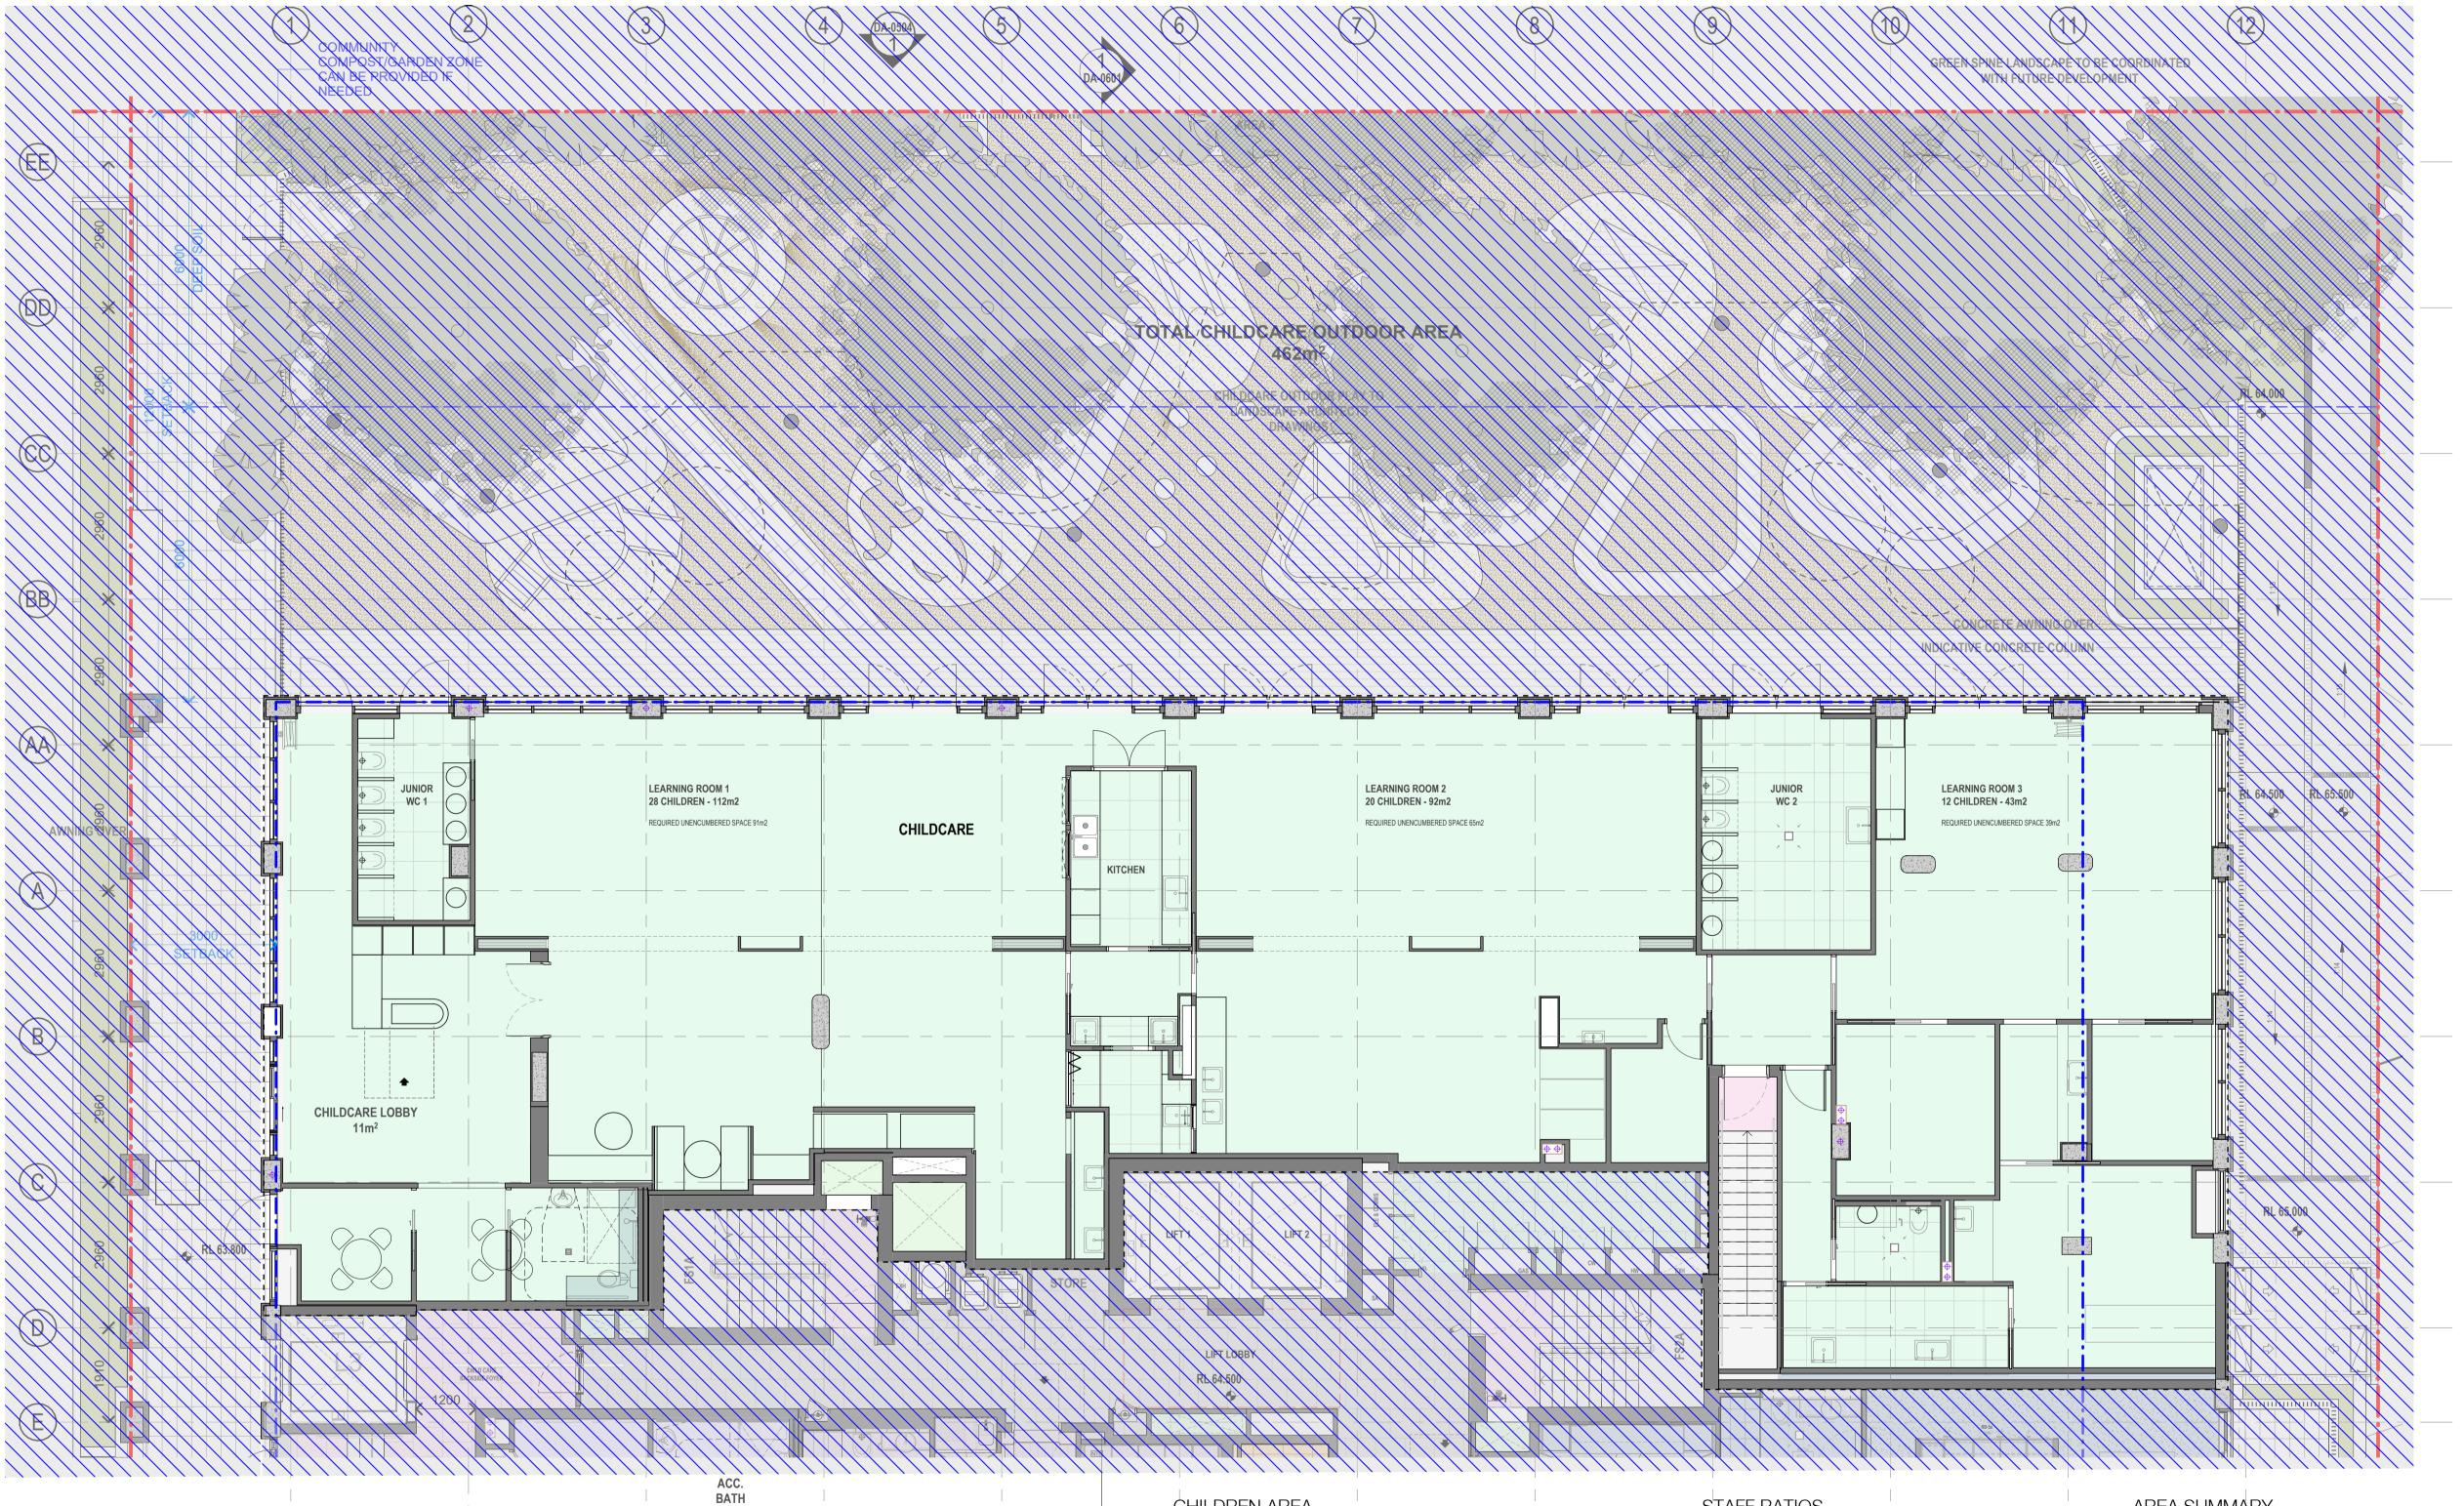

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Rev	Date	Revision	Ву	Chk.
DA28	18/08/2021	FOR COORDINATION	LL	AH
DA29	27/08/2021	FOR INFORMATION	LL	AH
DA32	03/09/2021	FINAL DRAFT FOR DA	LL	AH
DA35	20/09/2021	FOR INFORMATION	LL	AH
DA36	24/09/2021	FINAL DRAFT FOR DA	LL	AH
DA40	08/10/2021	FINAL DRAFT FOR DA	LL	AH
DA42	13/10/2021	FOR DA APPLICATION	LL	AH
DA45	29/04/2022	RESPONSE TO RFI	LL	AH
DA46	06/06/2022	CHILDCARE UPDATE	LL	AH
DA66	11/06/2024	FOR INFORMATION	AM	

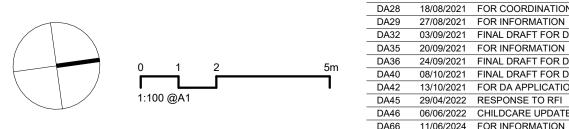NO. CHILDREN	RATIOS	m ² PER CHILD	AREA REQUIRED	AREA PROPOSED
60 CHILDREN	INTERNAL UNENCUMBERED	3.25m ²	195m ²	207m ²
60 CHILDREN	EXTERNAL	7m ²	420m ²	462m ²
TOTAL		10.25m ²	615m ²	669m ²

Client

STAFF RAT	IOS		
AGE GROUPS	CHILD NO.	RATIO	STAFF REQUIRED
BABIES 0-2	12	1:4	3
TODDLERS 2-3	20	1:5	4
PRESCHOOL 3-5	28	1:10	3
ADMIN + COOK			2 + 1
TOTAL	60		13

DA-060

HYECORP

13-19 Canberra Ave, St Leonards

Project

Drawing Name CHILDCARE - LEVEL 1 DETAIL PLAN

AREA SUMMARY

462m ² OUTDOOR PLAY	
207m ² INDOOR PLAY	
36m² INDOOR STORAGE ON L1 23m² INDOOR STORAGE ON UPPER GROUD 2.5m² OUTDOOR STORAGE	

DA-5010		/ DA66
Drawing No.		Revision
AM	AM	6429
Drawn	Chk.	Job No.
11/06/2024	1 : 75	@ A1
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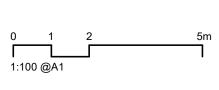
EXISTING



ALTERATIONS & ADDITIONS


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66	05/04/2024	FOR INFORMATION	LL	AH
68	07/06/2024	FOR INFORMATION	YL	AH

NORTH ELEVATION




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13-19 Canberra Ave St Leonards Drawing Name EAST ELEVATION


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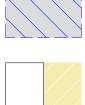
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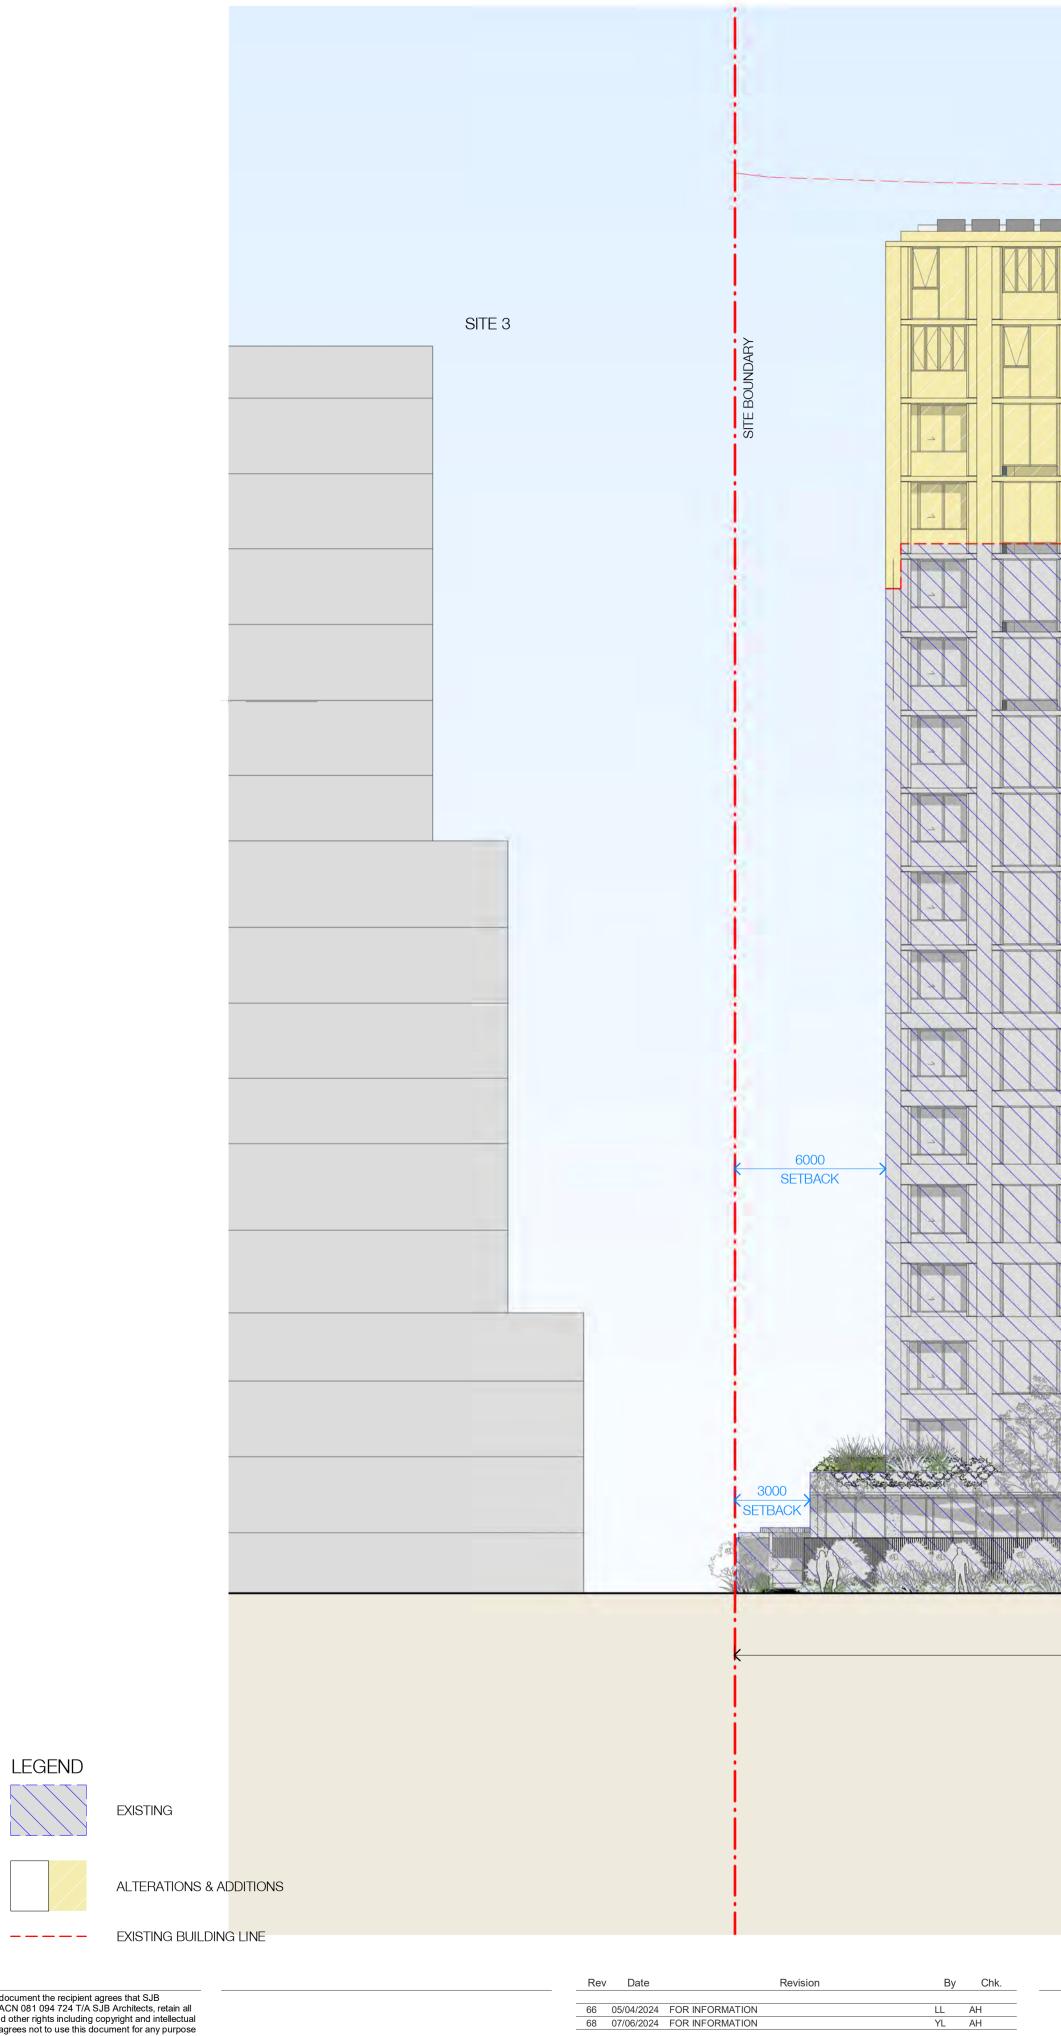
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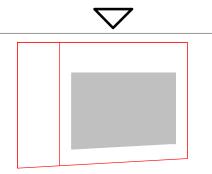
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SITE 5

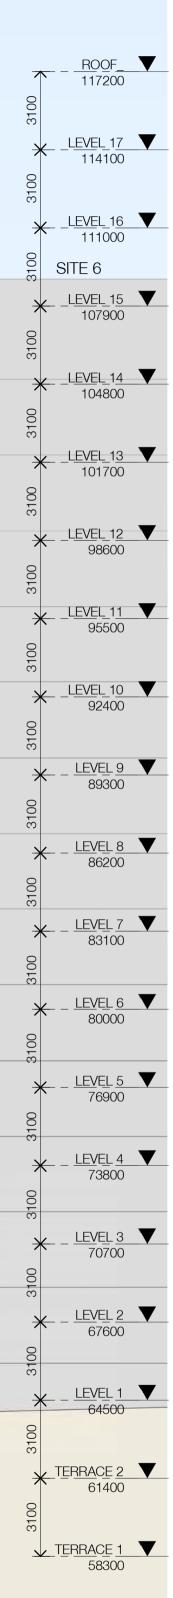— 57.2m HEIGHT PLANE TO WEST FACADE OF TOWER


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Client

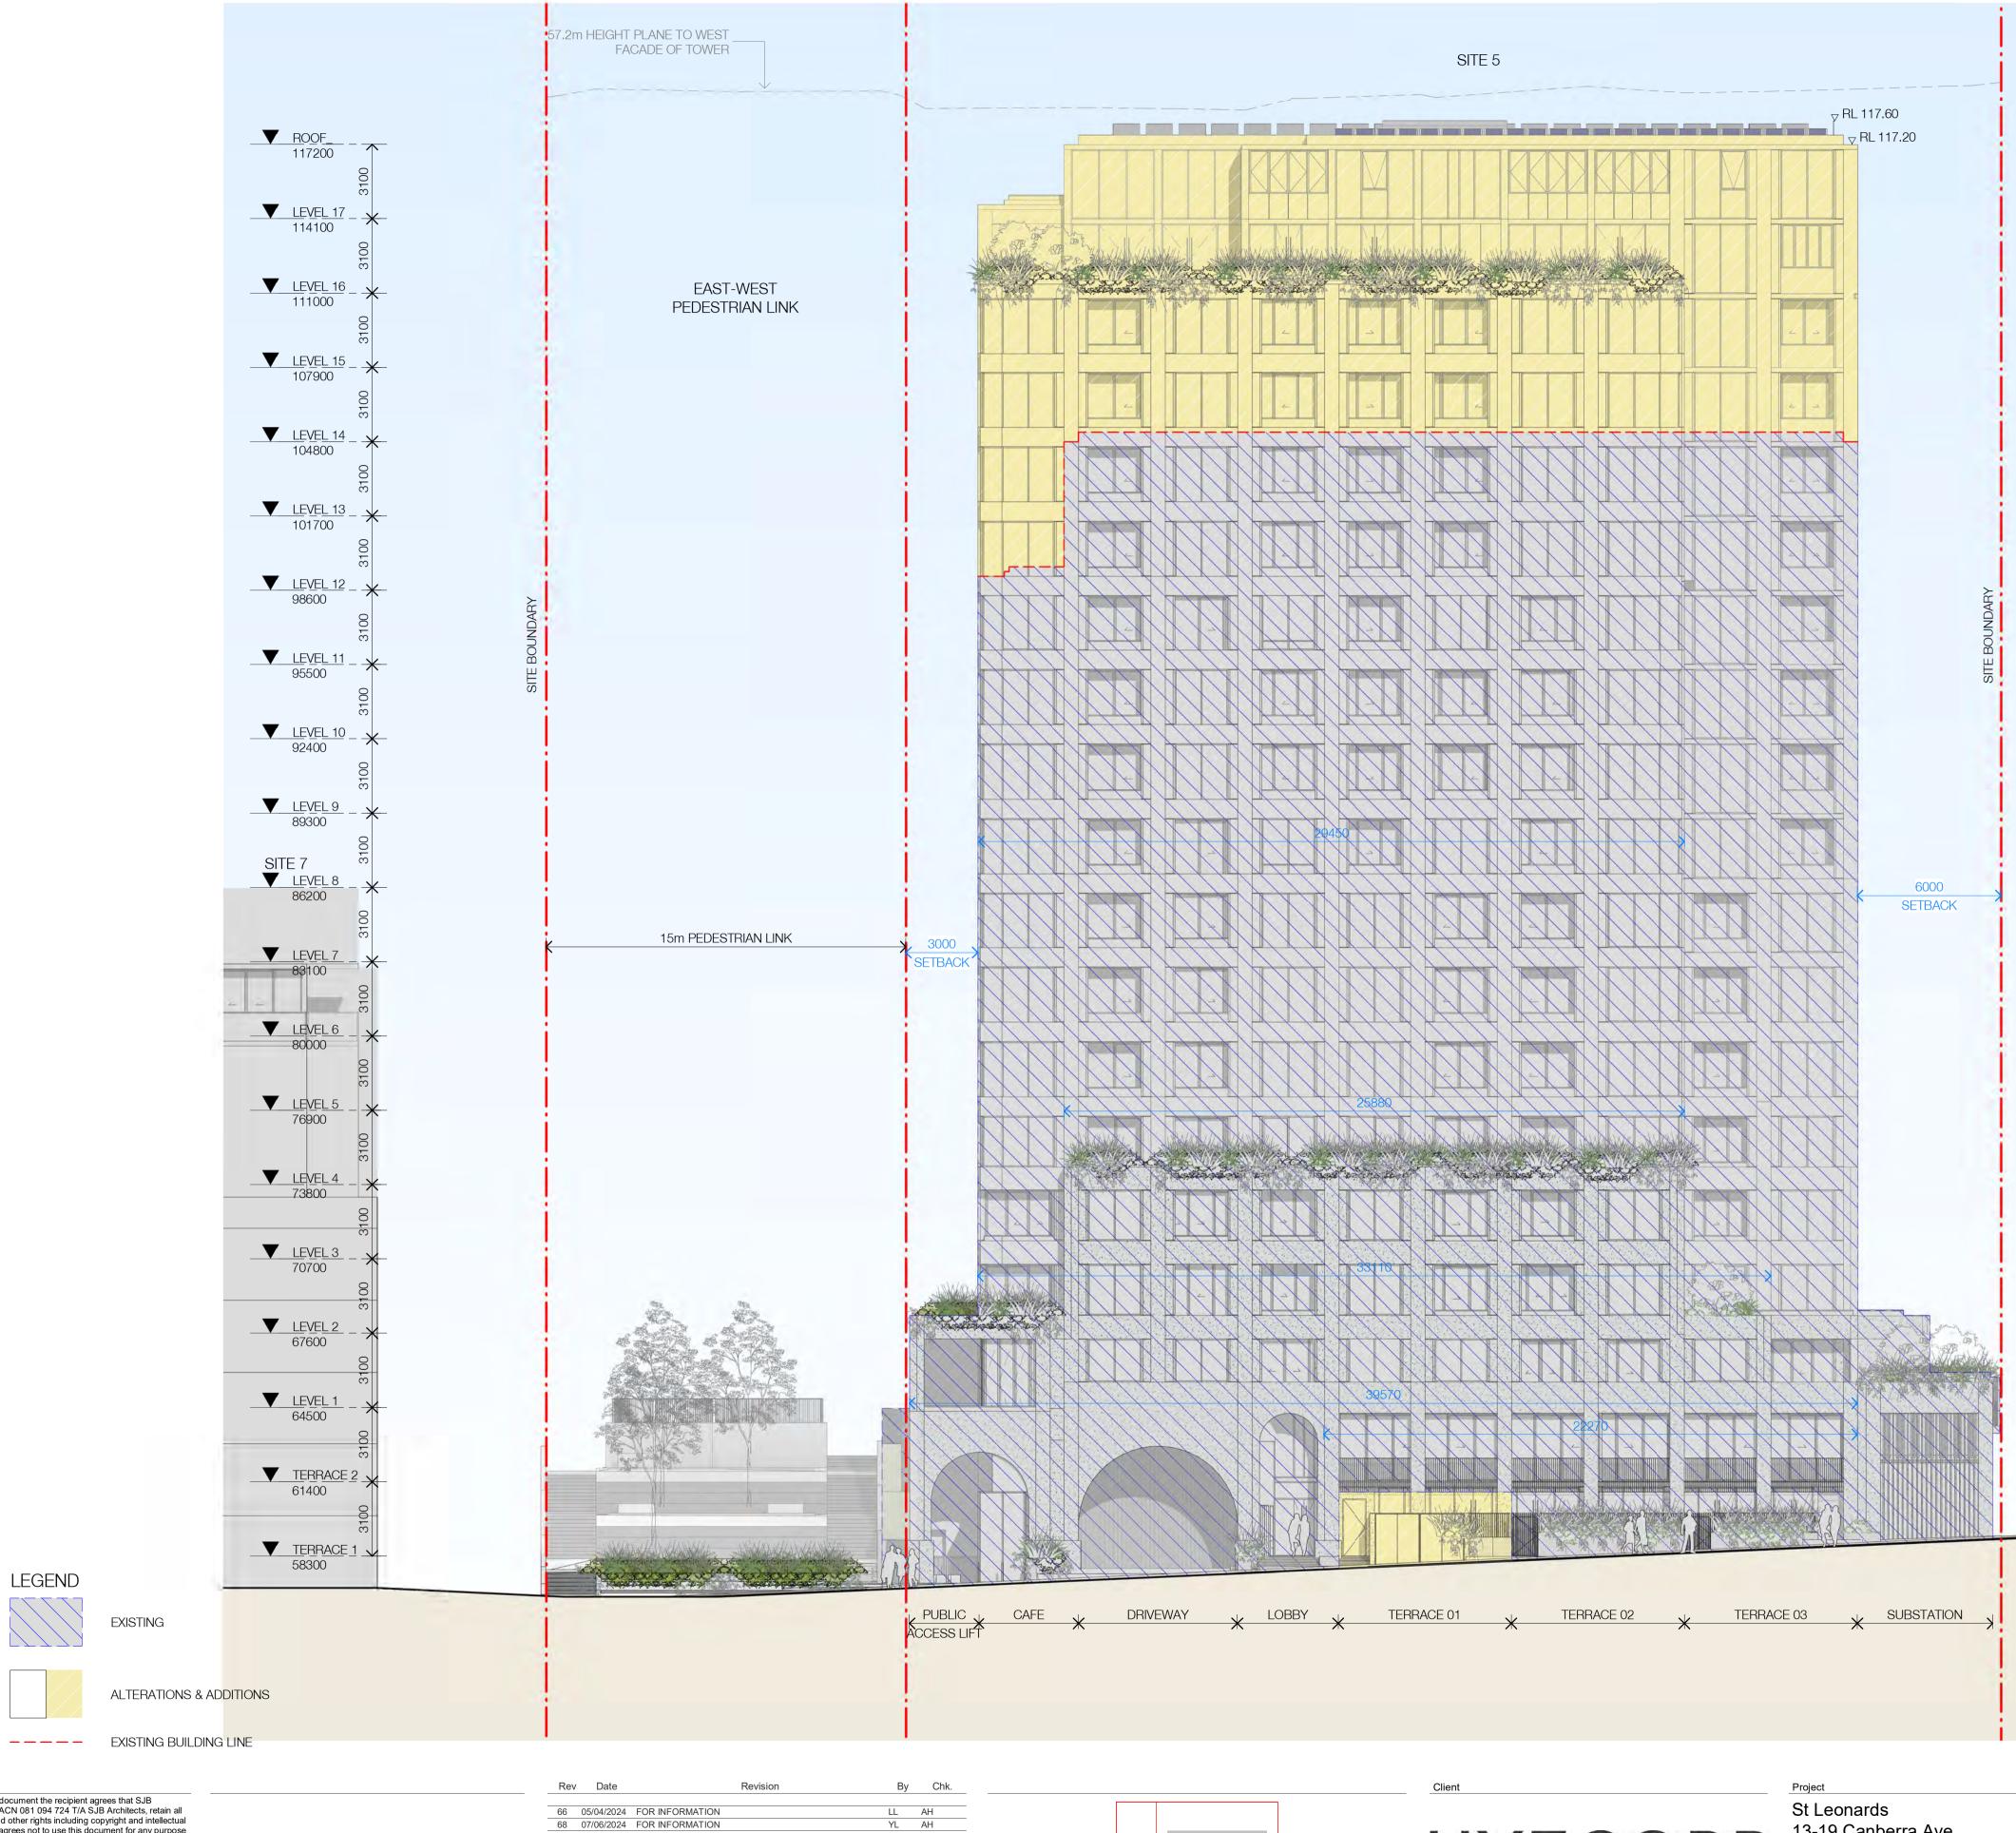Project St Leonards 13-19 Canberra Ave St Leonards Drawing Name WEST ELEVATION

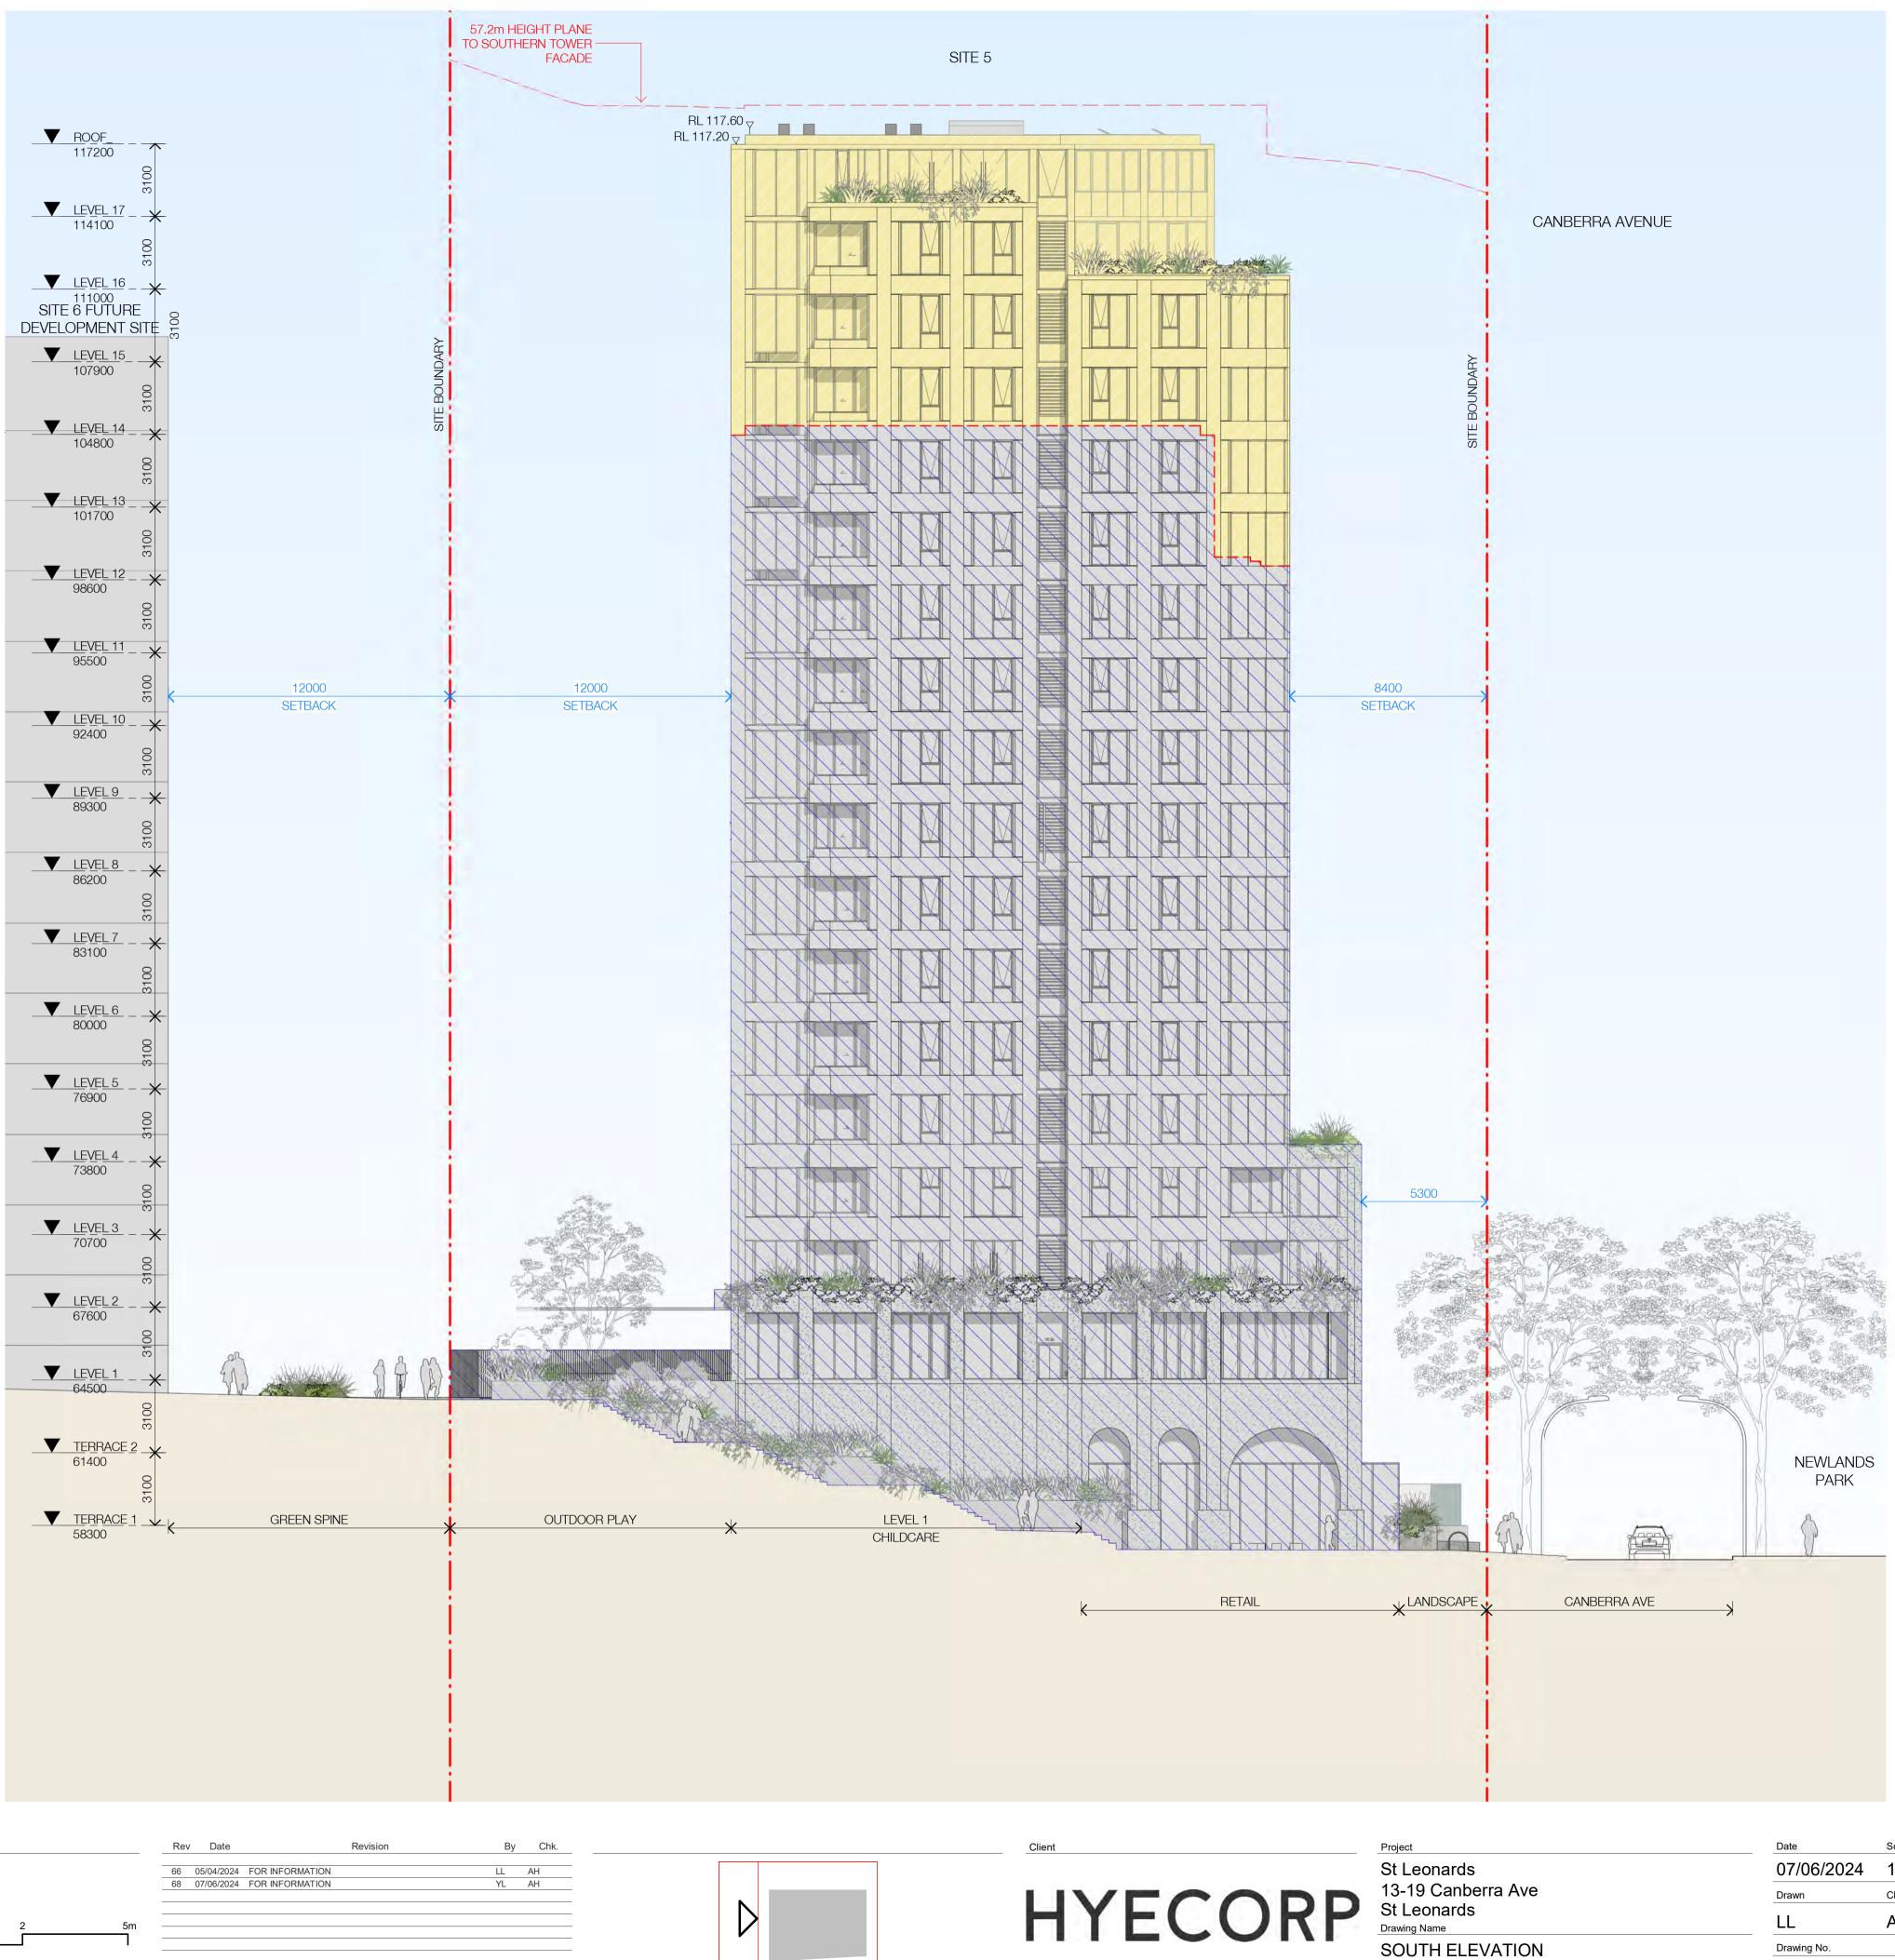

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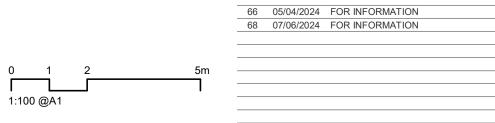



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Client

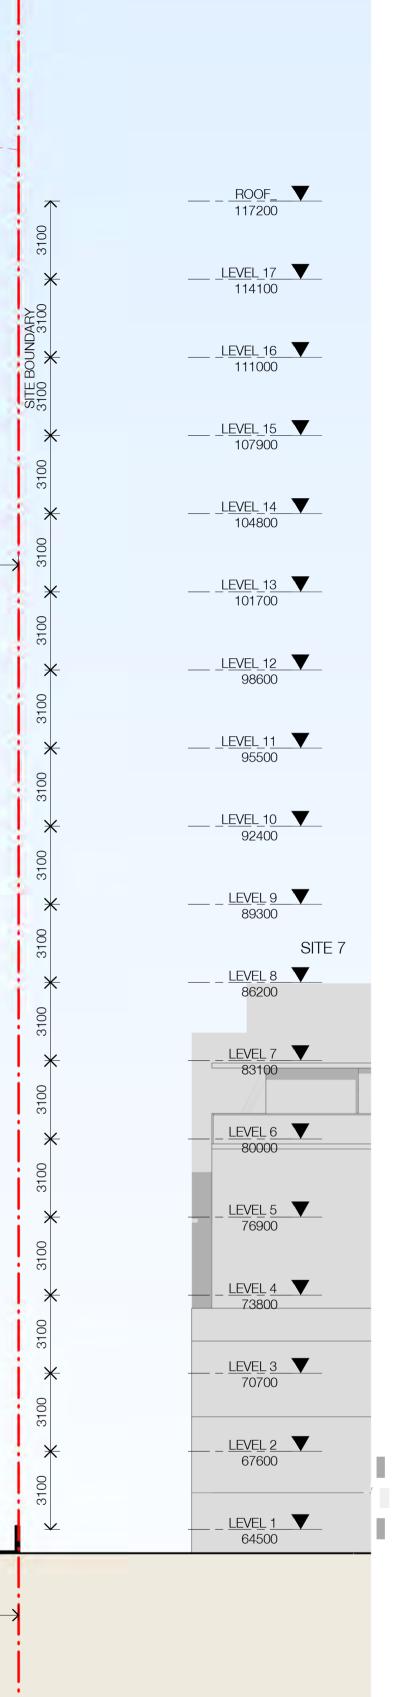Project St Leonards 13-19 Canberra Ave St Leonards Drawing Name **BUILDING SECTION 1**


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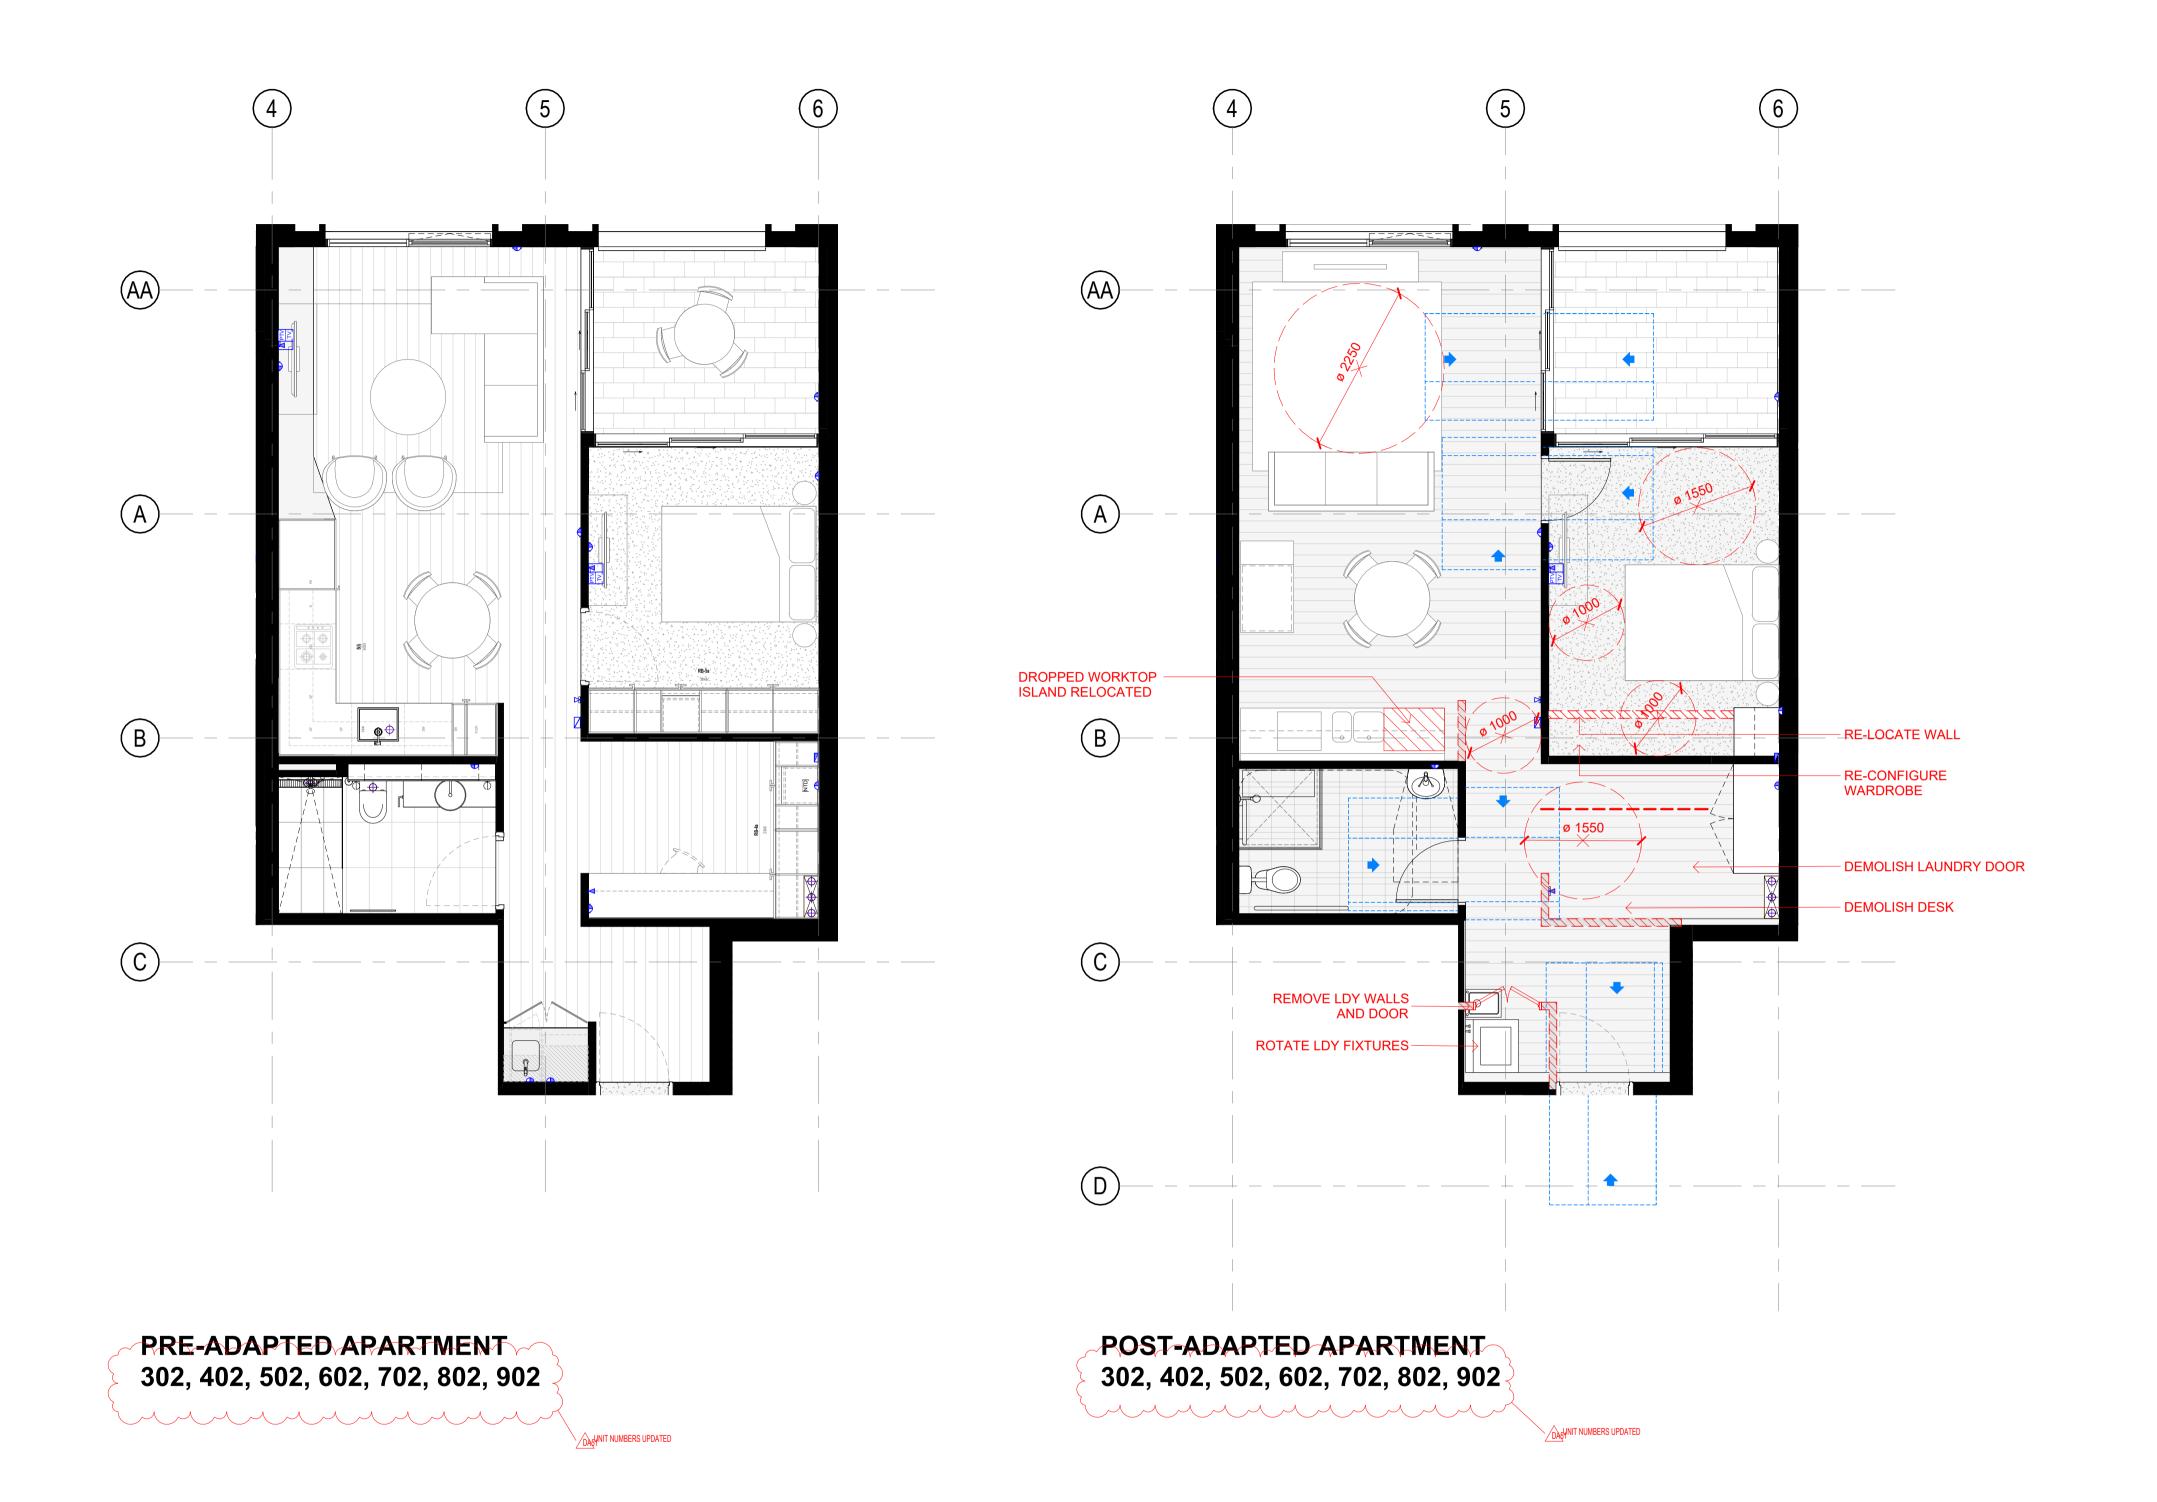




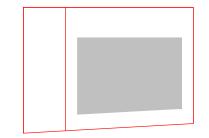

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	DA42	13/10/2021	FOR DA APPLICATION	LL	AH	DATE	REVISION	SCALE 1:50	
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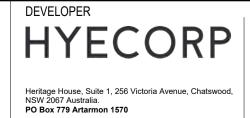
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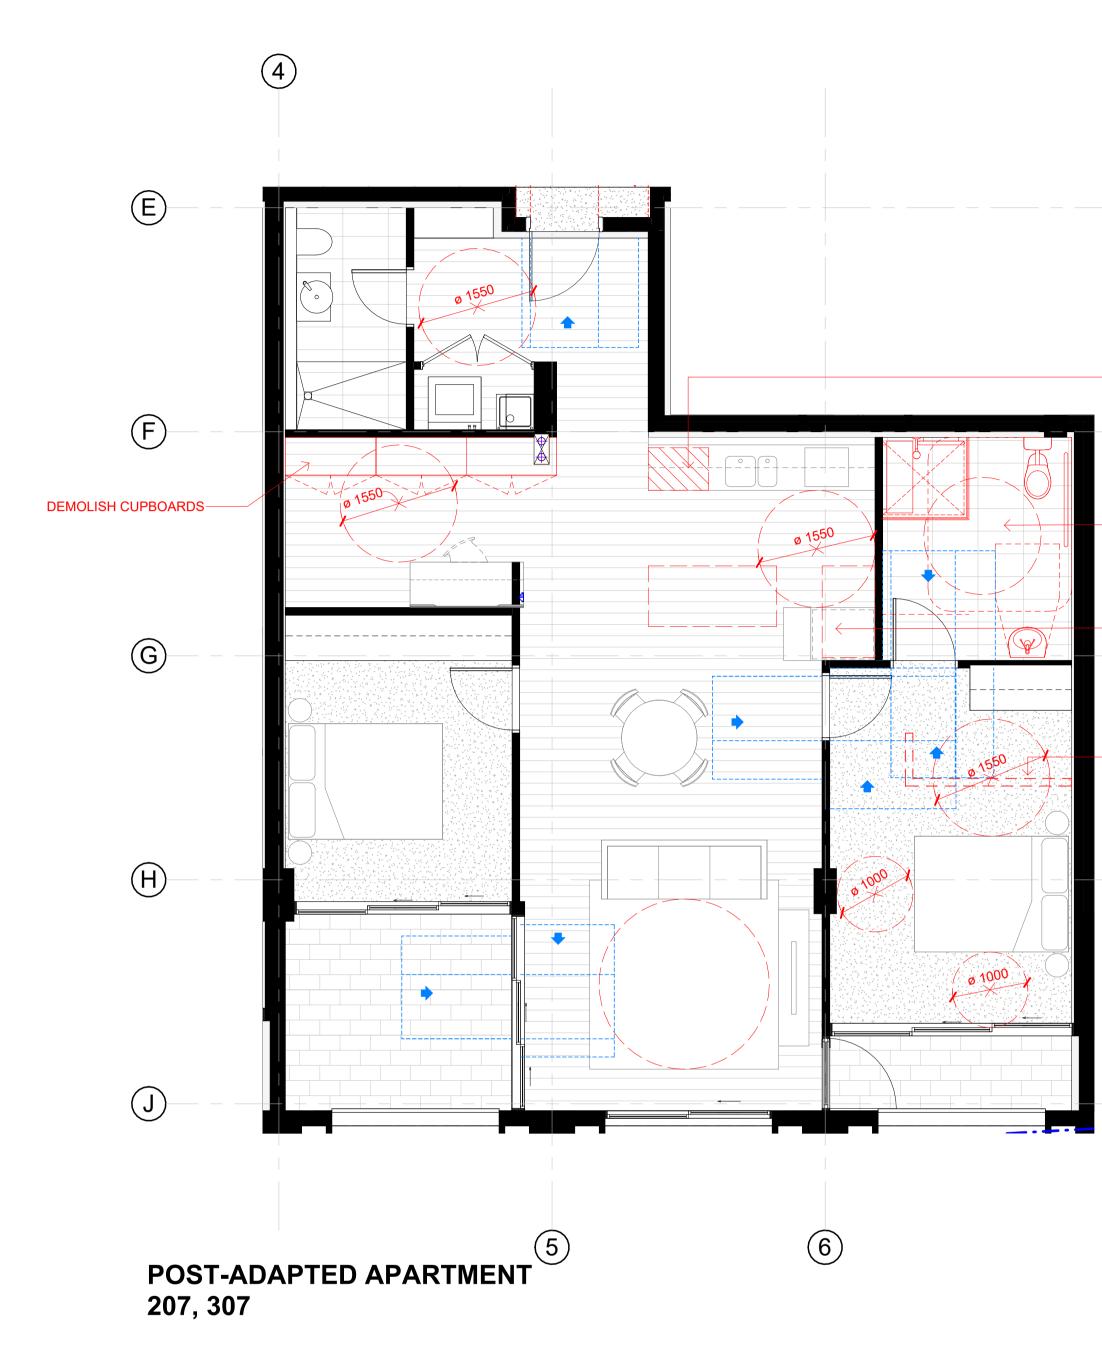
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- DROPPED WORKBENCH

KITCHEN ISLAND WITH 1500mm CLEARANCE FOR POST ADAPTED LAYOUT

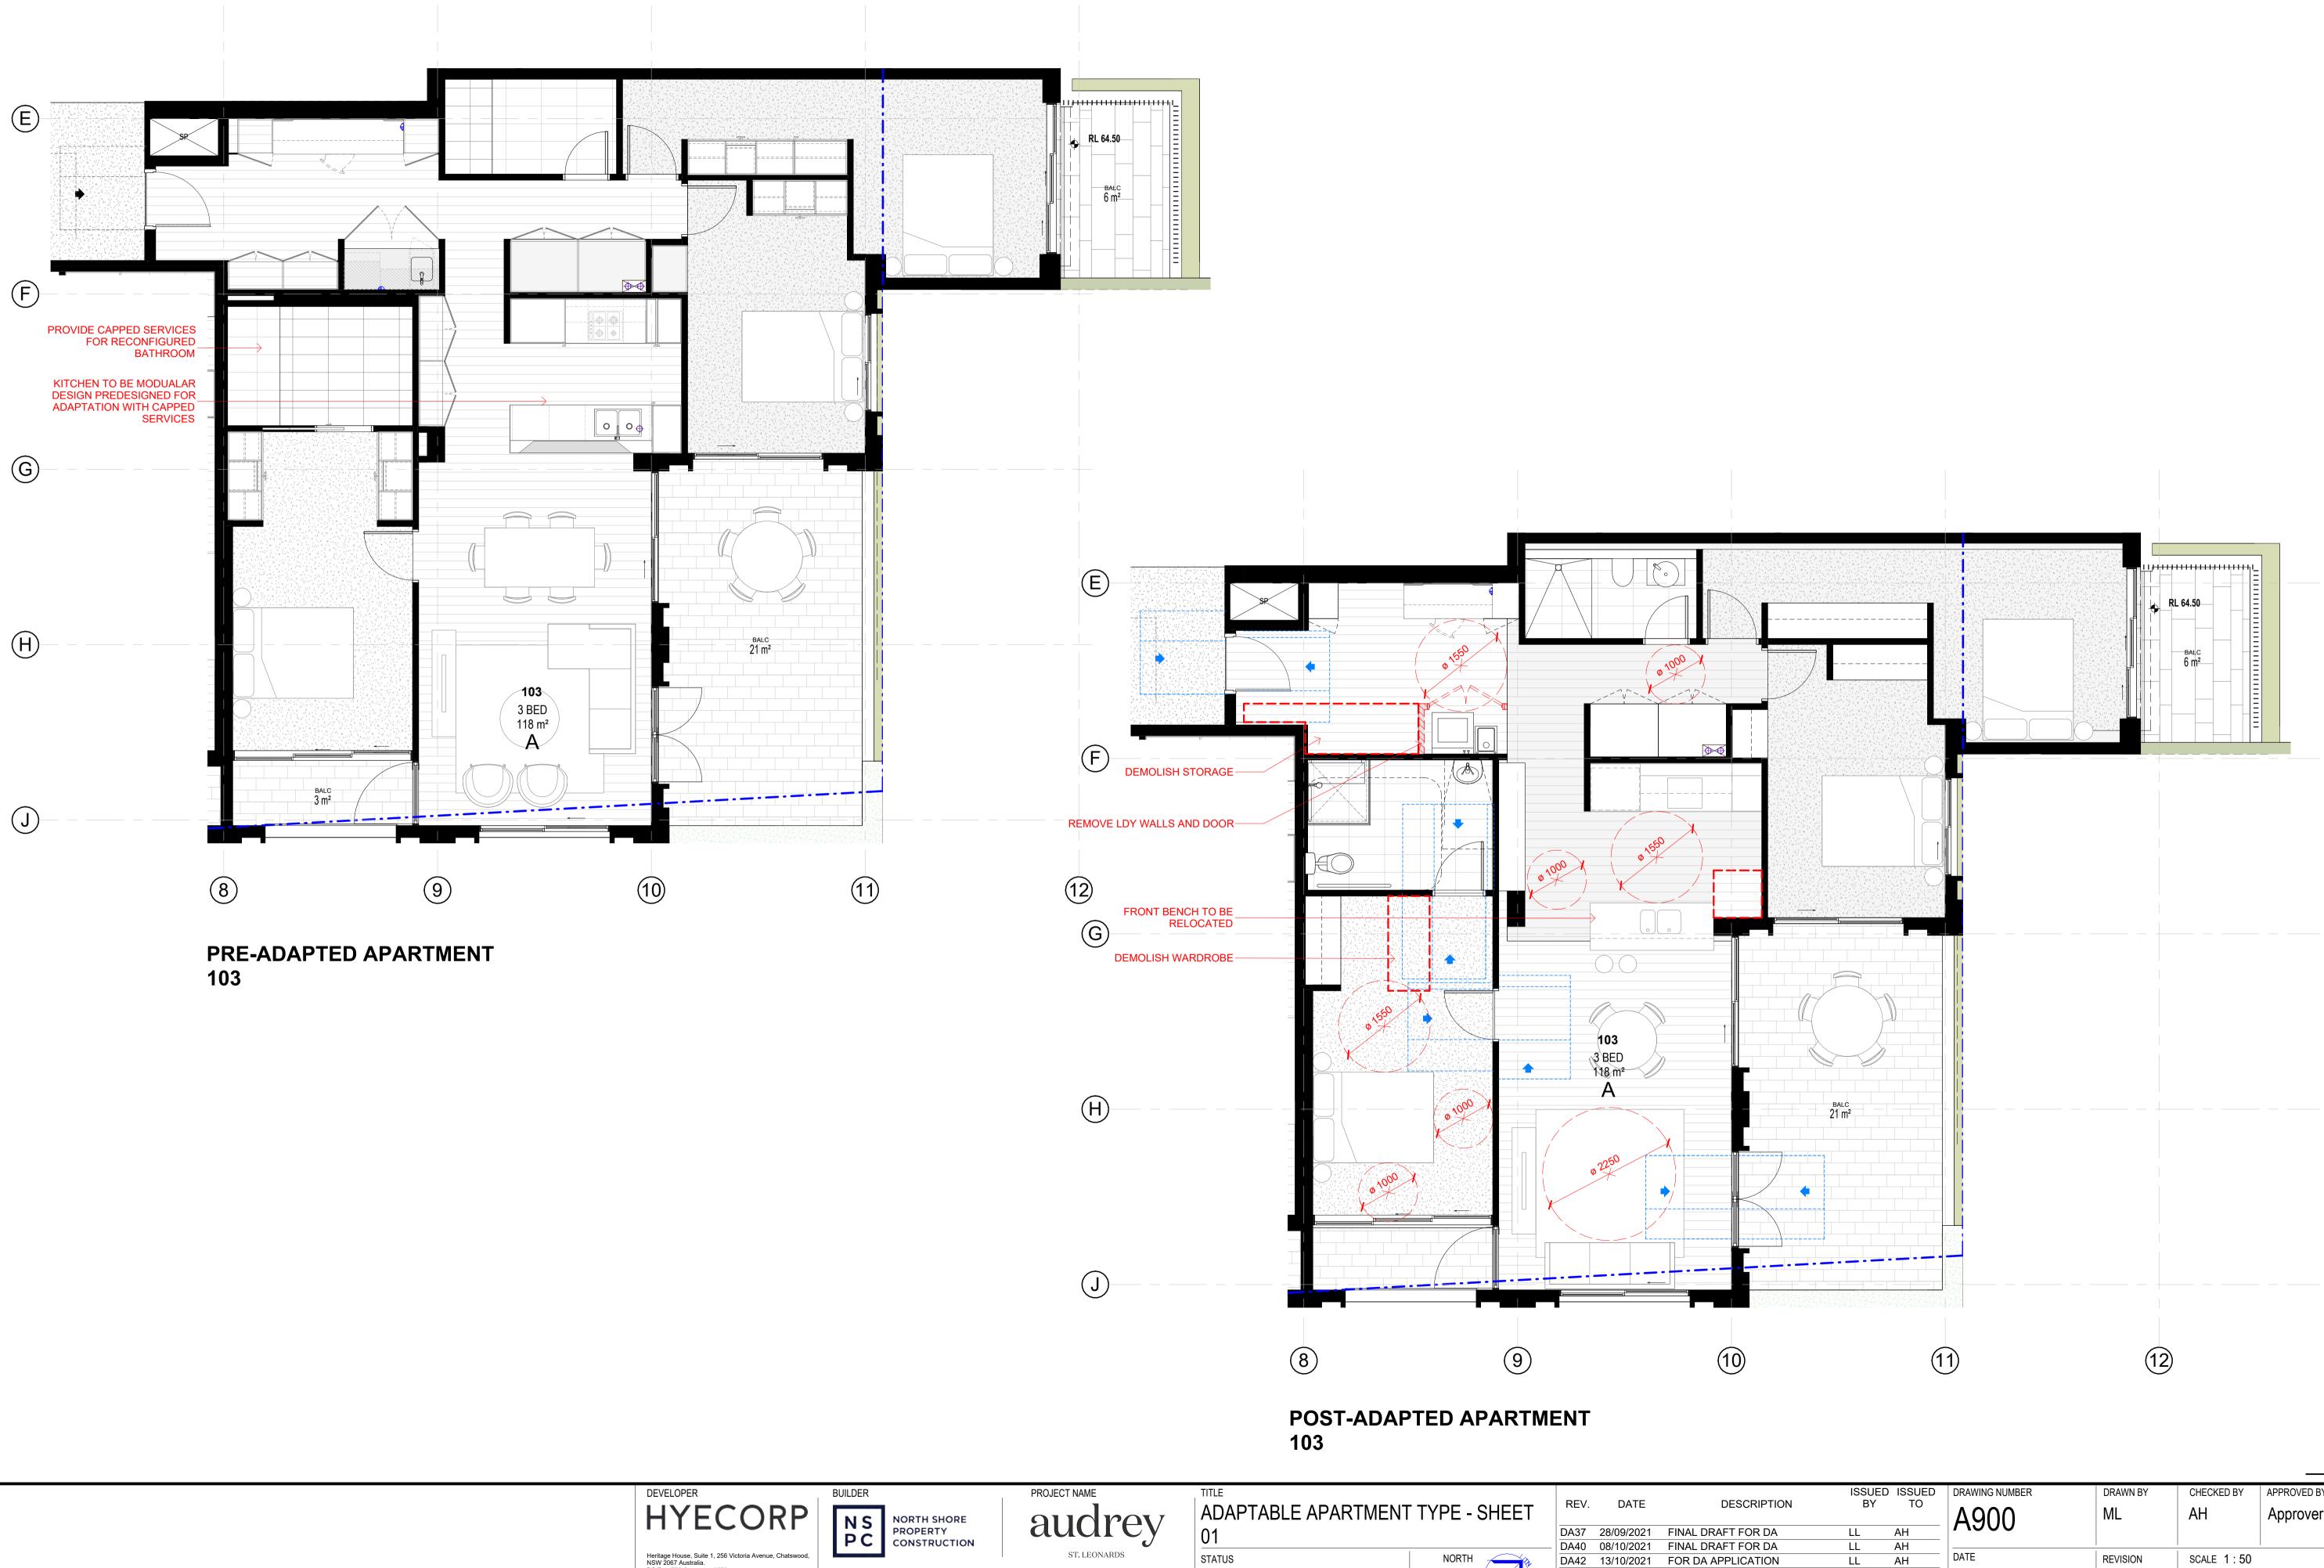- DEMOLISH WALL RELOCATE WARDROBE

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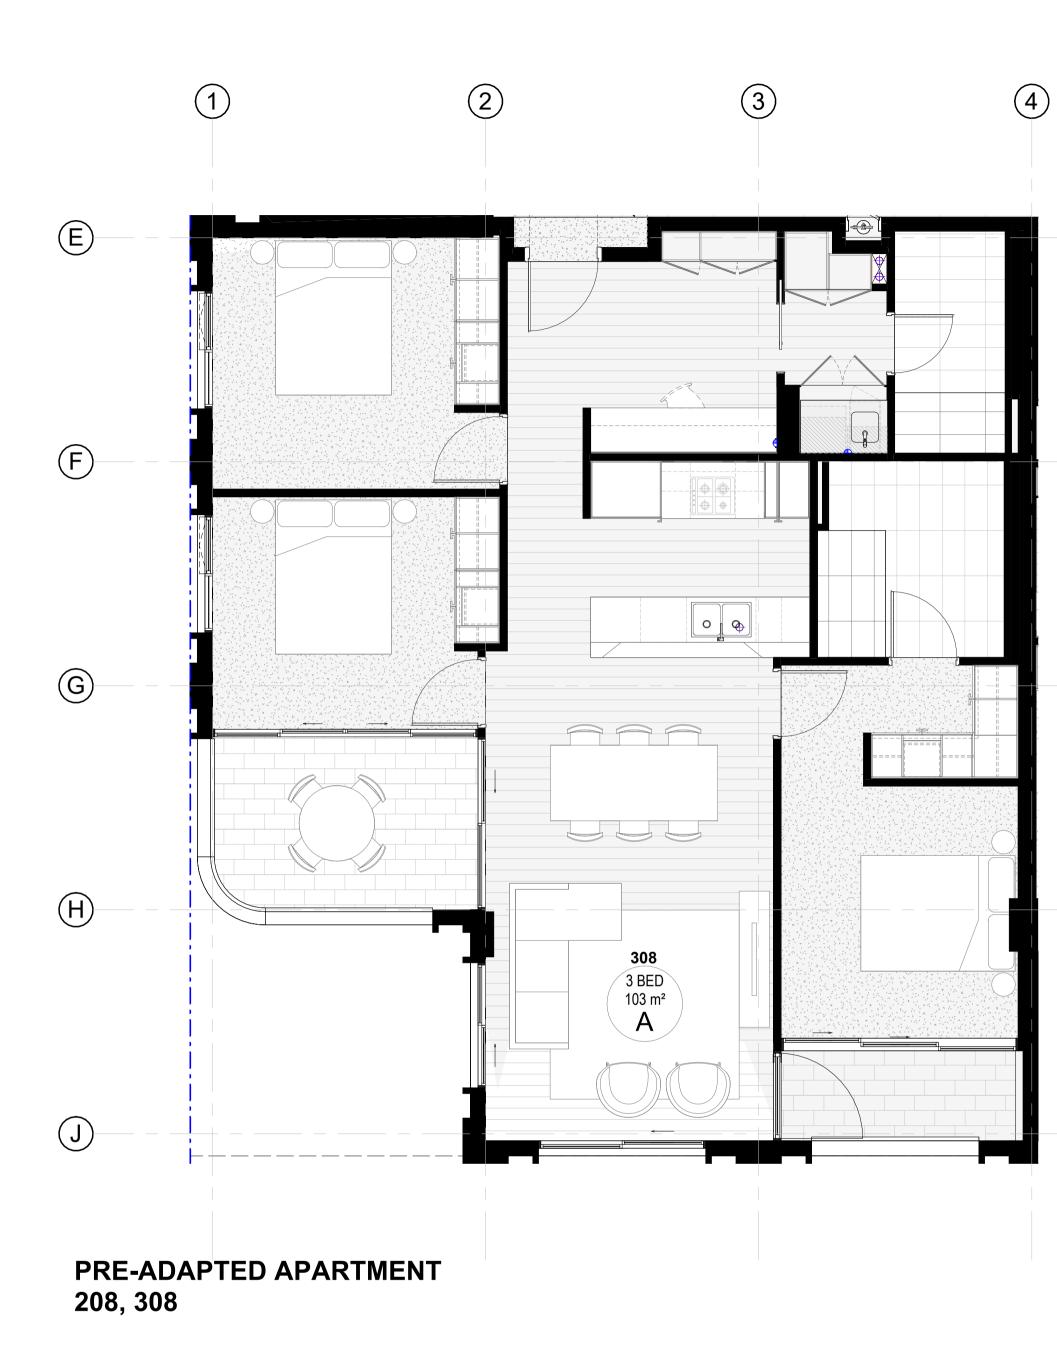
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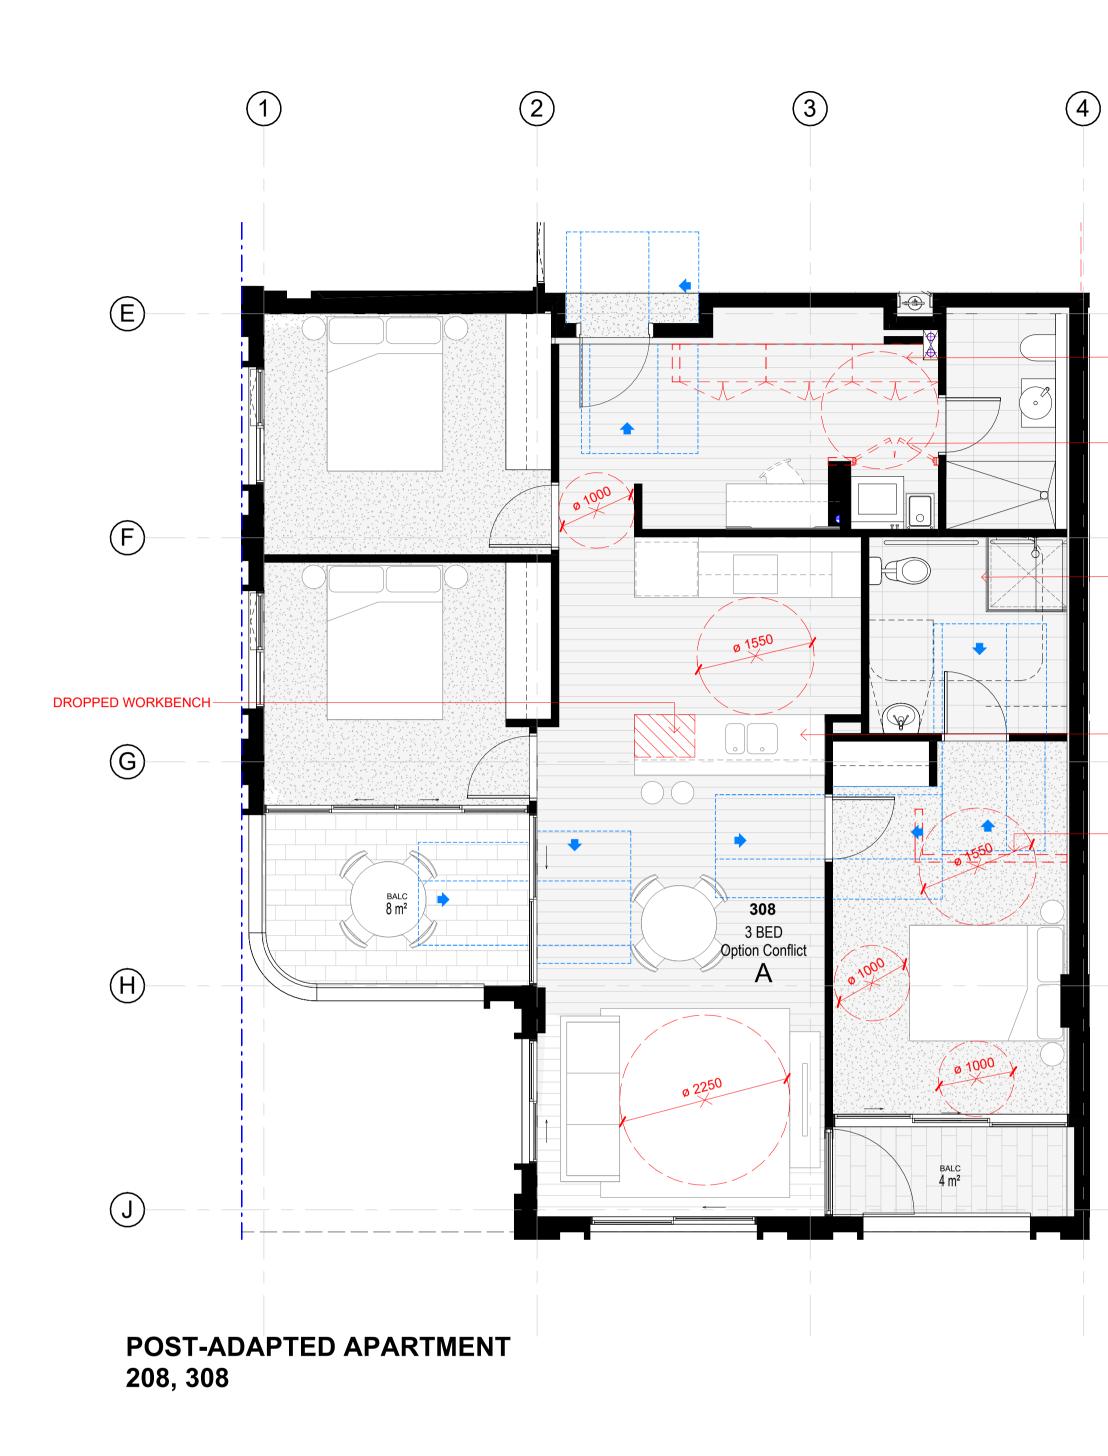
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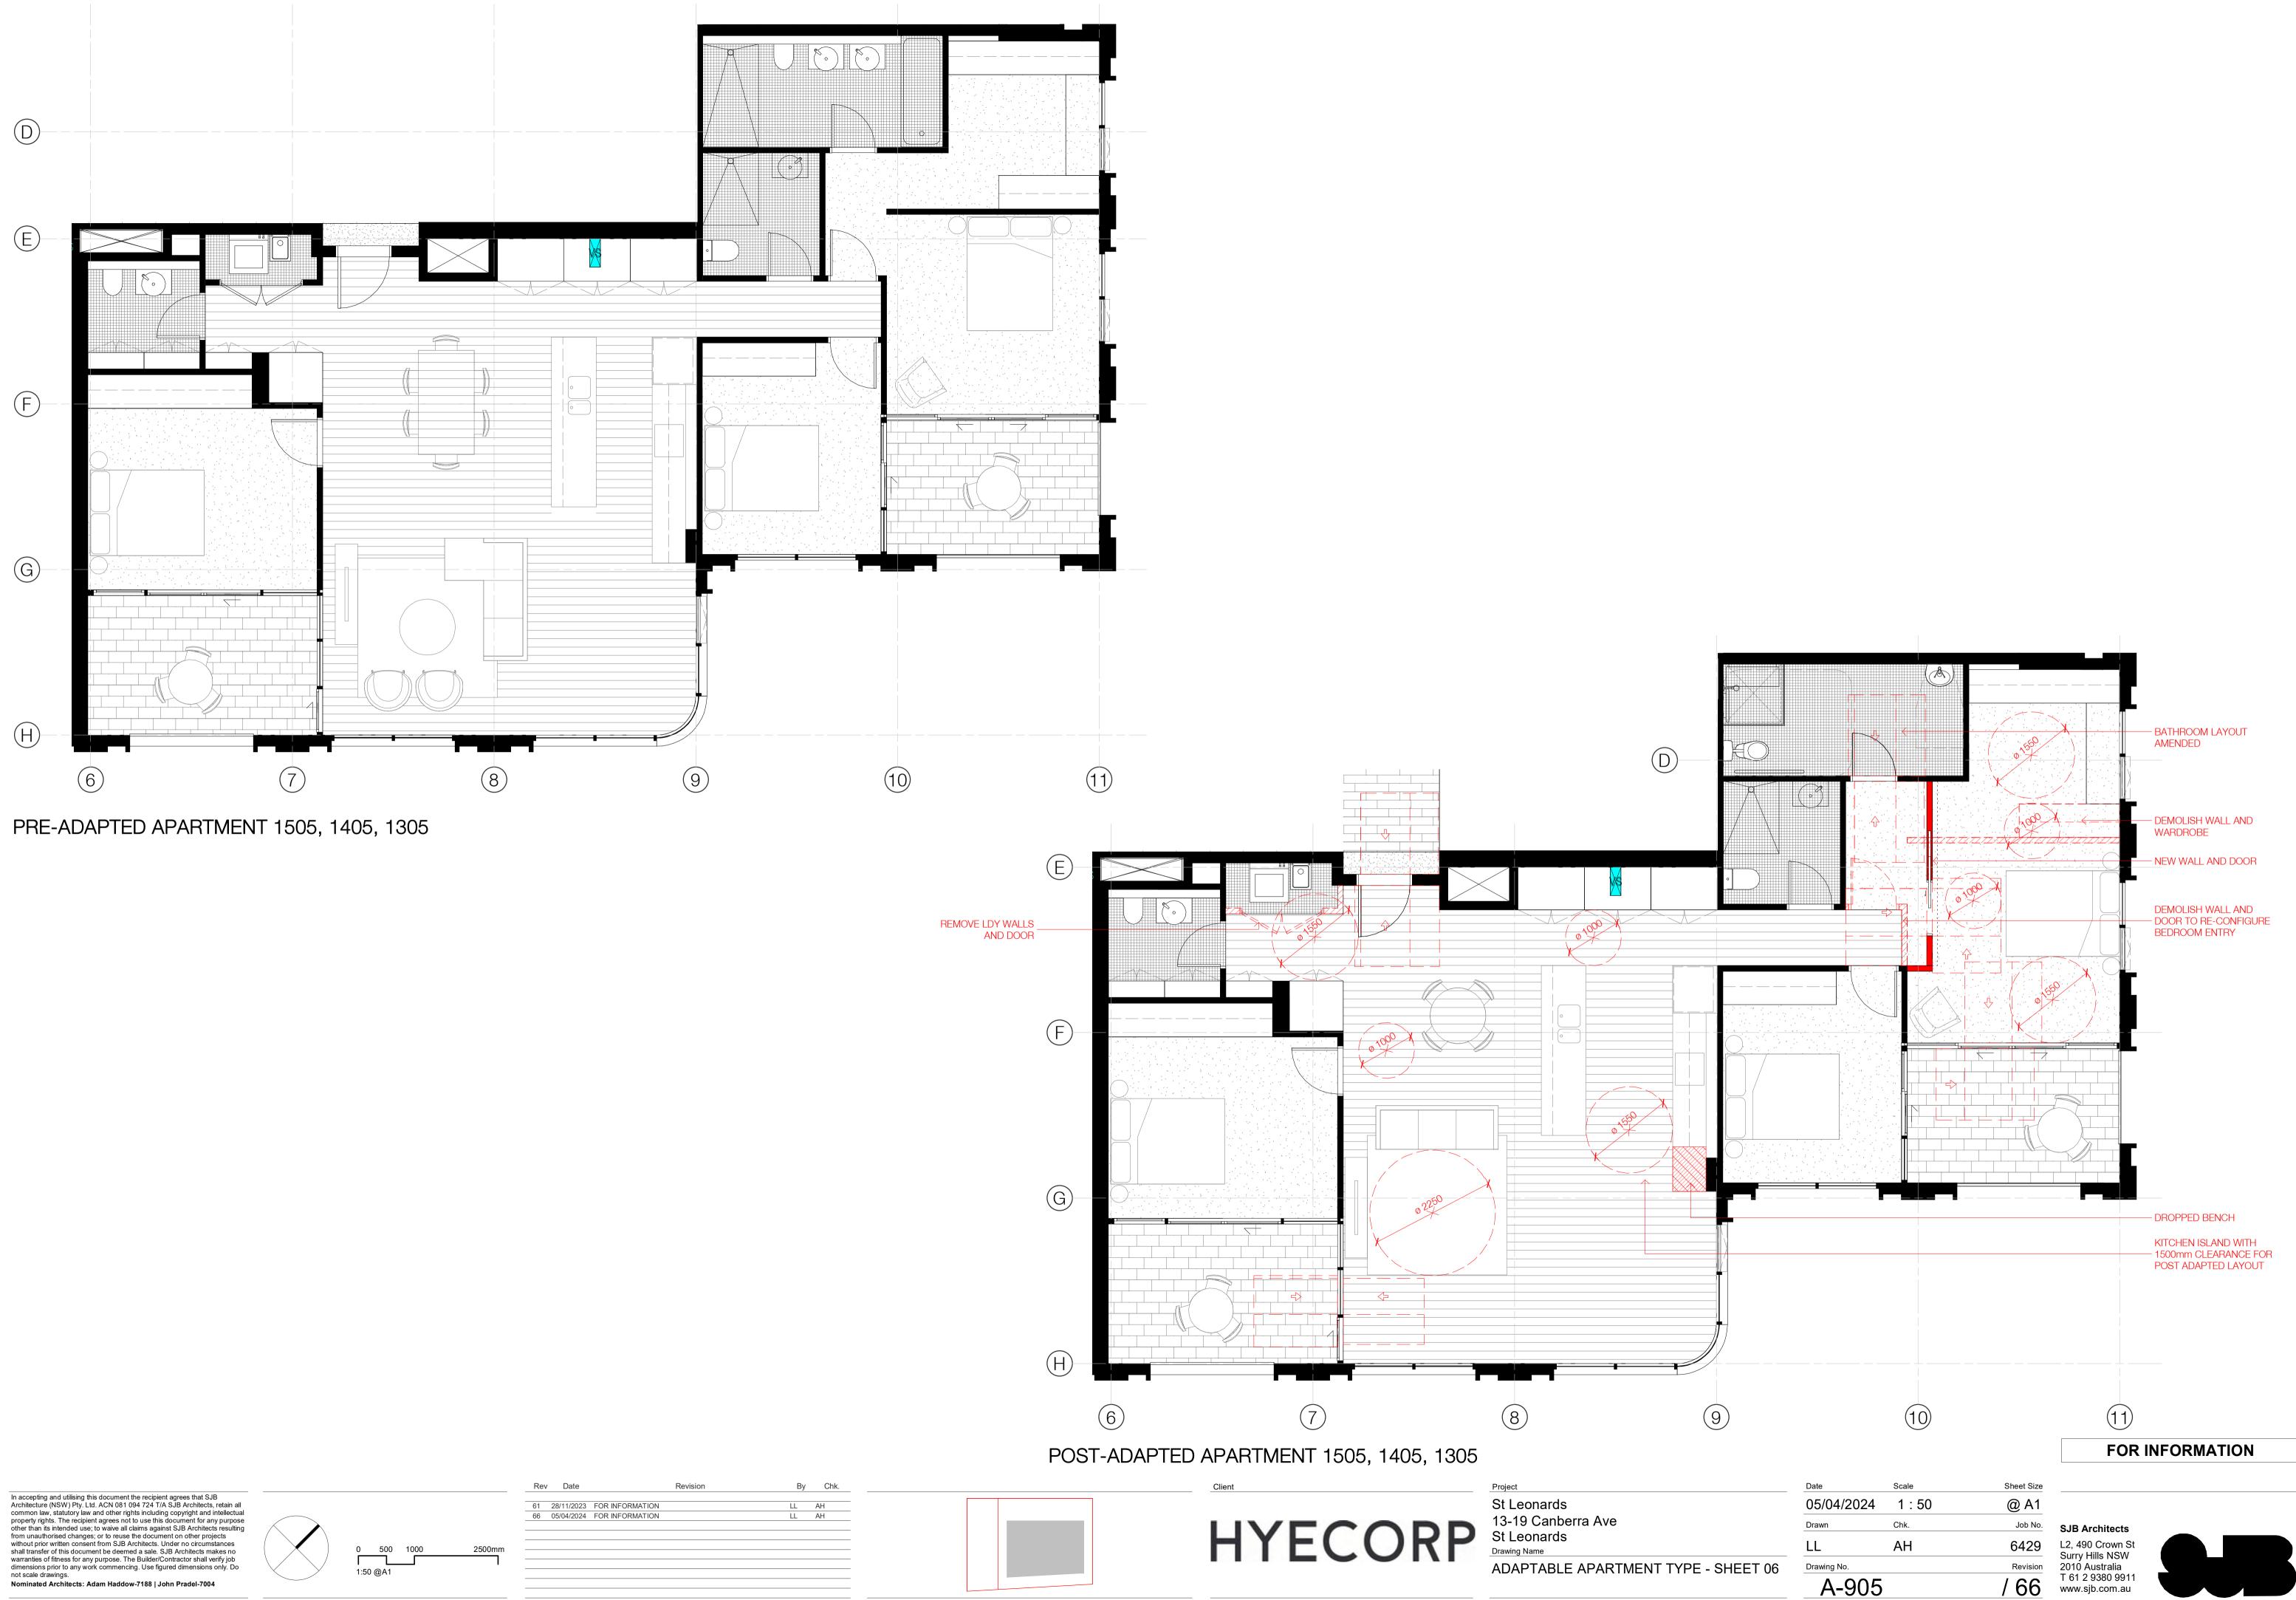
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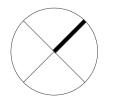
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KITCHEN ISLAND WITH 1500mm CLEARANCE FOR POST ADAPTED LAYOUT


– DEMOLISH WALL RELOCATE WARDROBE

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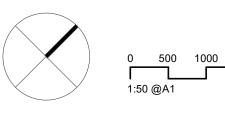


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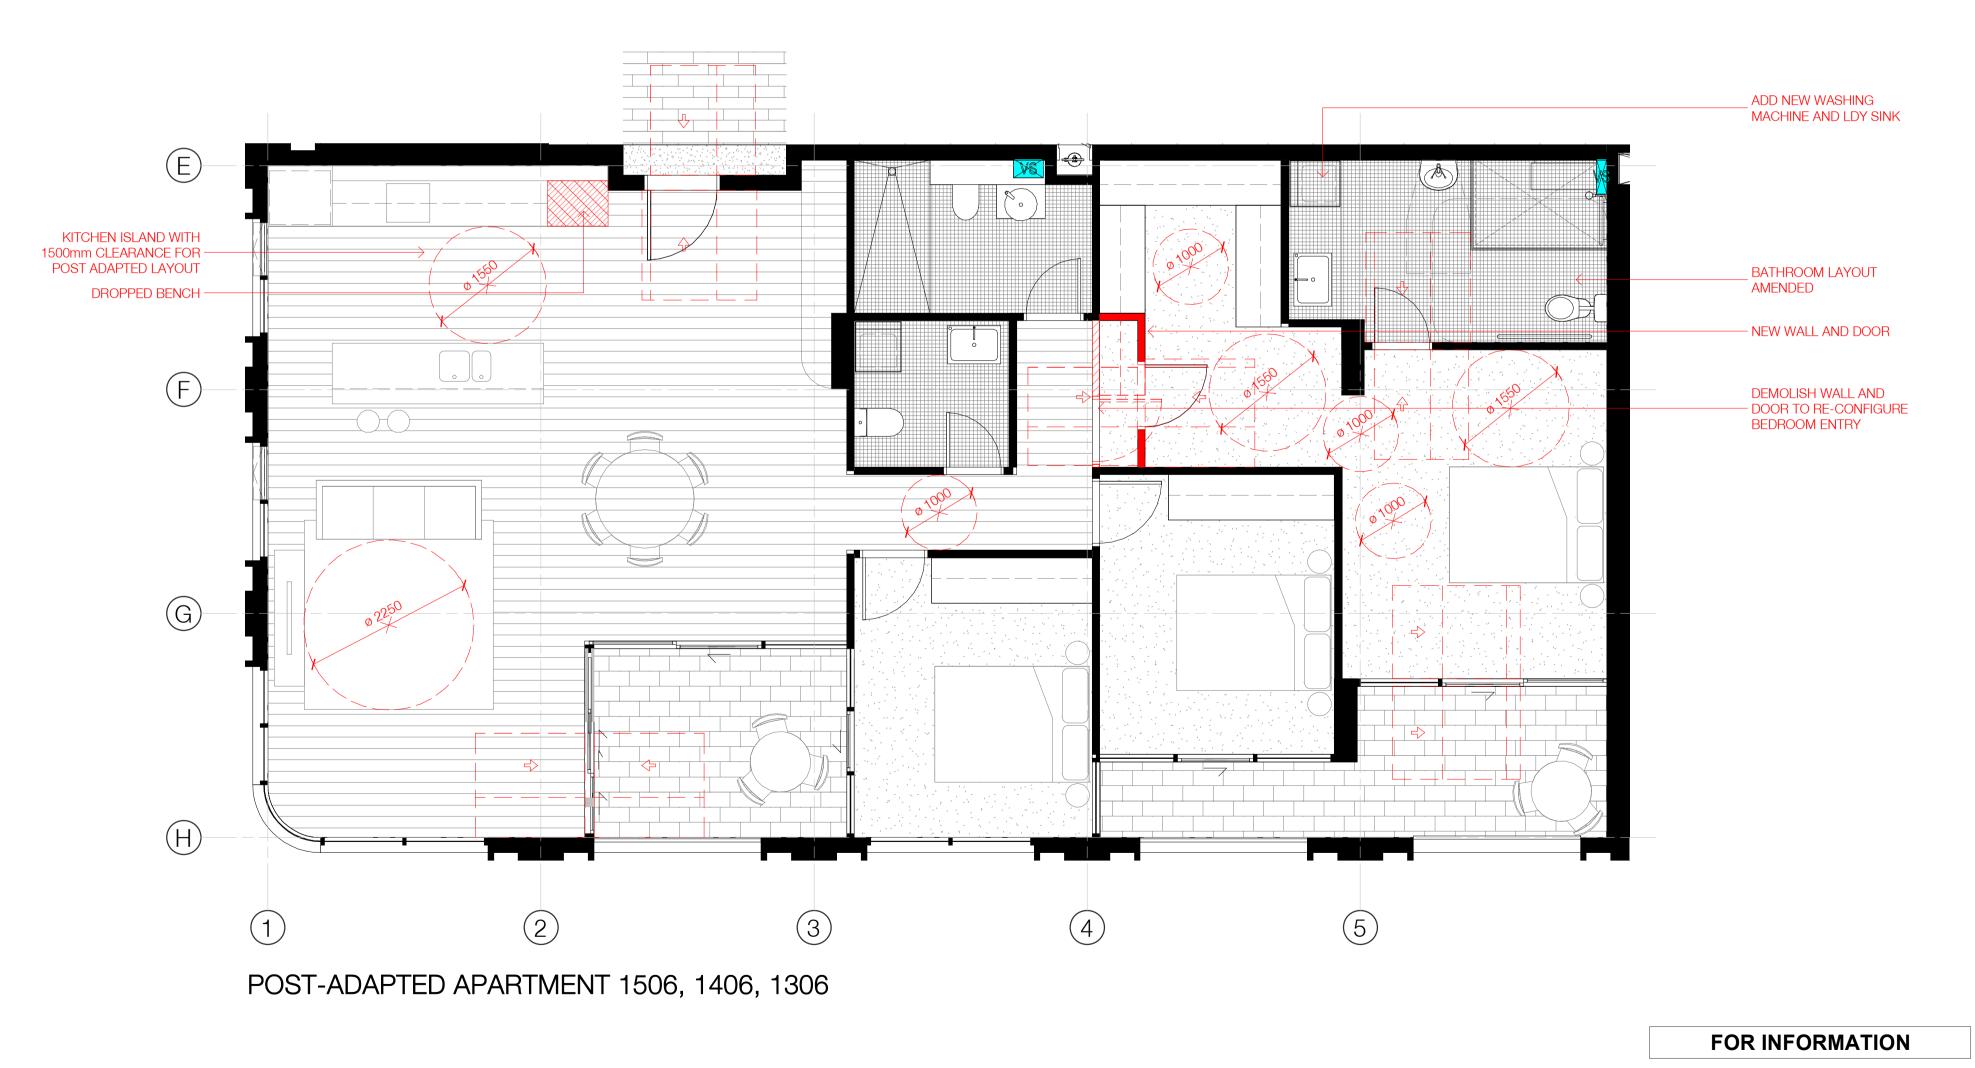
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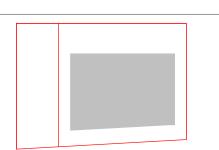
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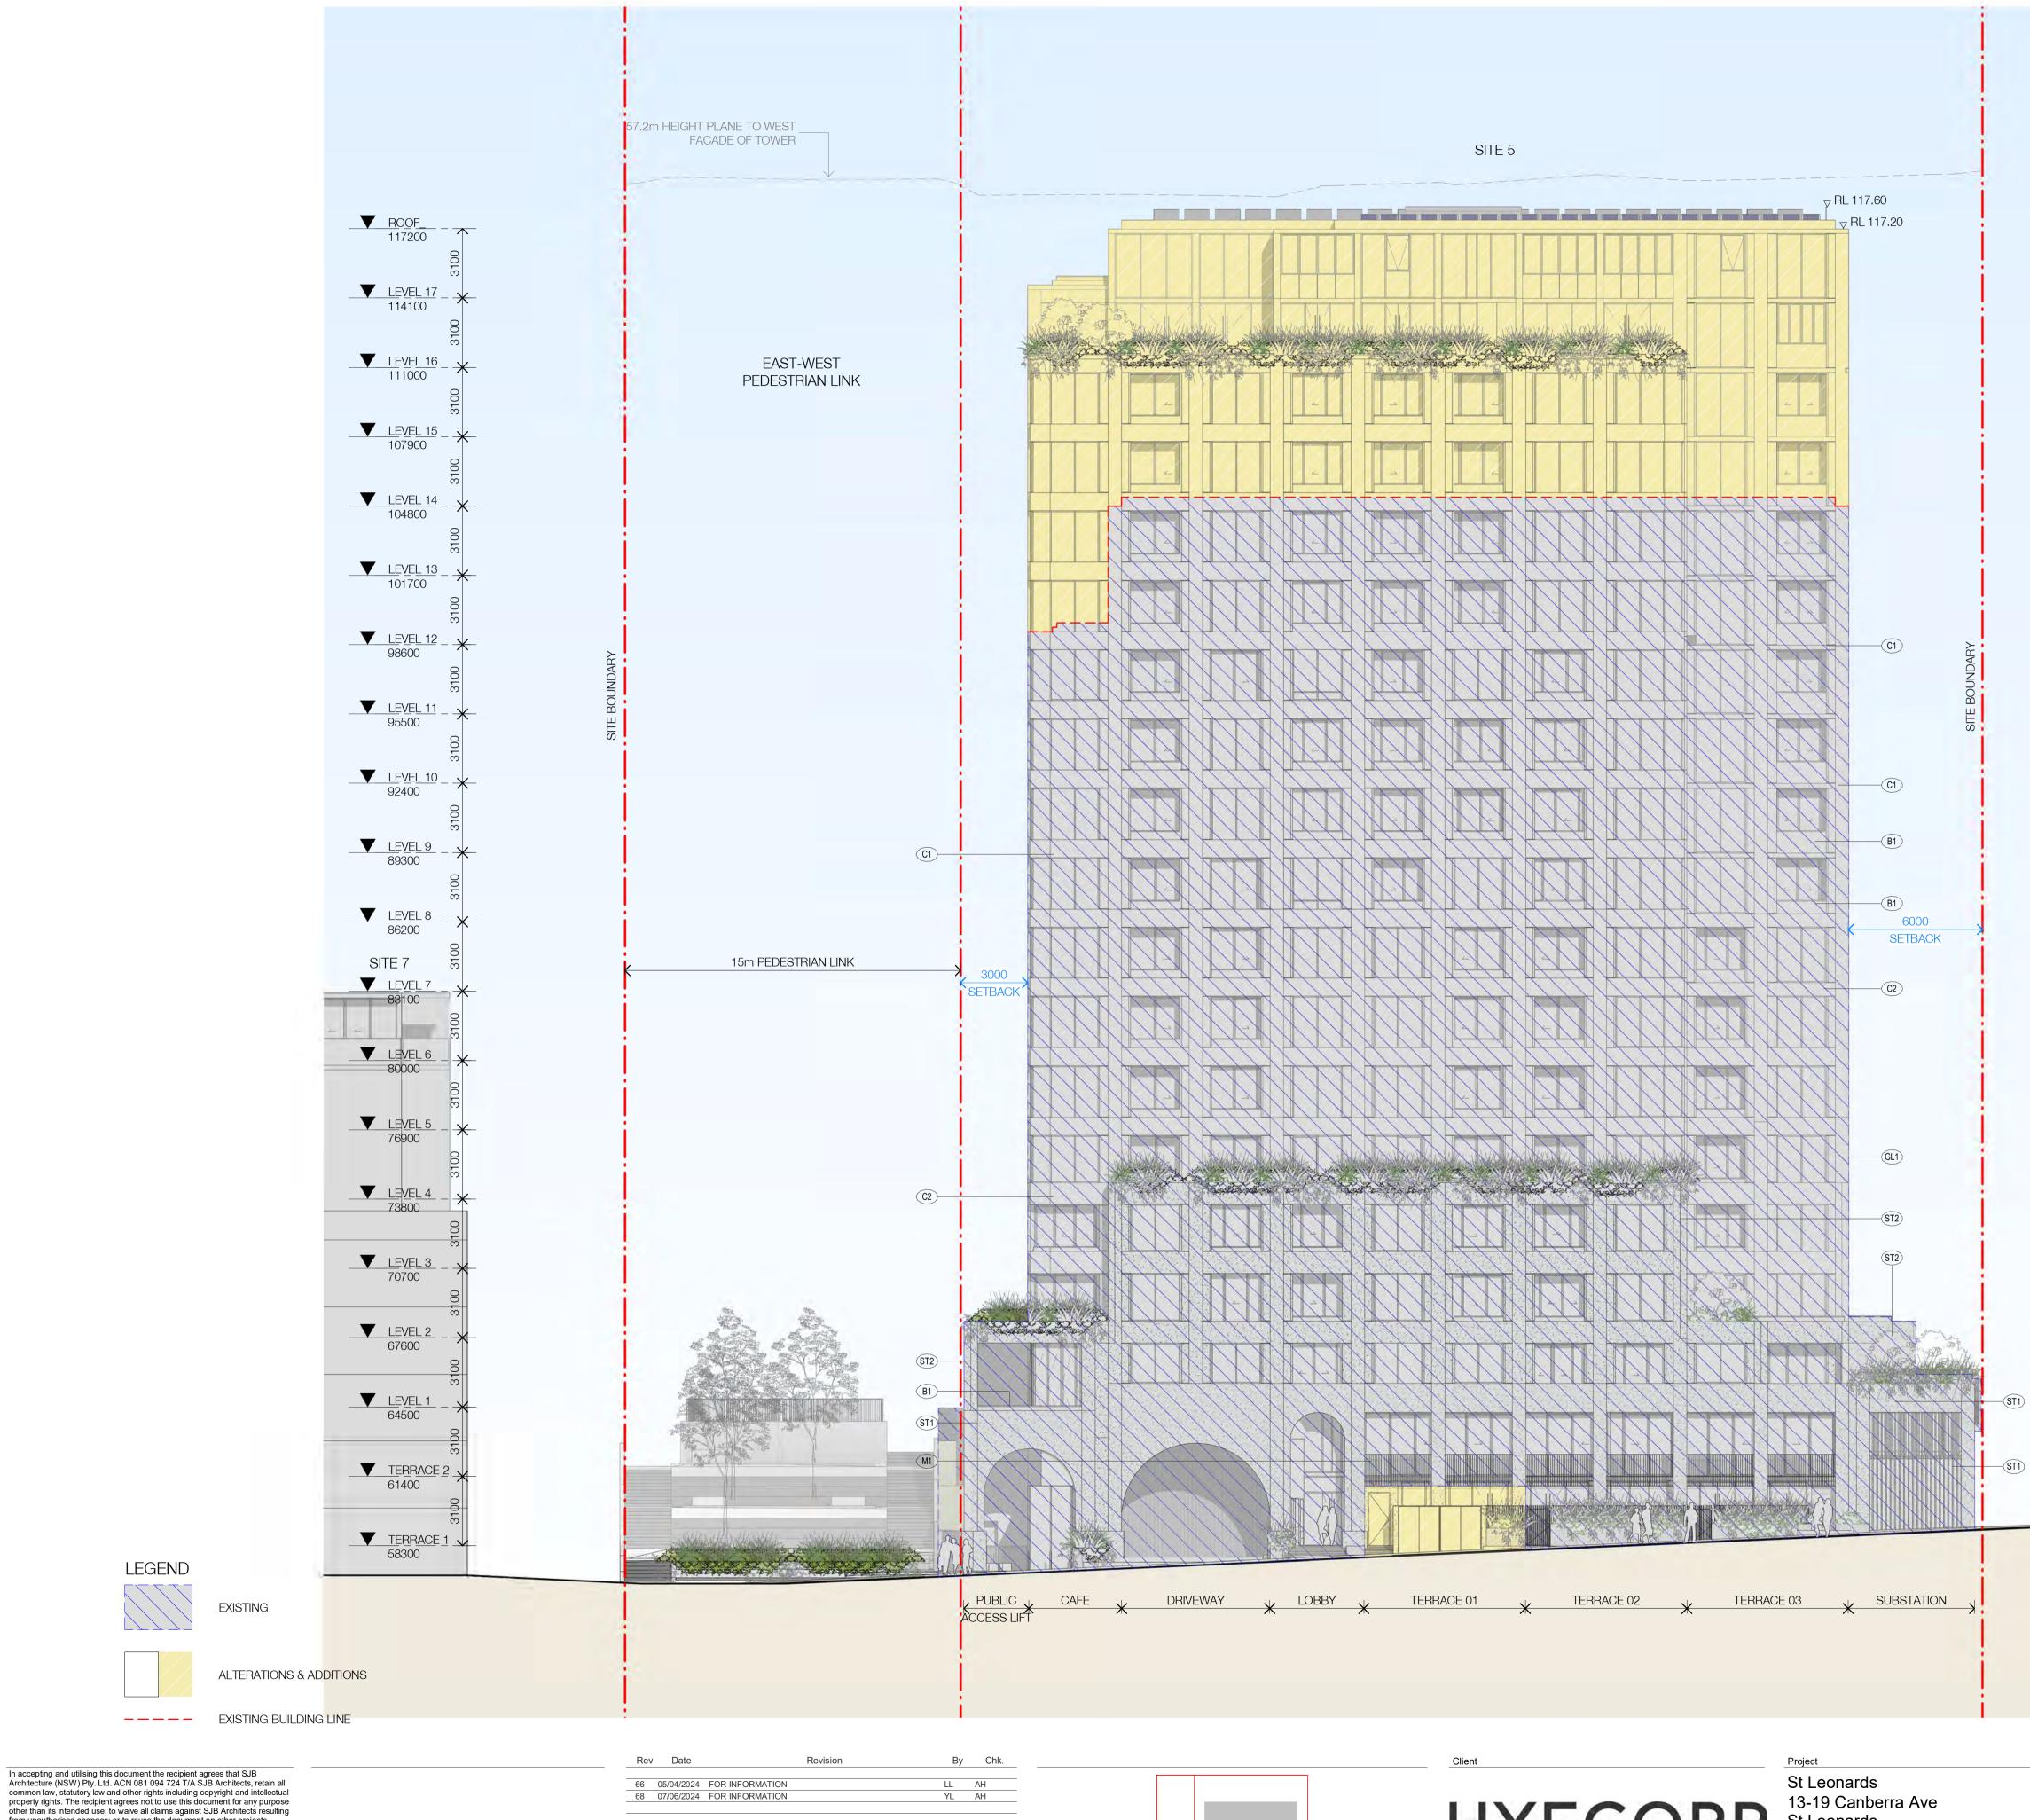


Project St Leonards 13-19 Canberra Ave St Leonards Drawing Name ADAPTABLE APARTMENT TYPE - SHEET 07

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St Leonards 13-19 Canberra Ave St Leonards Drawing Name EAST ELEVATION - MATERIALS AND FINISHES

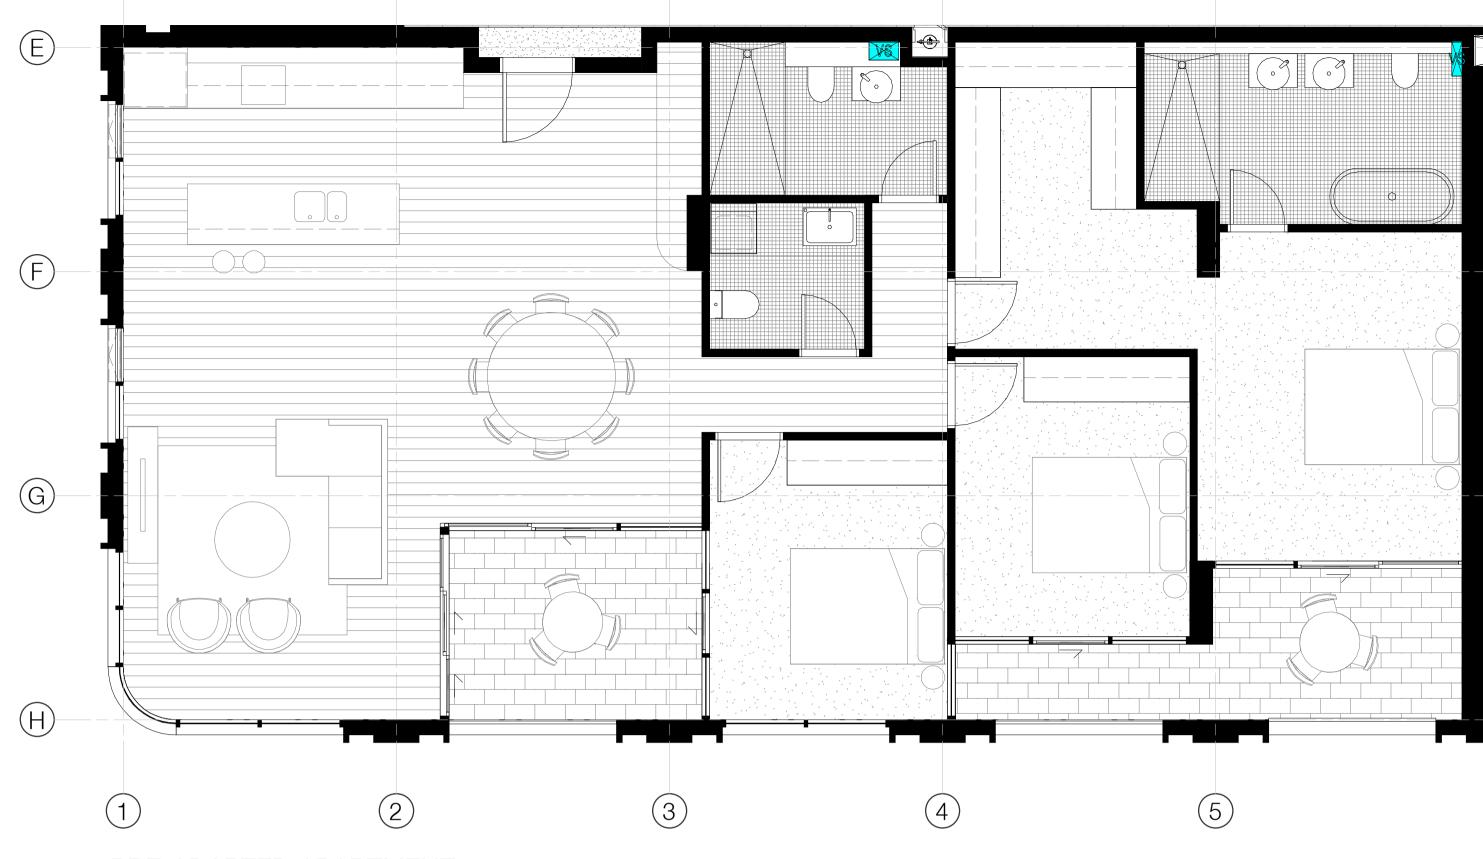SITE 3		
	SITE 3	

EXTERNAL FINISHES

CONCRETE/FC C01 Concrete Finish - Stained White C02 Concrete Finish - Stained Green

GLASS GL1 Apartment Glazing - Performance Glass

METALWORK M1 Aluminium

PAINT

PT01 White PT02 Dark Grey

BALUSTRADE B1 Aluminium Framed - Clear Glass

C02

M1

STONE

ST01Green MarbleST02Green Terrazzo

C01

GL01

PT1

ST01

PT2 ST02

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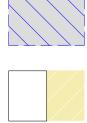
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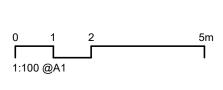


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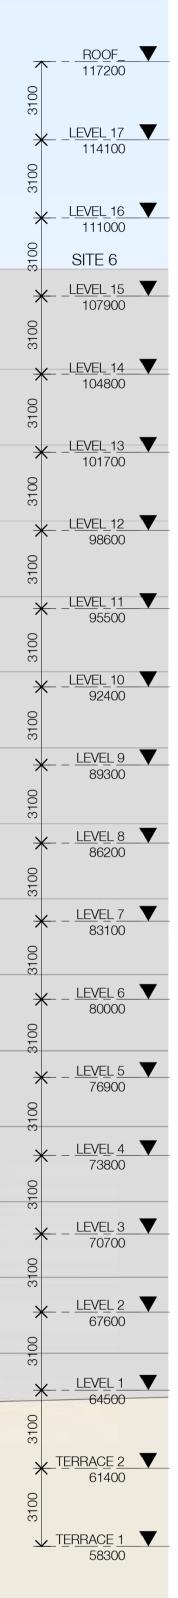
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13-19 Canberra Ave St Leonards Drawing Name NORTH ELEVATION - MATERIALS AND FINISHES



CONCRETE/FC C01 Concrete Finish - Stained White

EXTERNAL FINISHES

C02 Concrete Finish - Stained Green

GLASS GL1 Apartment Glazing - Performance Glass

METALWORK M1 Aluminium

PAINT PT01 White

PT02 Dark Grey BALUSTRADE

B1 Aluminium Framed - Clear Glass

STONE


ST01 Green Marble ST02 Green Terrazzo

C01

GL01

M1

C02

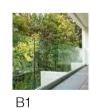

PT1

ST01




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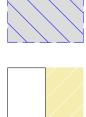
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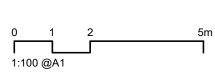


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EXTERNAL FINISHES

CONCRETE/FC C01 Concrete Finish - Stained White C02 Concrete Finish - Stained Green

GLASS GL1 Apartment Glazing - Performance Glass

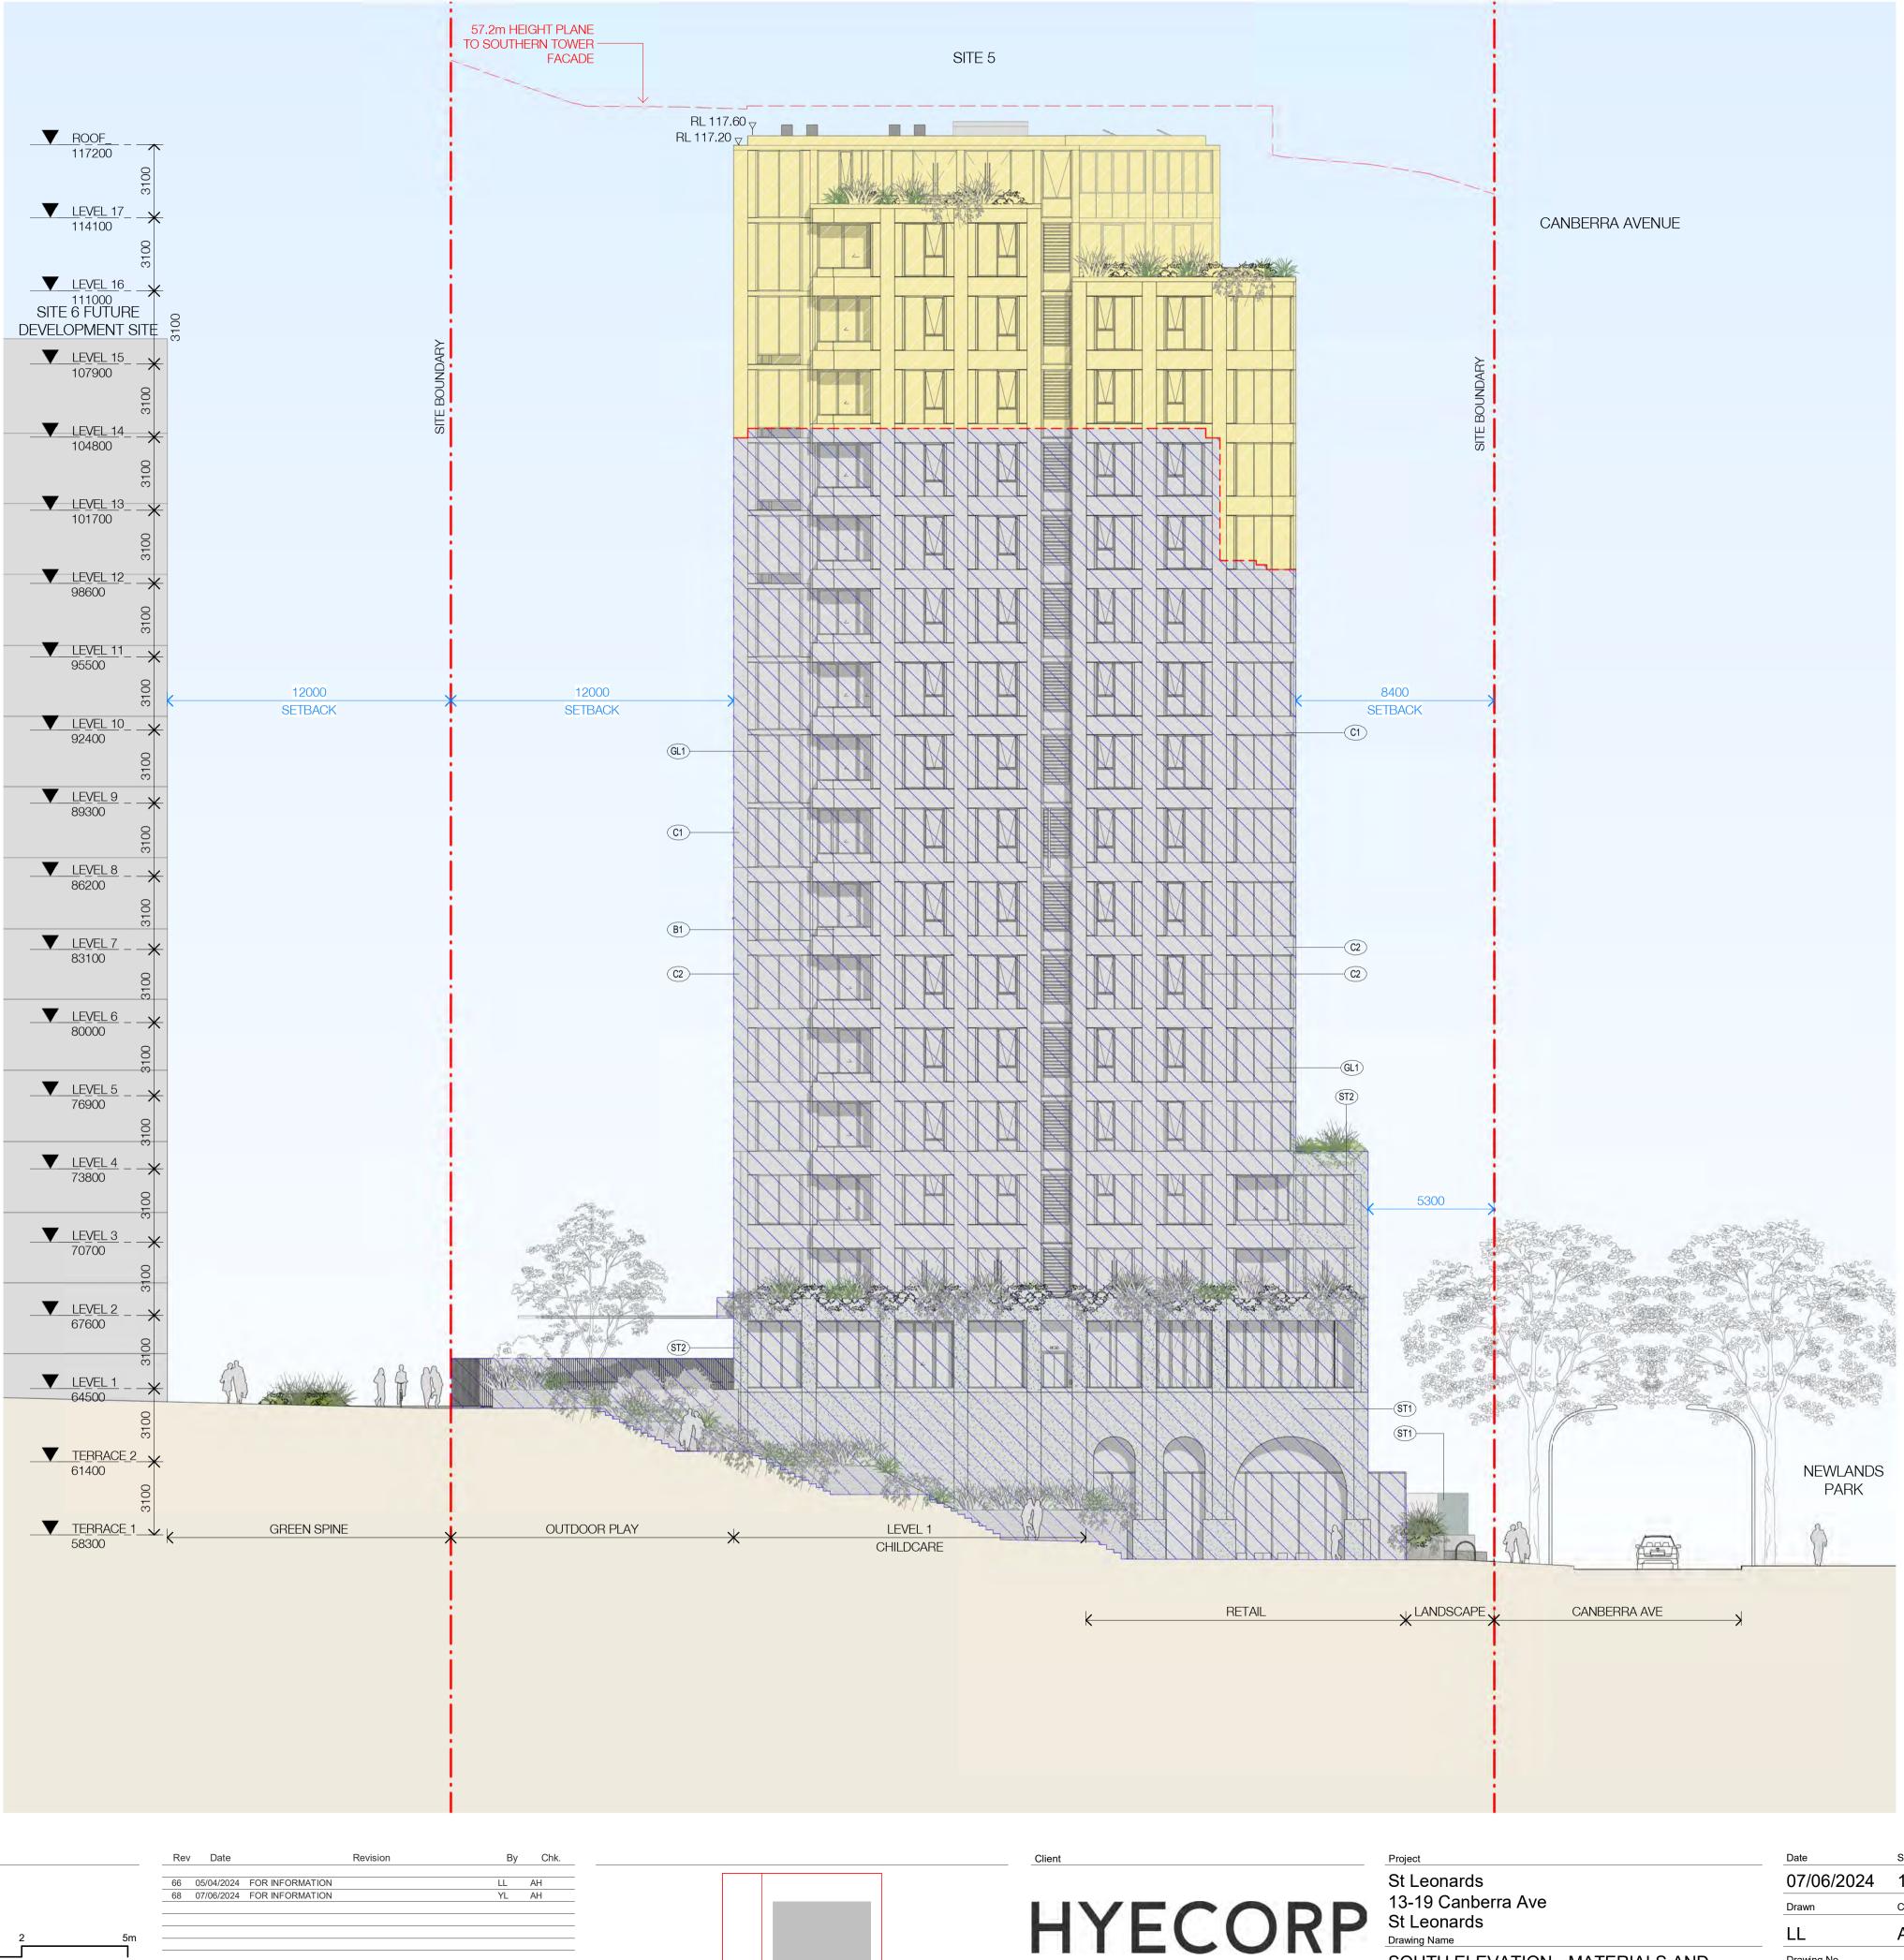METALWORK M1 Aluminium

PAINT PT01 White

PT02 Dark Grey

BALUSTRADE B1 Aluminium Framed - Clear Glass

STONE

ST01 Green Marble ST02 Green Terrazzo

C01

GL01

ST01

M1

C02

PT1

PT2 ST02

FOR INFORMATION


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SOUTH ELEVATION - MATERIALS AND

FINISHES

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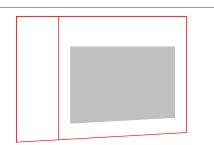
LEGEND

0	1	2	5m
0	1	Z	SIII
1:10) @A1		

Rev Date By Chk. Revision 66 05/04/2024 FOR INFORMATION AH _____ 68 07/06/2024 FOR INFORMATION

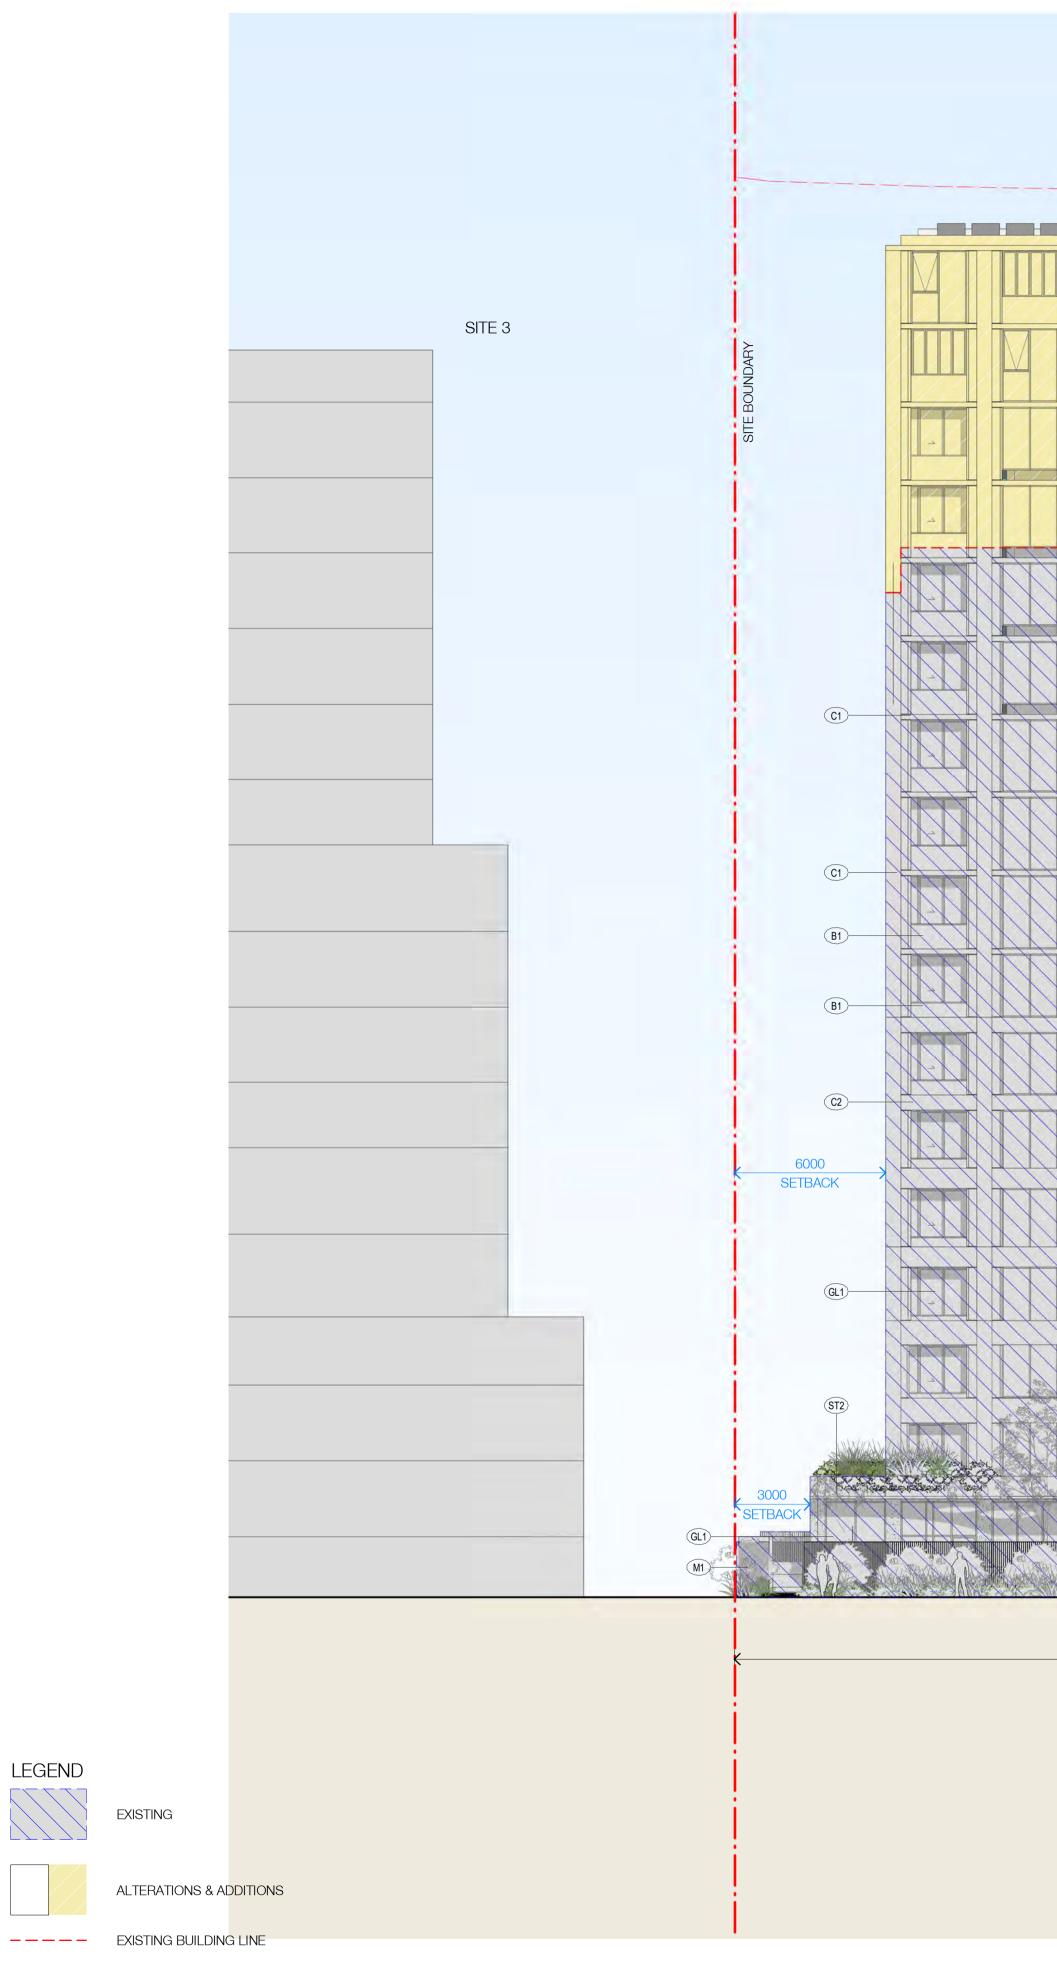- 57.2m HEIGHT PLANE TO WEST FACADE OF TOWER


	EAST-WEST PEDESTRIAN LINK
	15m PEDESTRIAN LINK
SETBACK	
SETBACK	
CHILDCARE *	PEDESTRIAN LINK 15190
X _{LIFT} X	



HYECORP

Client

Project St Leonards 13-19 Canberra Ave St Leonards Drawing Name WEST ELEVATION - MATERIALS AND FINISHES

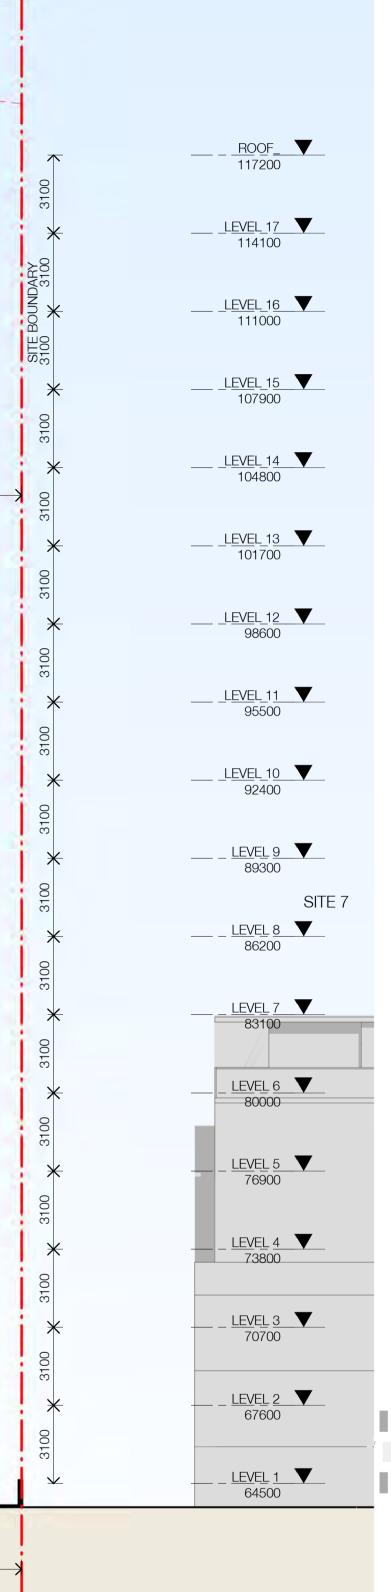

EXTERNAL FINISHES

CONCRETE/FC C01 Concrete Finish - Stained White C02 Concrete Finish - Stained Green

GLASS GL1 Apartment Glazing - Performance Glass

METALWORK M1 Aluminium

PAINT PT01 White

PT02 Dark Grey

BALUSTRADE B1 Aluminium Framed - Clear Glass

STONE

ST01 Green Marble ST02 Green Terrazzo



GL01

PT1

ST01

C02





PT2 ST02

FOR INFORMATION

Date Scale Sheet Size 07/06/2024 1 : 150 @ A1 Drawn Chk. Job No. LL AH 6429 Drawing No. Revision			100
07/06/2024 1 : 150 @ A1 Drawn Chk. Job No.	Drawing No.		Revision
07/06/2024 1:150 @ A1	LL	AH	6429
	Drawn	Chk.	Job No.
Date Scale Sheet Size	07/06/2024	1 : 150	@ A1
	Date	Scale	Sheet Size

DA-2405-A

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V2: Current Revised GFA Summary (At Basement 4 Existing Ground level)




BASEMENT 4

BASEMENT 3

9 m^2	

BASEMENT 1

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Rev	Date		Revision	By	Chk.
66	05/04/2024	FOR INFORMATION		LL	AH

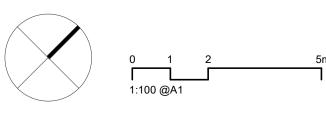Client



Project St Leonards 13-19 Canberra Ave St Leonards Drawing Name GFA PLAN SHEET 00 - V2

						STORAGE 64 m ²	
			COMM 11 n				
	▼			♥			


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Drawn	Chk.	Job No
LL	AH	6429
Drawing No.		Revision

DA-3000-2

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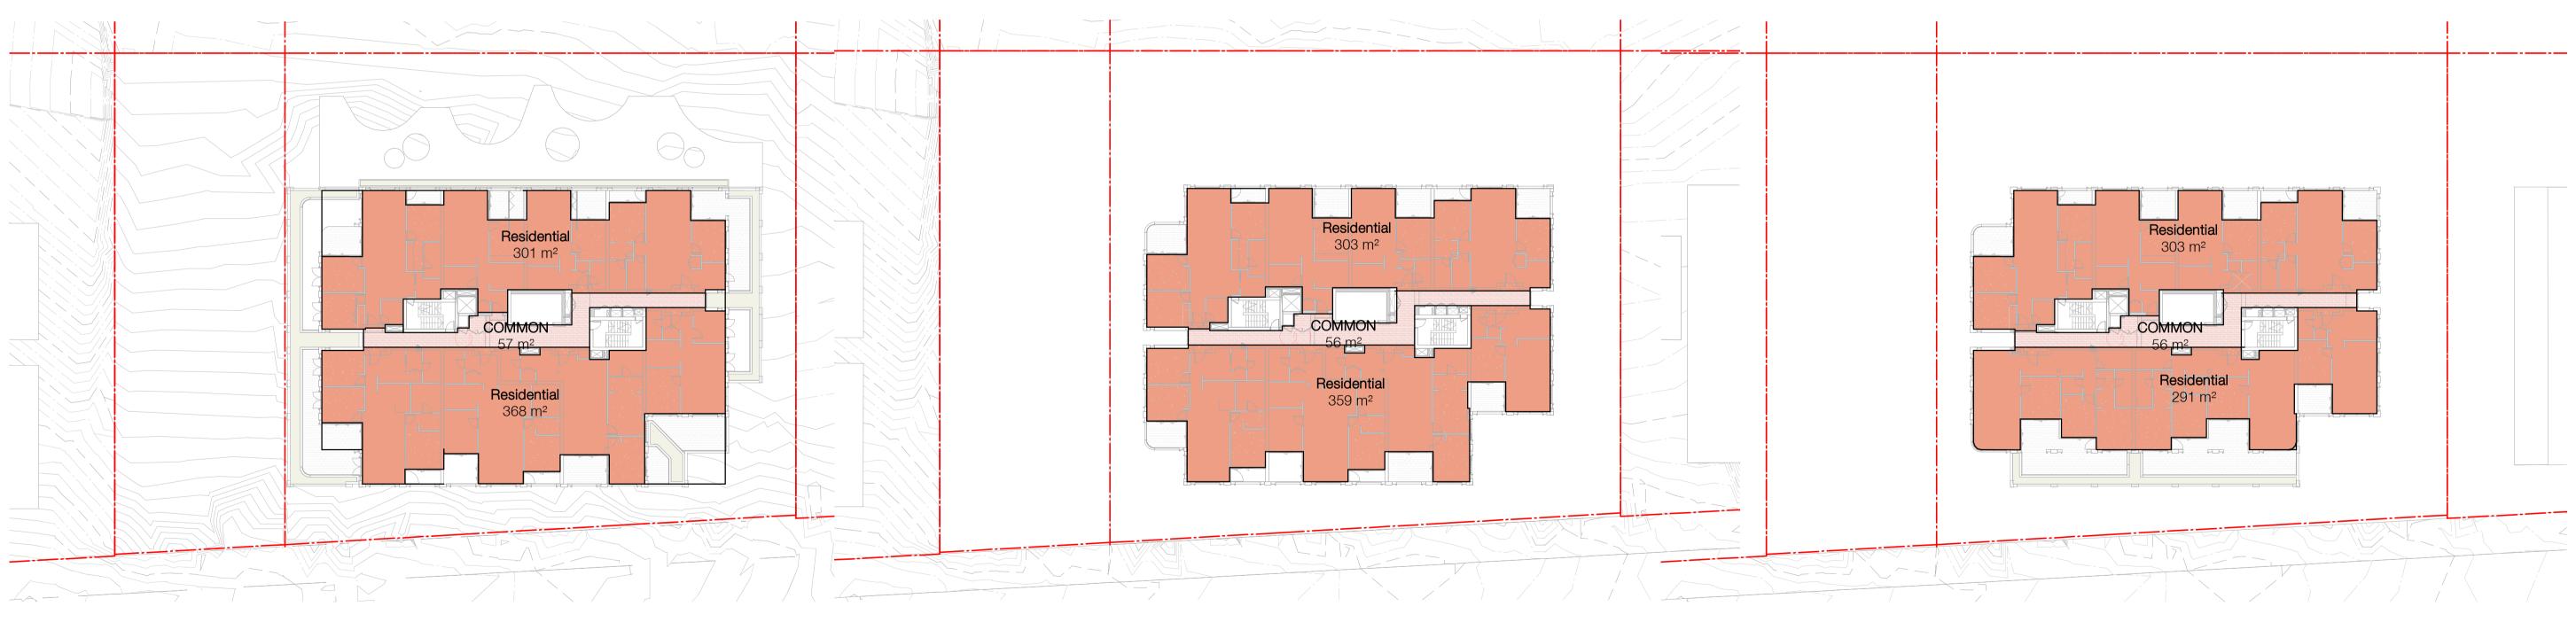


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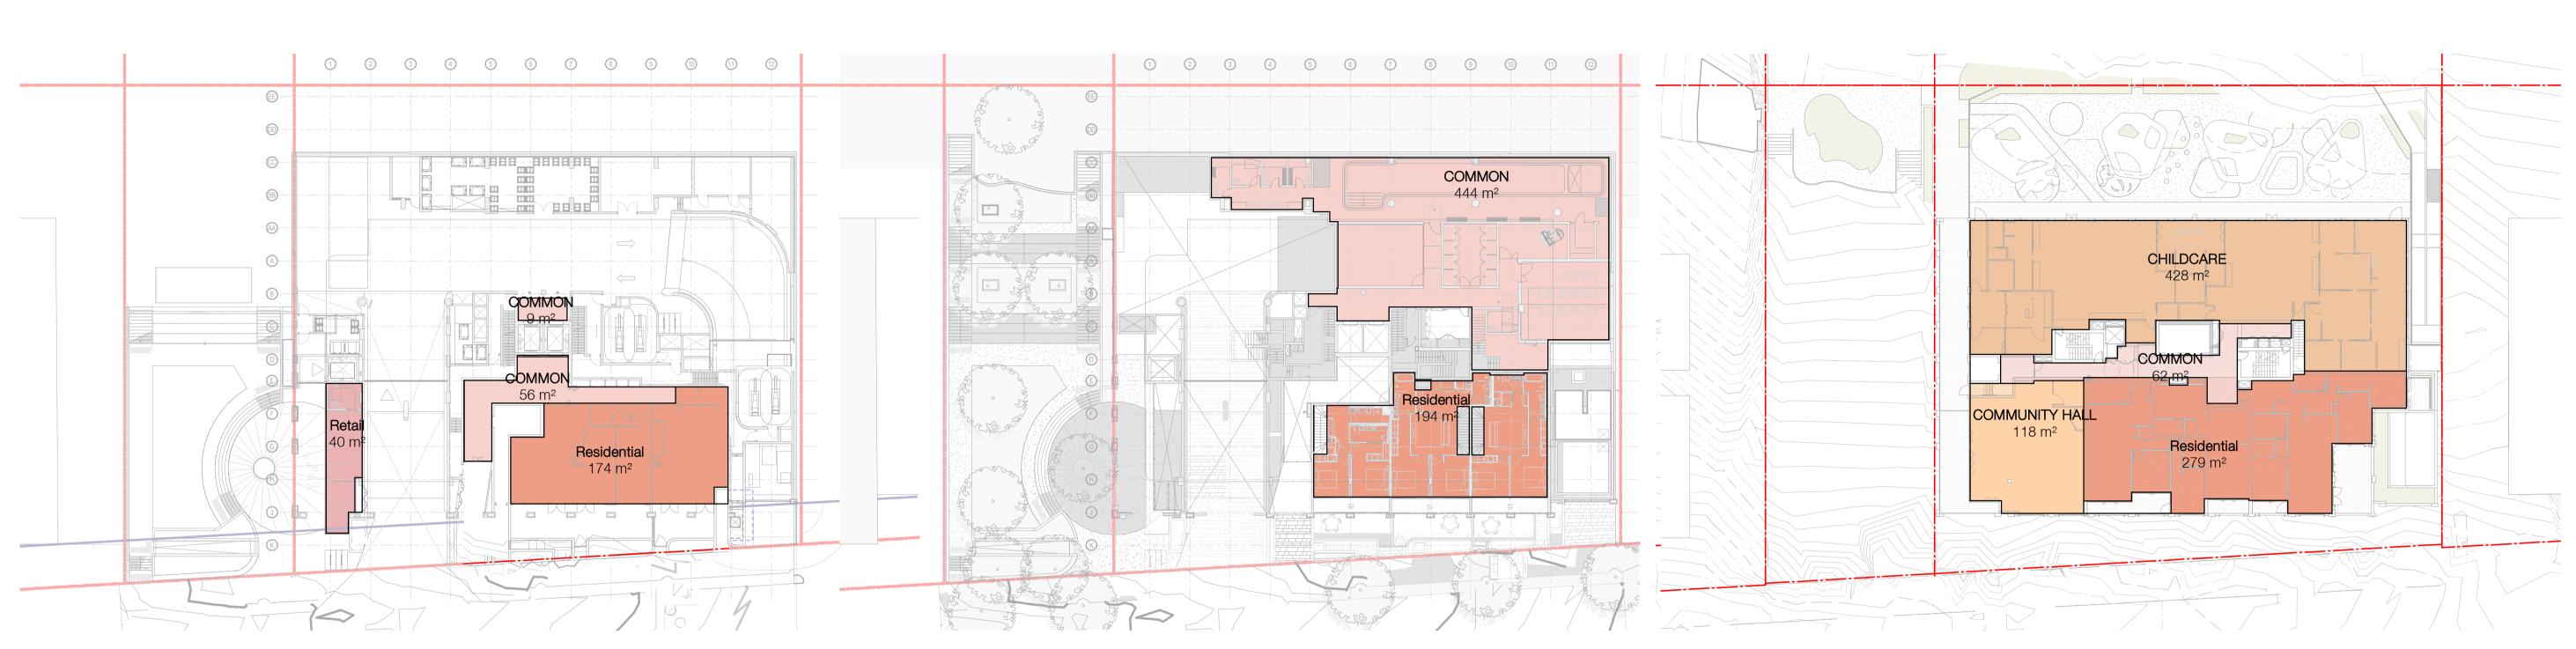
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28	18/08/2021	FOR COORDINATION	LL	AH
32	03/09/2021	FINAL DRAFT FOR DA	LL	AH
36	24/09/2021	FINAL DRAFT FOR DA	LL	AH
37	28/09/2021	FINAL DRAFT FOR DA	LL	AH
40	08/10/2021	FINAL DRAFT FOR DA	LL	AH
42	13/10/2021	FOR DA APPLICATION	LL	AH
45	29/04/2022	RESPONSE TO RFI	LL	AH
55	14/12/2022	FINAL ALTERATION & ADDITION SUBMISSION		
58	11/09/2023	FOR INFORMATION	LL	AH
66	05/04/2024	FOR INFORMATION	LL	AH

LEVEL 2 V2

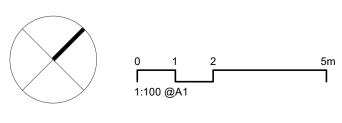

GROUND FLOOR V2

UPPER GROUND V2




V2: Current Revised GFA Summary (At Basement 4 Existing Ground level)

LEVEL 1 V2

LEVEL 3 V2

LEVEL 4 GFA V2

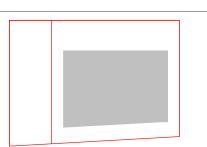




Project St Leonards 13-19 Canberra Ave St Leonards Drawing Name GFA PLAN SHEET 01 - V2

Drawing No.	ML	6429 Revision
	ML	6429
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Drawn 0	Chk.	Job No.
05/04/2024	1 : 300	@ A1
Date S	Scale	Sheet Size


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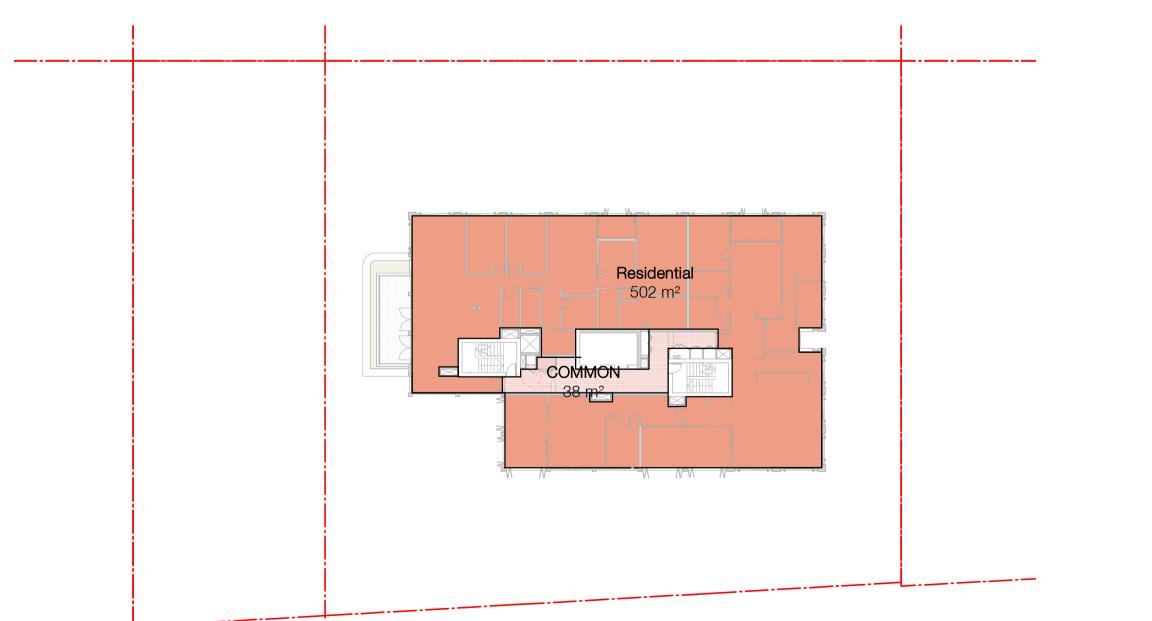




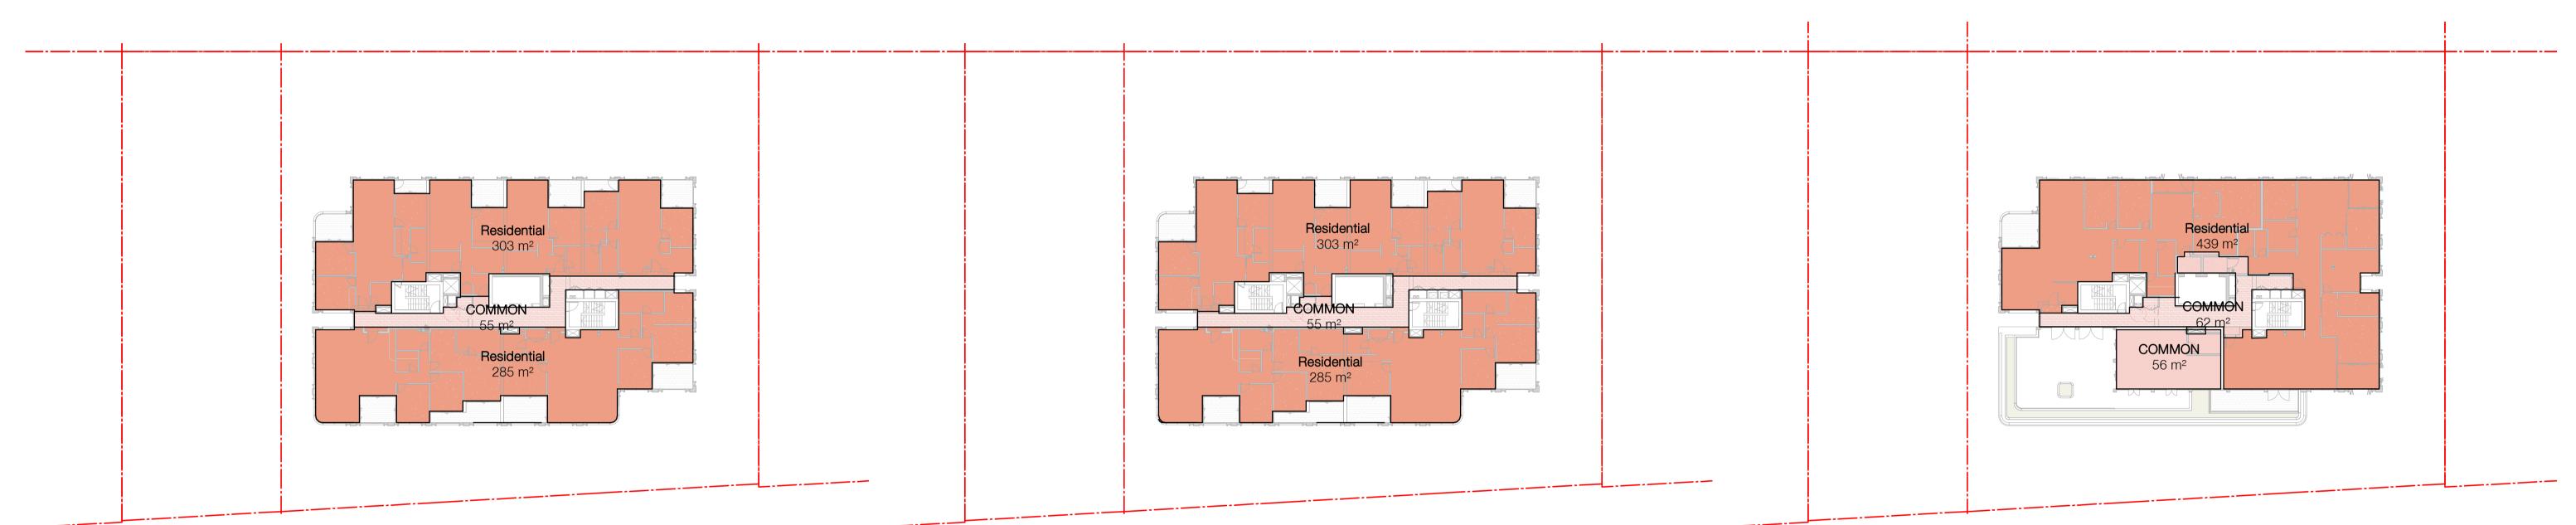


LEVEL 12-13 GFA



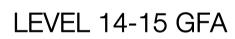

LEVEL 17 GFA

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Rev	Date	Revision	By	Chk.
54	13/12/2022	FINAL MODIFICATION SUBMISSION	ML	AH
58	11/09/2023	FOR INFORMATION	LL	AH
59	22/09/2023	FOR INFORMATION	LL	AH
64	08/03/2024	FOR INFORMATION	LL	AH
66	05/04/2024	FOR INFORMATION	LL	AH

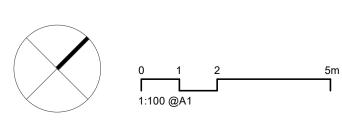LEVEL 8-11 GFA


GFA Schedule V2						
LEVEL	Name	AREA_TOTAL				
BASEMENT 4	STORAGE	7 m ²				
BASEMENT 4	STORAGE	9 m²				
BASEMENT 4	COMMON	18 m ²				
BASEMENT 4	STORAGE	24 m ²				
BASEMENT 4	STORAGE	64 m ²				
BASEMENT 3	STORAGE	14 m ²				
BASEMENT 3	COMMON	11 m ²				
BASEMENT 3	STORAGE	64 m ²				
BASEMENT 2	STORAGE	14 m ²				
BASEMENT 2	COMMON	11 m ²				
BASEMENT 2	STORAGE	64 m ²				
BASEMENT 1	COMMON	11 m ²				
BASEMENT 1	STORAGE	64 m ²				
BASEMENT 1	COMMON	9 m²				
	·					

GFA Schedule V2							
LEVEL	Name	AREA_TOTAL					
GROUND FLOOR	Retail	40 m ²					
GROUND FLOOR	COMMON	56 m ²					
GROUND FLOOR	Residential	174 m ²					
GROUND FLOOR	COMMON	9 m²					
UPPER GROUND	COMMON	444 m ²					
UPPER GROUND	Residential	194 m ²					
LEVEL 1	COMMON	62 m ²					
LEVEL 1	COMMUNITY HALL	118 m ²					
LEVEL 1	Residential	279 m ²					
LEVEL 1	CHILDCARE	428 m ²					
LEVEL 2	COMMON	57 m ²					
LEVEL 2	Residential	301 m ²					
LEVEL 2	Residential	368 m ²					
LEVEL 3	COMMON	56 m ²					
LEVEL 3	Residential	303 m ²					
LEVEL 3	Residential	359 m ²					
· _ ·							
LEVEL 4	COMMON	56 m ²					
LEVEL 4	Residential	291 m²					
LEVEL 4	Residential	303 m ²					
LEVEL 5	COMMON	56 m ²					
LEVEL 5	Residential	291 m²					
LEVEL 5	Residential	303 m ²					

Client


LEVEL 16 GFA

GFA	Schedule	V2	GFA
LEVEL	Name	AREA_TOTAL	LEVEL
LEVEL 6	COMMON	56 m ²	LEVEL 13
LEVEL 6	Residential	291 m ²	LEVEL 13
LEVEL 6	Residential	303 m ²	LEVEL 13
LEVEL 7	COMMON	56 m ²	LEVEL 14
LEVEL 7	Residential	291 m²	LEVEL 14
LEVEL 7	Residential	303 m ²	LEVEL 14
LEVEL 8	COMMON	56 m ²	LEVEL 15
LEVEL 8	Residential	291 m ²	LEVEL 15
LEVEL 8	Residential	303 m ²	LEVEL 15
LEVEL 9	COMMON	56 m ²	LEVEL 16
LEVEL 9	Residential	291 m ²	LEVEL 16
LEVEL 9	Residential	303 m ²	LEVEL 16
LEVEL 10	COMMON	56 m ²	LEVEL 17
LEVEL 10	Residential	291 m ²	LEVEL 17
LEVEL 10	Residential	303 m ²	TOTAL AREA
LEVEL 11	COMMON	56 m ²	
LEVEL 11	Residential	291 m ²	
LEVEL 11	Residential	303 m ²	
	1		
LEVEL 12	COMMON	55 m ²	
LEVEL 12	Residential	285 m ²	
LEVEL 12	Residential	303 m ²	

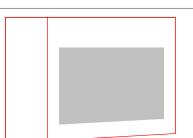

HYECORP

Project St Leonards 13-19 Canberra Ave St Leonards Drawing Name GFA PLAN SHEET 02 - V2

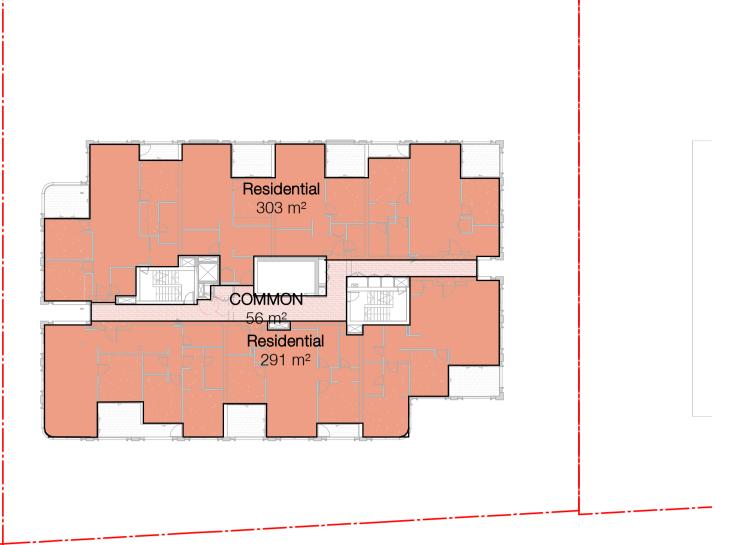

GF	A Schedul	e V2
LEVEL	Name	AREA_TOTAL
EL 13	COMMON	55 m ²
EL 13	Residential	285 m ²
EL 13	Residential	303 m ²
EL 14	COMMON	55 m ²
EL 14	Residential	285 m ²
EL 14	Residential	303 m ²
EL 15	COMMON	55 m ²
EL 15	Residential	285 m ²
EL 15	Residential	303 m ²
EL 16	COMMON	56 m ²
EL 16	COMMON	62 m ²
EL 16	Residential	439 m ²
EL 17	COMMON	38 m²
EL 17	Residential	502 m ²
AL AREA		12492 m ²

APPROVED DA GFA SUMMARY

RISER PROVISION TOTAL GFA

-81 m² 8720 m²

V1: CURRENT REVISED GFA SUMMARY (AT DA APPROVED EXISTING GROUND LEVEL)

RISER PROVISION TOTAL GFA

-104 m² **11842** m²

V2: CURRENT REVISED GFA SUMMARY (AT BASEMENT 4 EXISTING GROUND LEVEL)

RISER PROVISION TOTAL GFA

-104 m² 12388 m²

Scale Sheet Size Date 05/04/2024 1:300 @ A1 Drawn Chk. Job No. AH 6429 LL Drawing No. Revision / 66 DA-3002-2

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13-19 Canberra Ave St Leonards Landscape Development Application - Affordable Housing

DRAWINGS

DWG NO.	DRAWING TITLE	SCAL
AH-000	COVER SHEET	N/A
AH-100	LANDSCAPE GROUND & UPPER GROUND - GENERAL ARRANGEMENT	1:100
AH-101	LANDSCAPE LEVEL 1 - GENERAL ARRANGEMENT	1:100
AH-102	LANDSCAPE LEVEL 2 - GENERAL ARRANGEMENT	1:100
AH-103	LANDSCAPE LEVEL 4 - GENERAL ARRANGEMENT	1:100
AH-104	LANDSCAPE LEVEL 16 - GENERAL ARRANGEMENT	1:100
AH-105	LANDSCAPE LEVEL 17 - GENERAL ARRANGEMENT	1:100
AH-200	LANDSCAPE GROUND - PLANTING PLAN	1:100
AH-201	LANDSCAPE LEVEL 1 - PLANTING PLAN	1:100
AH-202	LANDSCAPE LEVEL 2 - PLANTING PLAN	1:100
AH-203	LANDSCAPE LEVEL 4 - PLANTING PLAN	1:100
AH-204	LANDSCAPE LEVEL 16 - PLANTING PLAN	1:100
AH-205	LANDSCAPE LEVEL 17 - PLANTING PLAN	1:100
AH-500	LANDSCAPE SPECIFICATION NOTES	N/A
AH-501	LANDSCAPE DETAILS	N/A
AH-502	LANDSCAPE DETAILS	N/A
AH-503	LANDSCAPE DETAILS	N/A
AH-601	LANDSCAPE ELEVATION	N/A
AH-602	LANDSCAPE ELEVATION	N/A
AH-603	LANDSCAPE ELEVATION	N/A
AH-604	LANDSCAPE ELEVATION	N/A
AH-605	LANDSCAPE ELEVATION	N/A

SCALE

- J/A
- 1:100
- :100 1:100
- 1:100
- 1:100
- 1:100
- :100 1:100
- 1:100 1:100
- 1:100
- J/A
- I/A J/A
- J/A
- J/A
- I/A
- J/A N/A J/A

SS21-4691-1

Drawing Numbe Issue: AH-000 H

Cover Sheet

Drawing Name:

Scale: Job Number:

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Landscape Architects

SITE IMAGE

Project: 13 - 19 Canberra Ave St leonards

Client: HYECORP Property Group



LEGEND


A For DA Approval Issue Revision Description

NH RS 08.04.2024 Drawn Check Date


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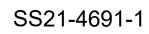
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Scale: 1:100 @ A1 Job Number:

Drawing Number: AH-101 A

Landscape Level 1 General arrangement
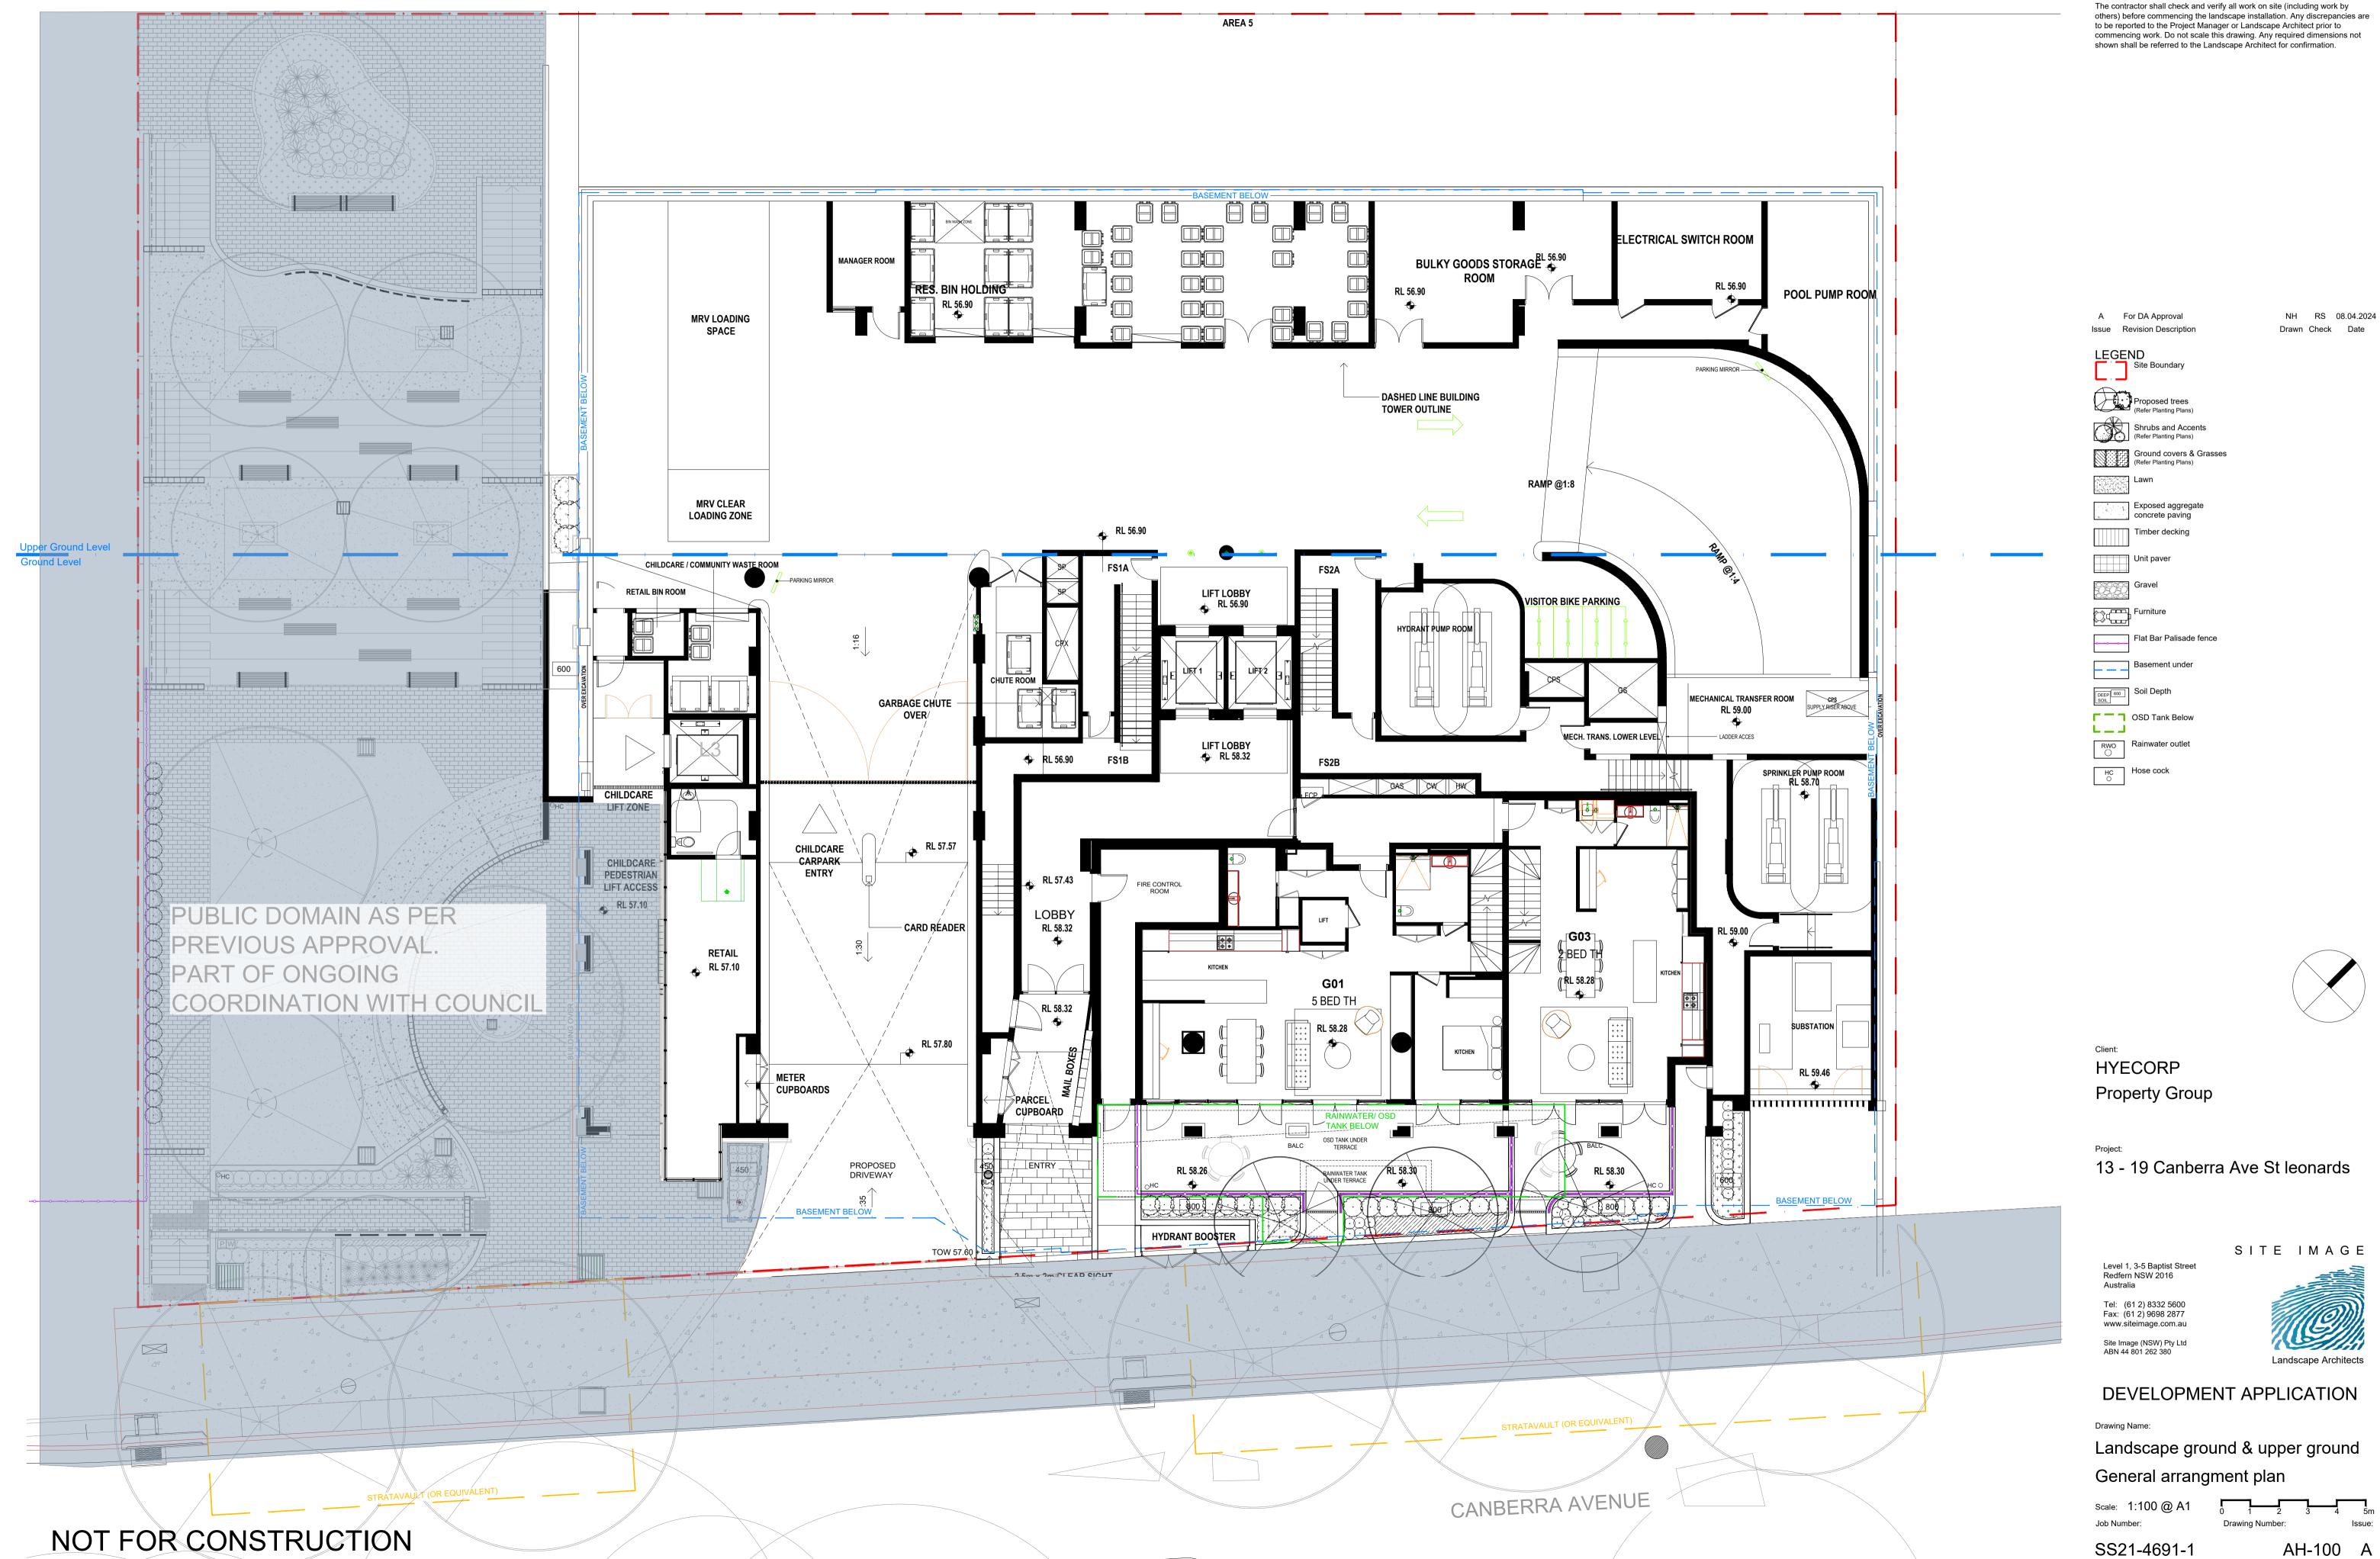
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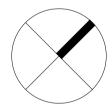
Landscape Architects


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Project: 13 - 19 Canberra Ave St leonards
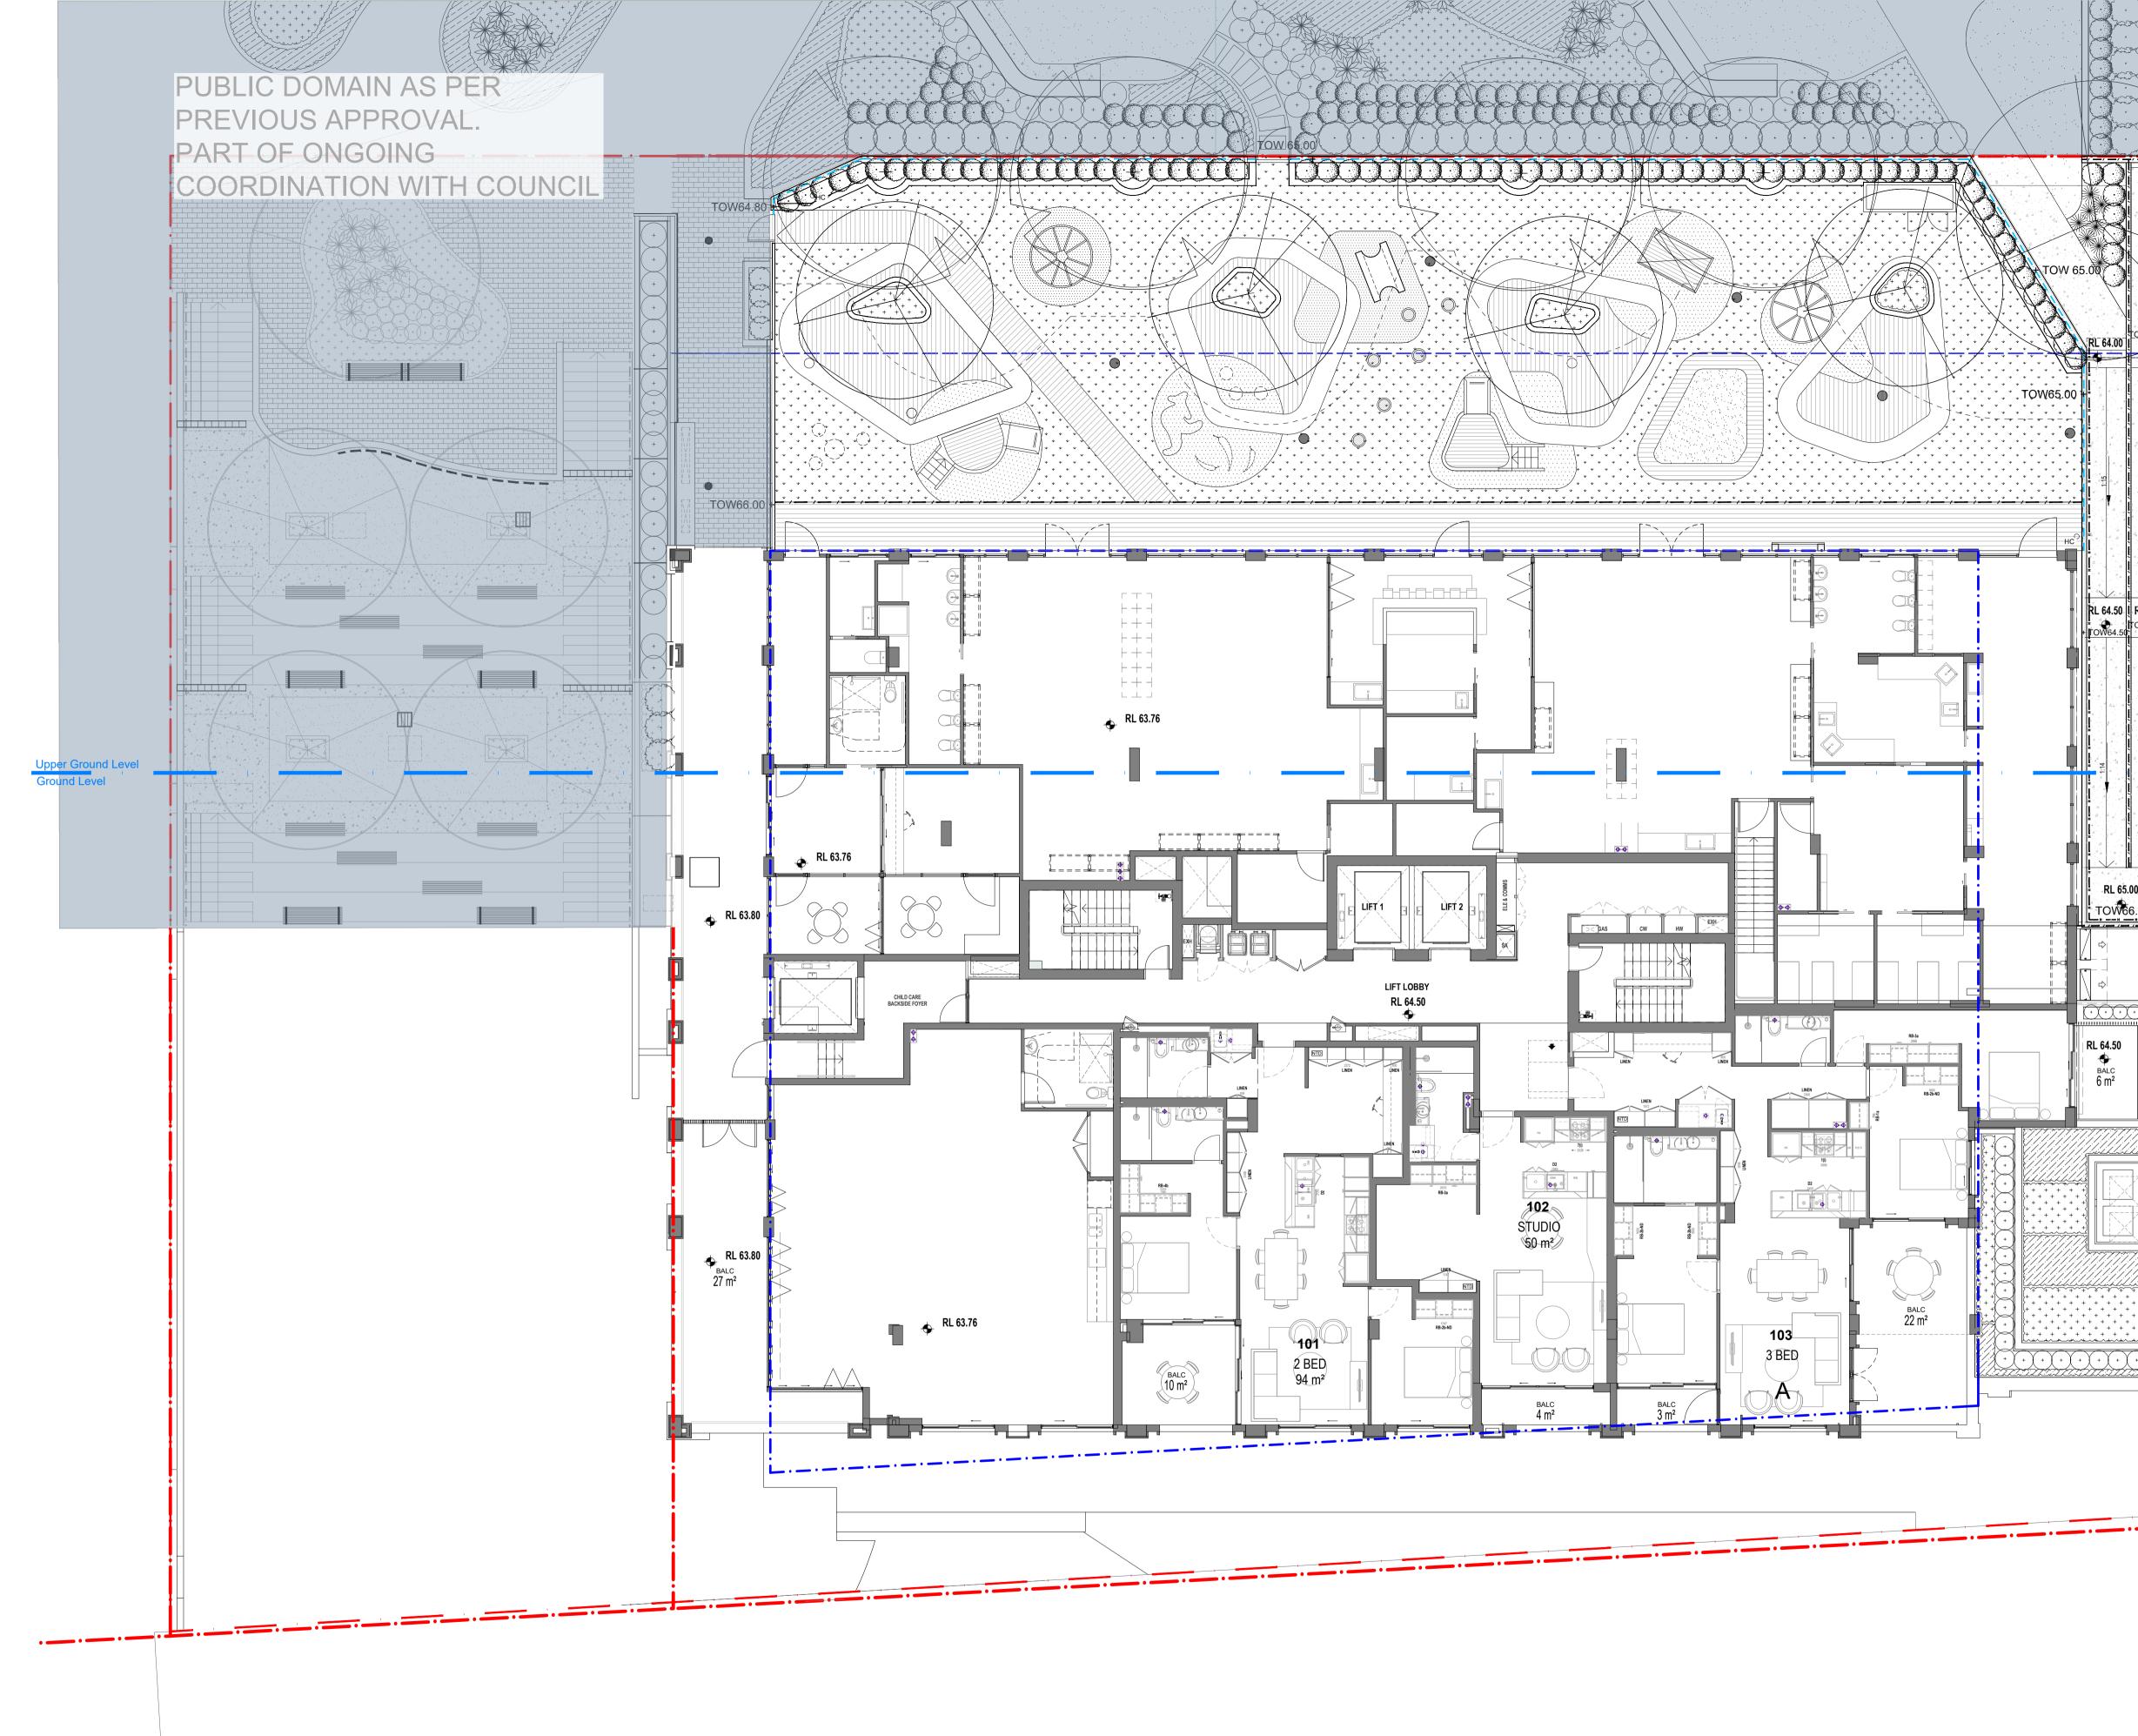
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NH RS 08.04.2024 Drawn Check Date


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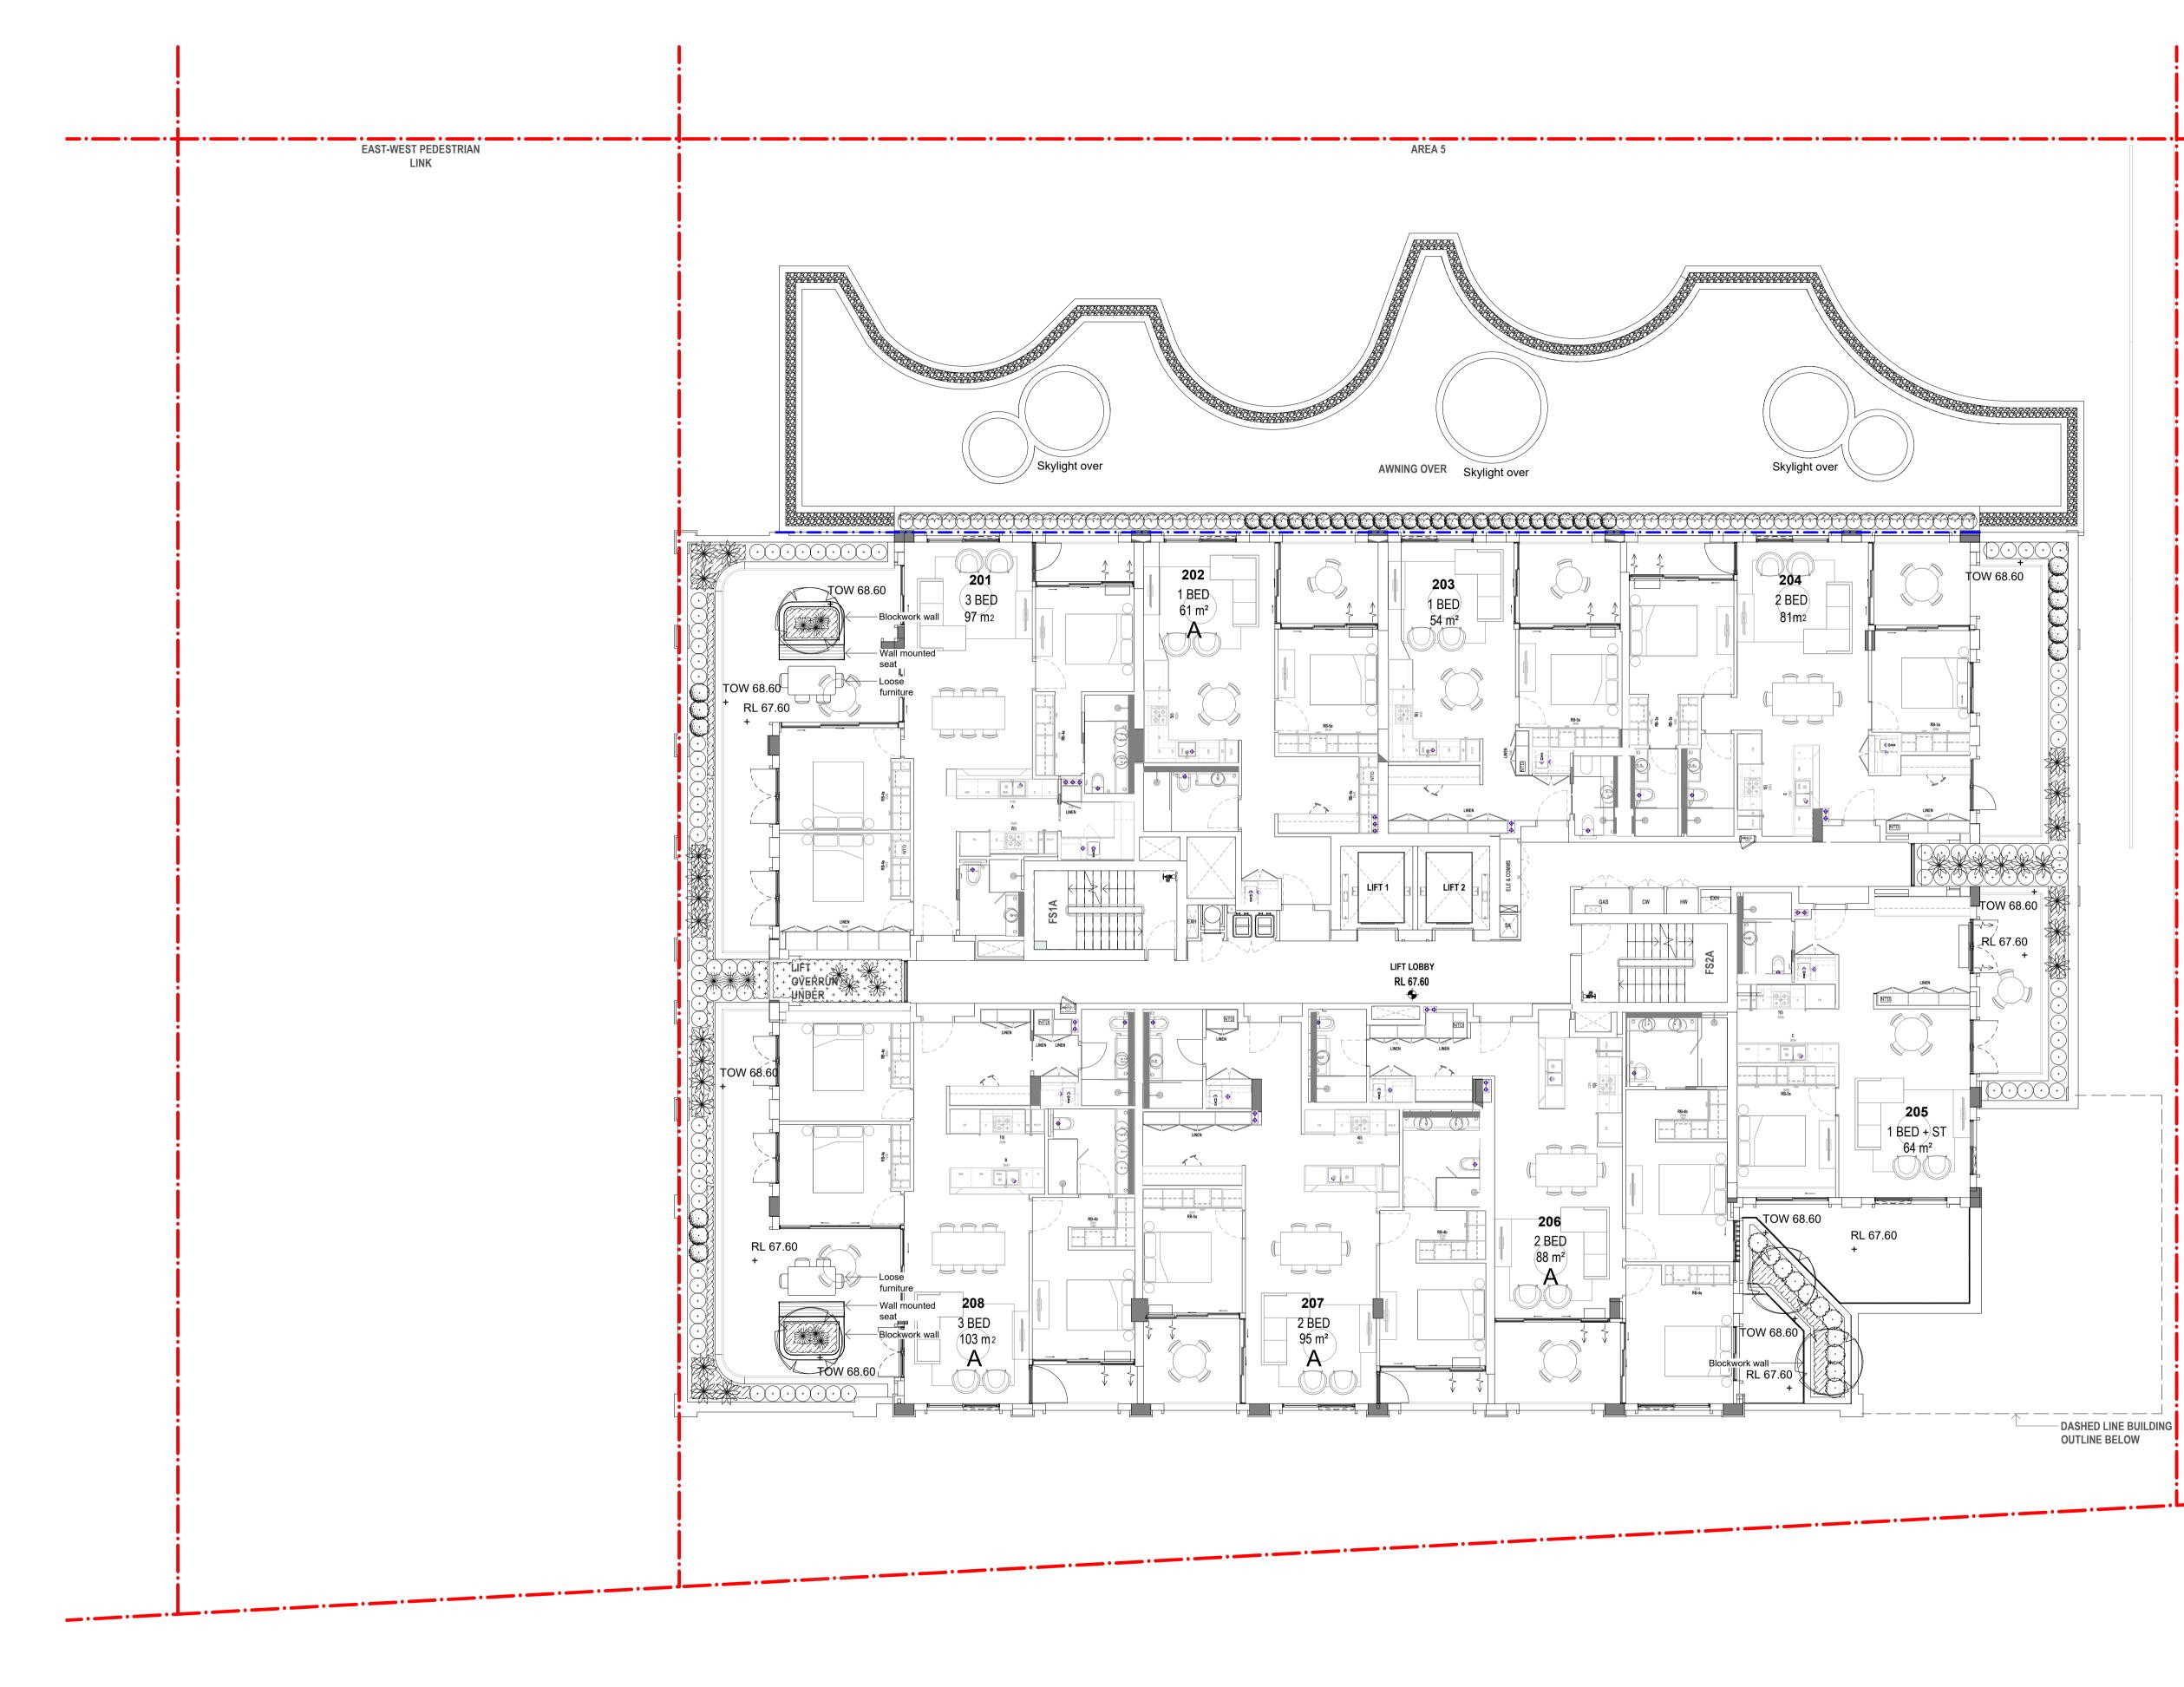
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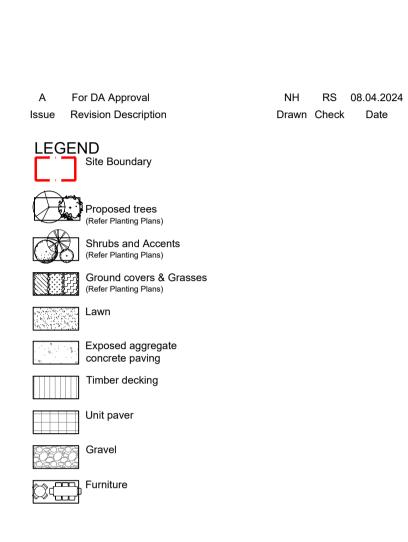
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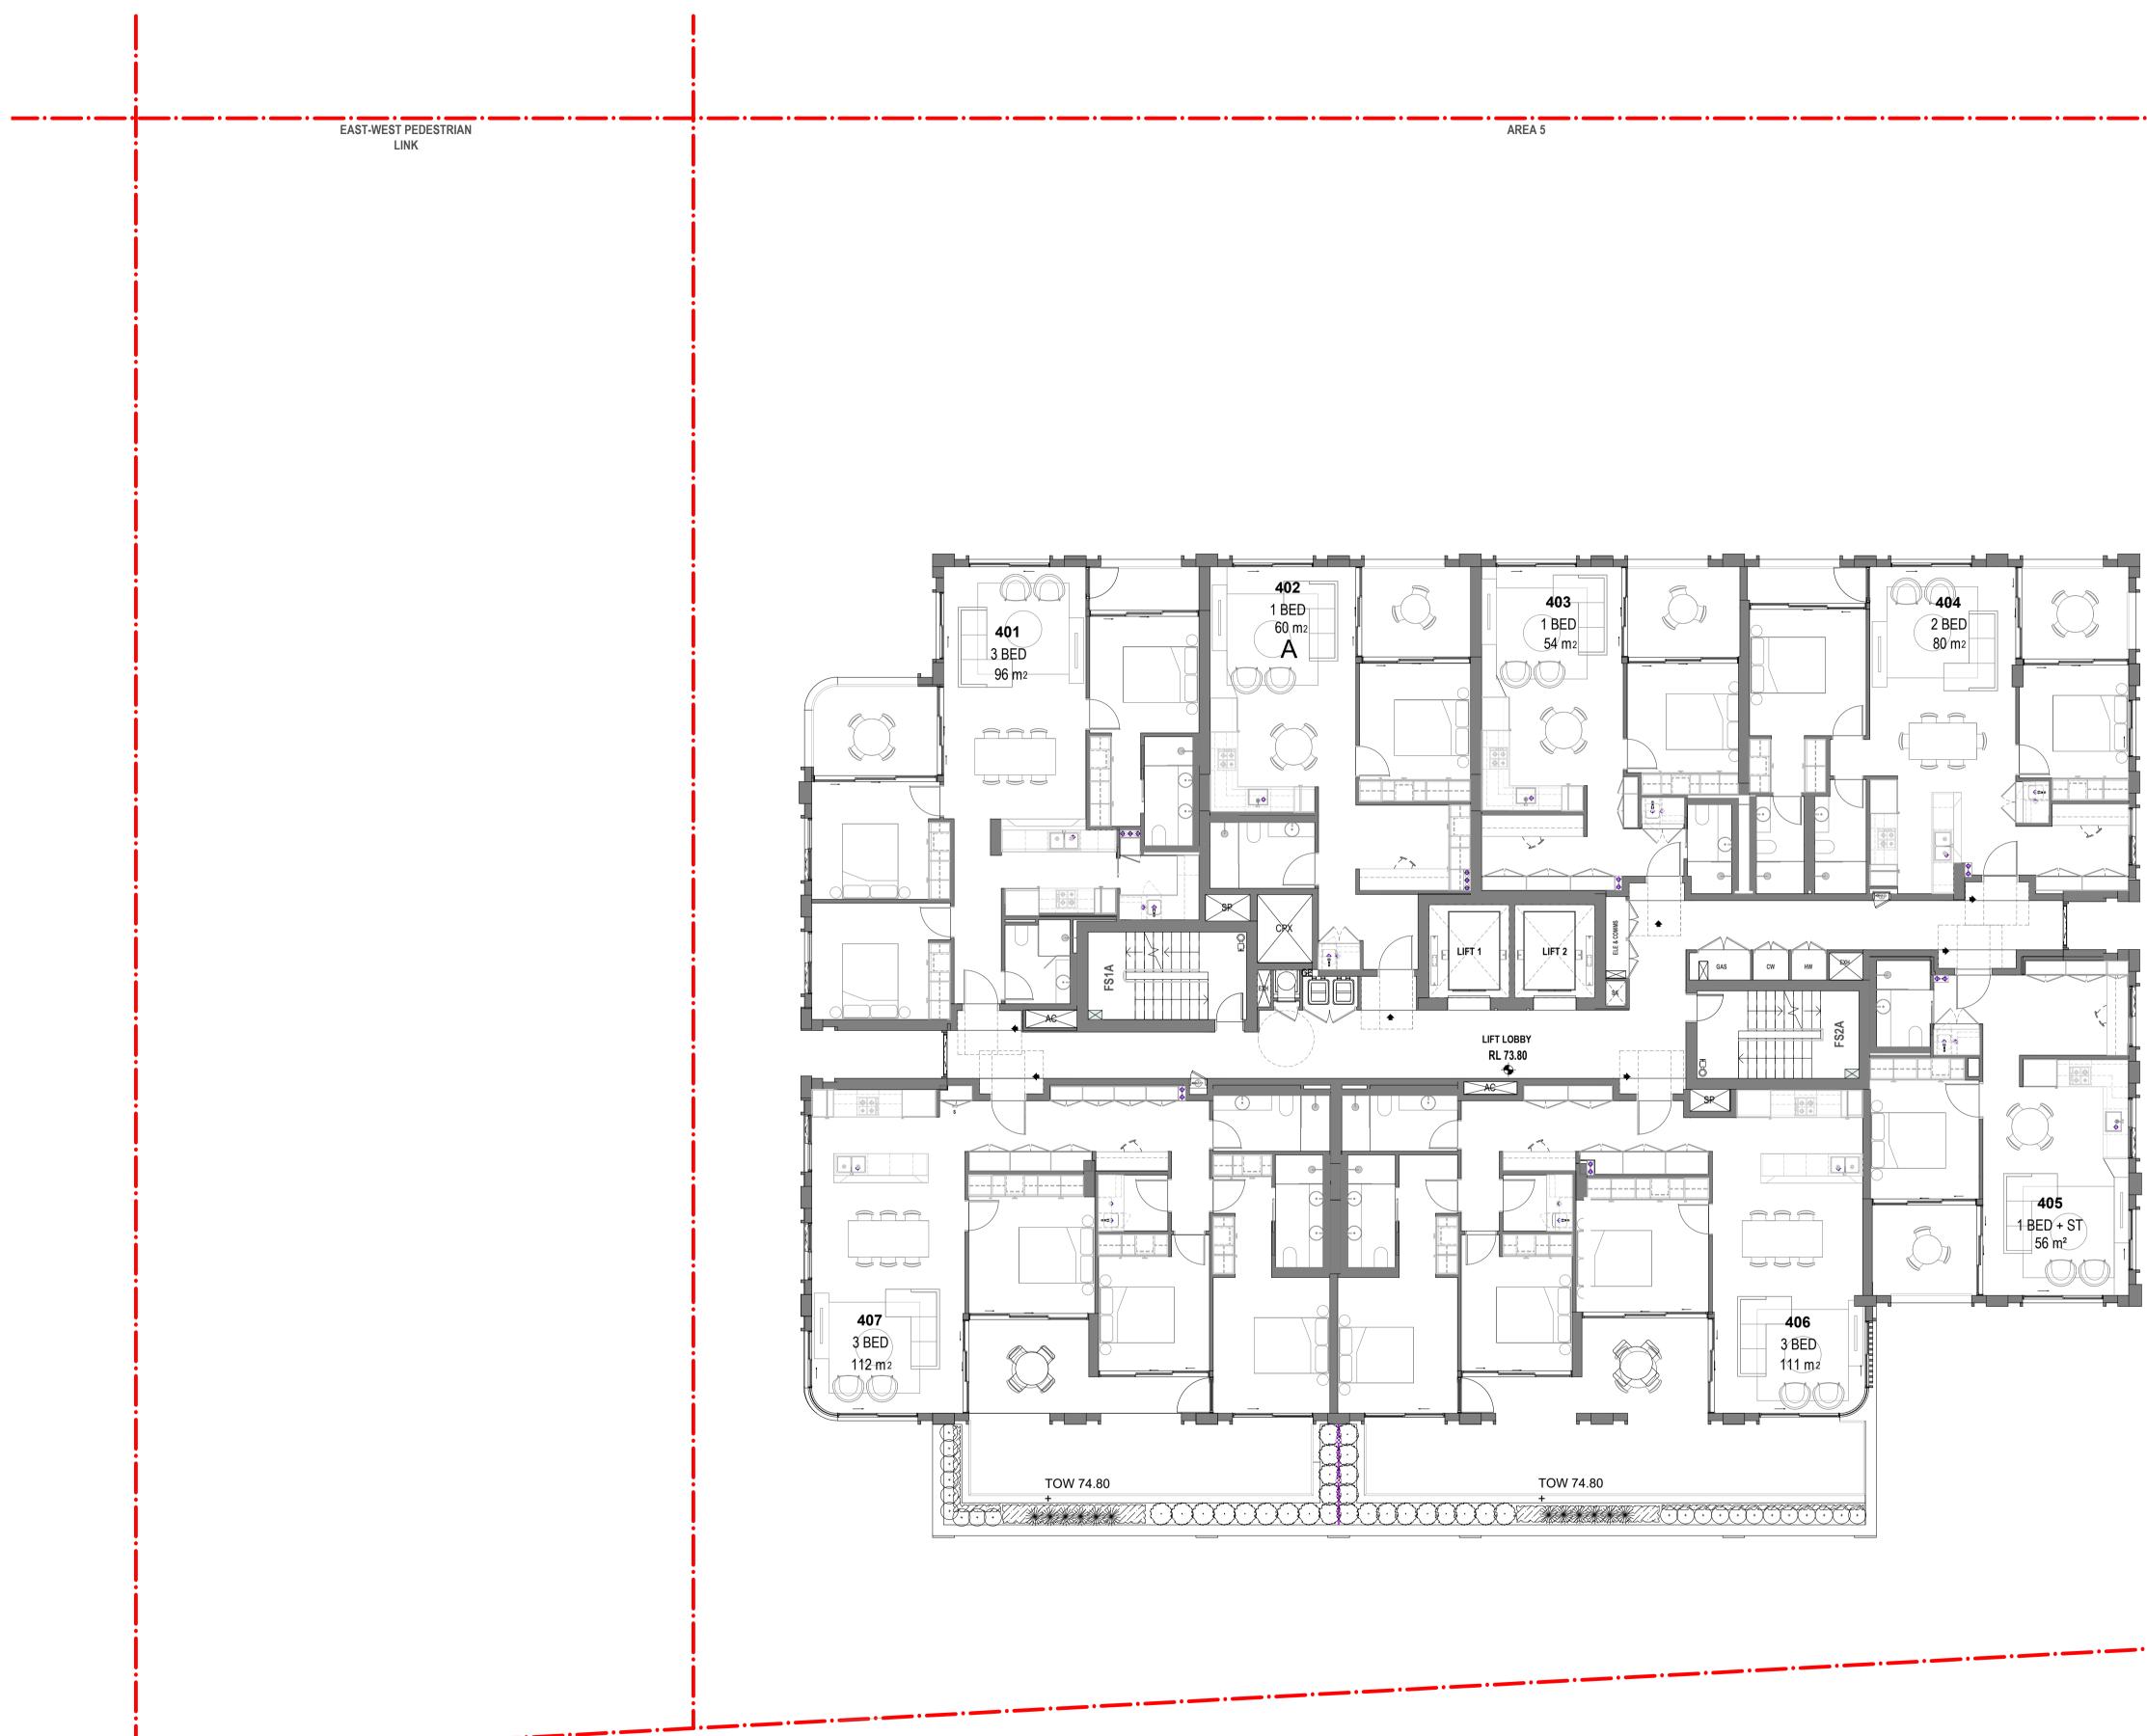
Landscape Architects

DEVELOPMENT APPLICATION

Drawing Name: Landscape Level 2 General arrangement

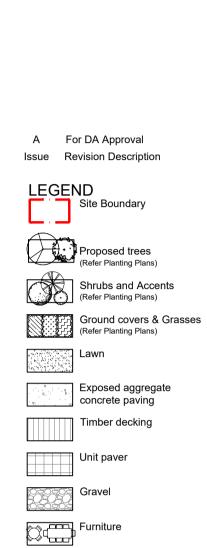
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Project: 13 - 19 Canberra Ave St leonards

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Landscape Architects

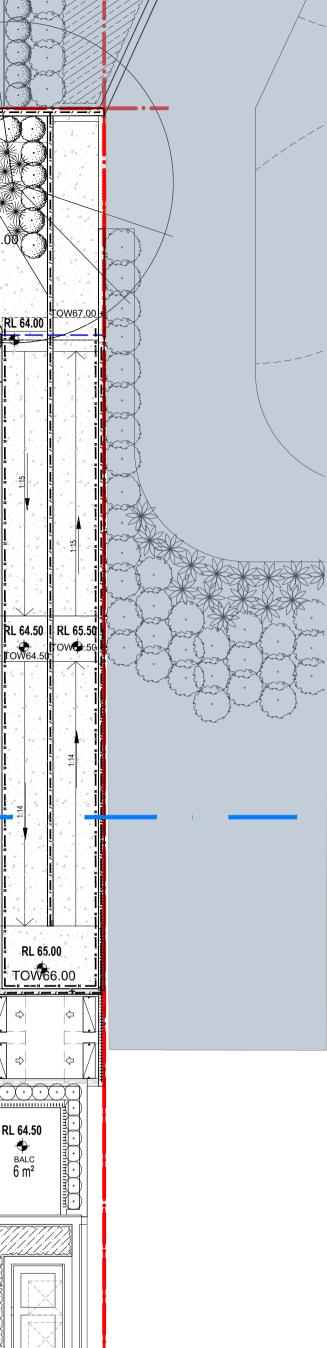
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DEVELOPMENT APPLICATION

Drawing Name: Landscape Level 4 General arrangement Scale: 1:100 @ A1


Drawing Number: Issue: AH-103 A
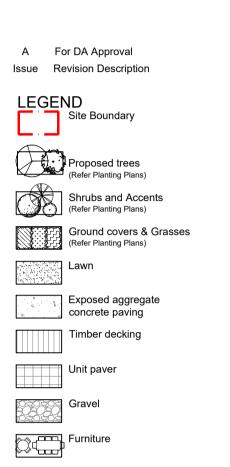
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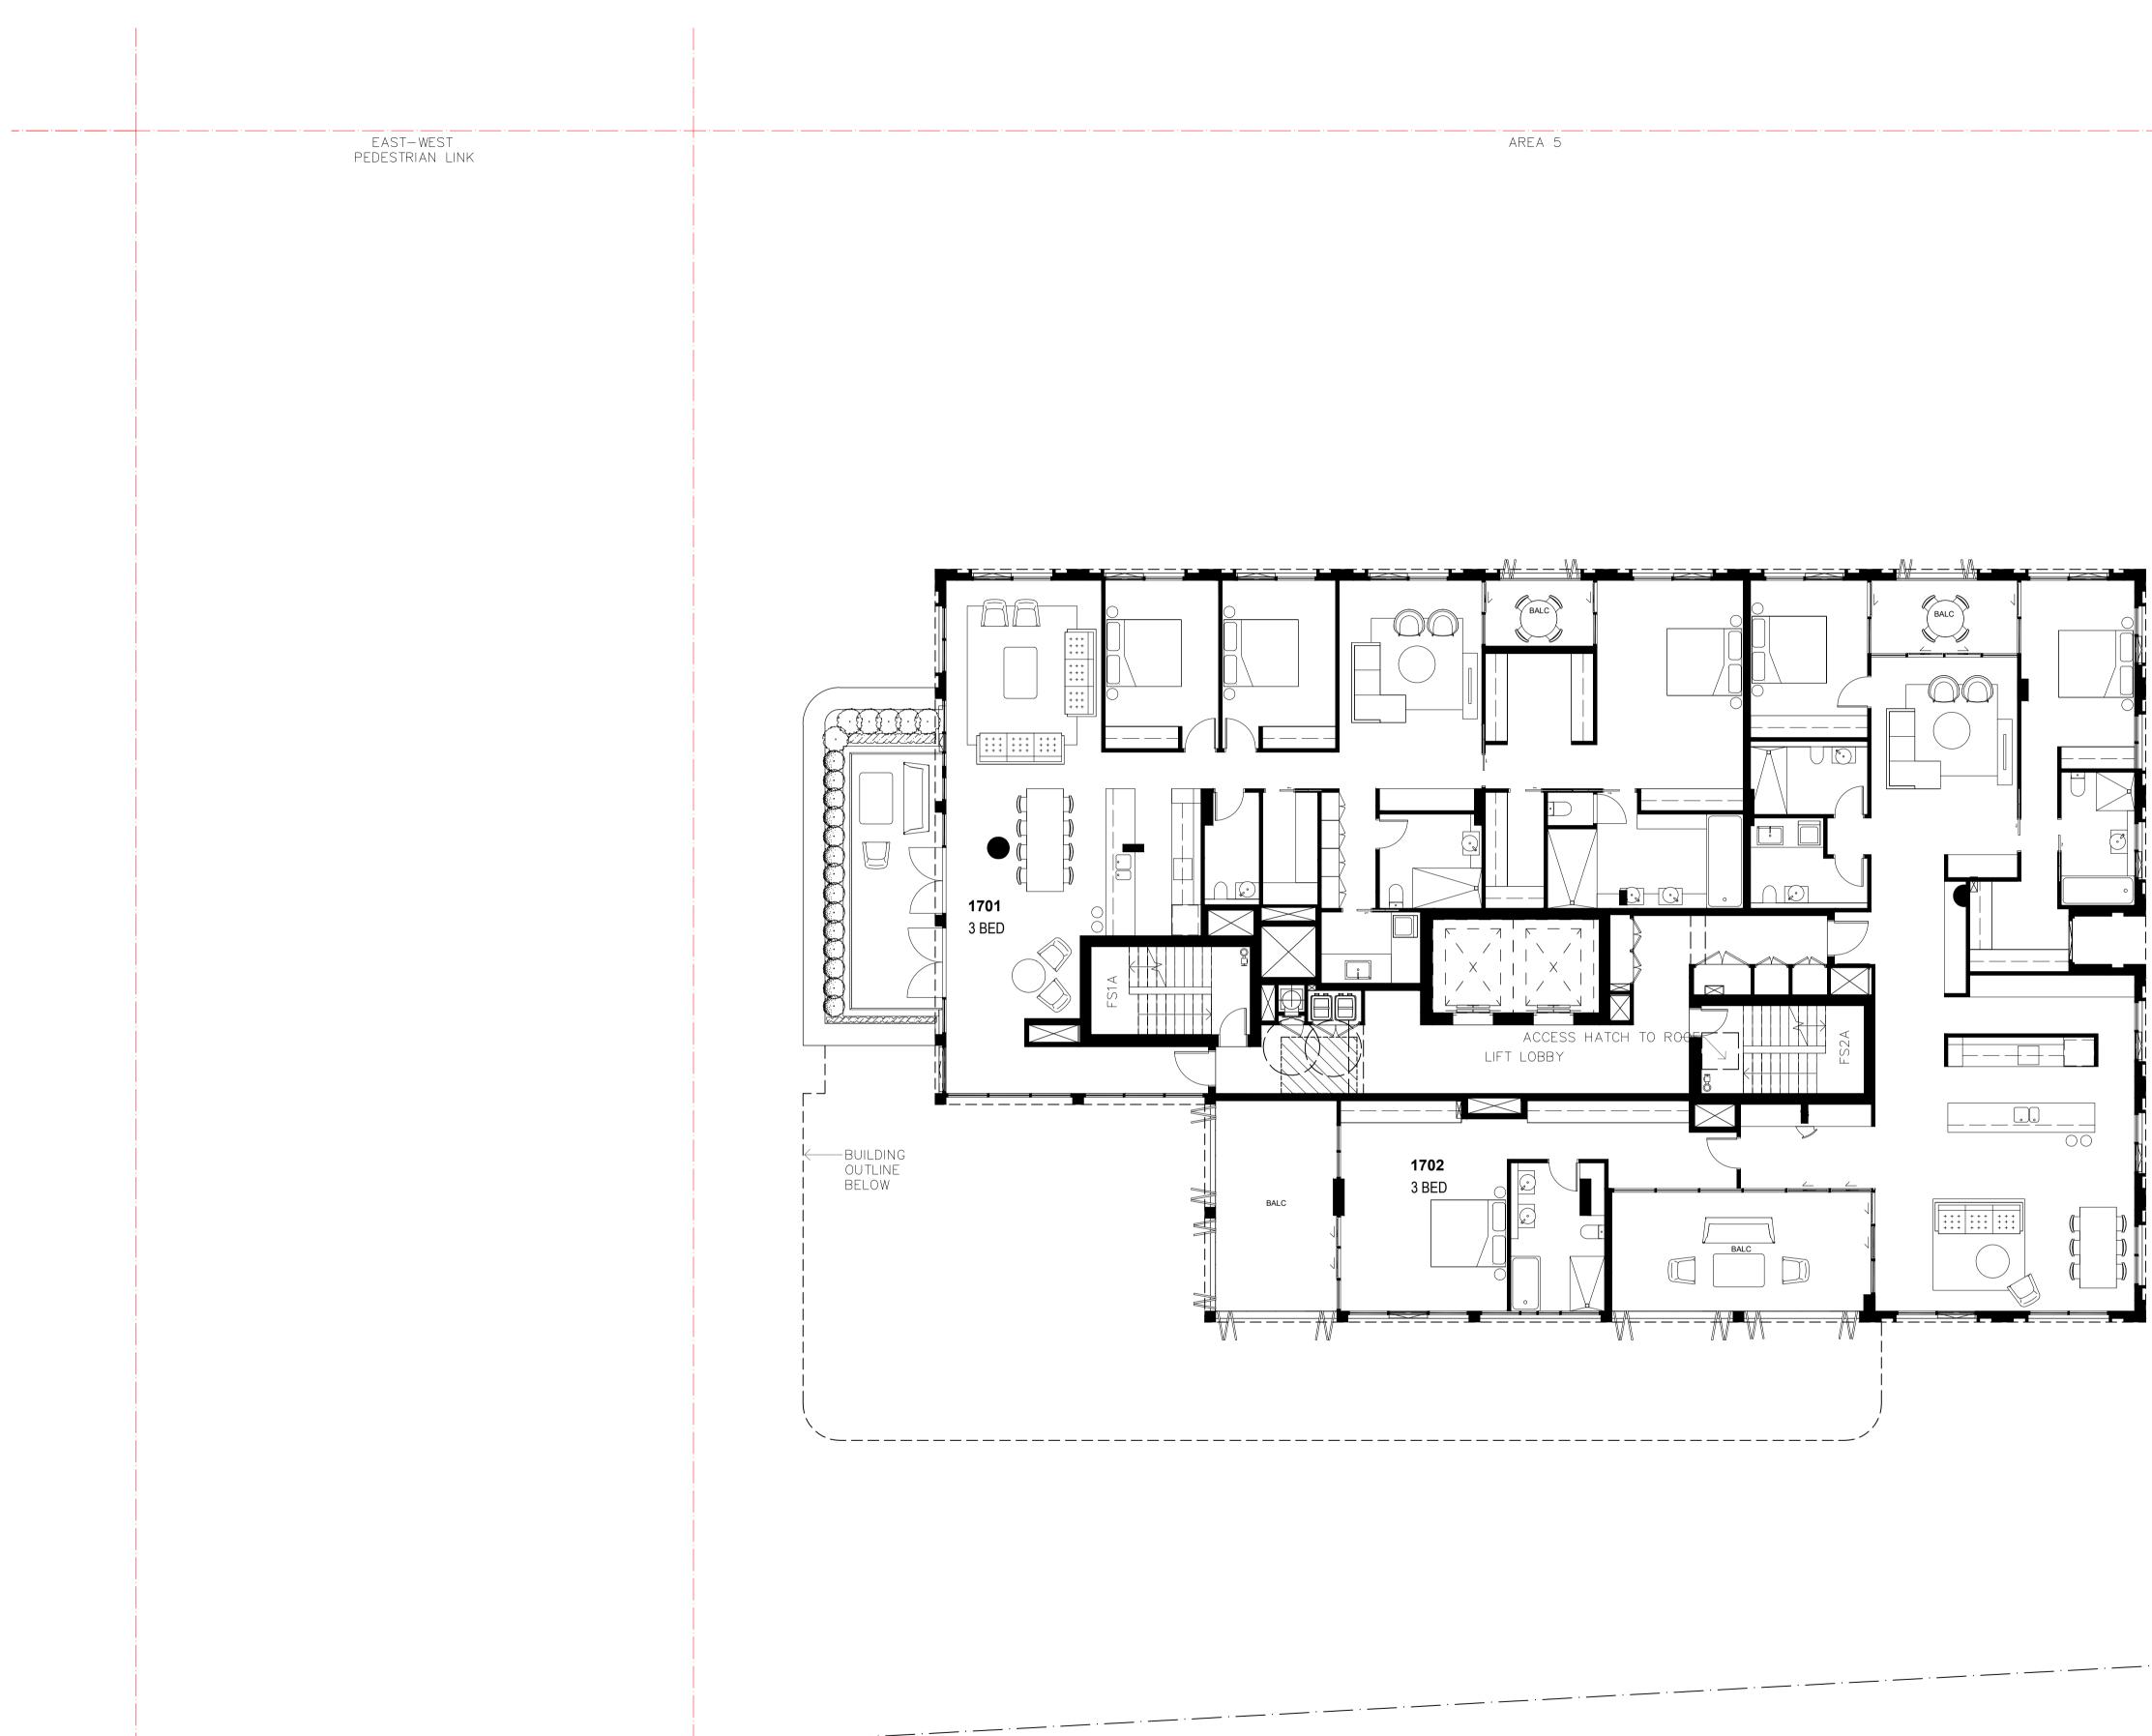
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DEVELOPMENT APPLICATION

Drawing Name: Landscape Level 16 General arrangement Scale: 1:100 @ A1

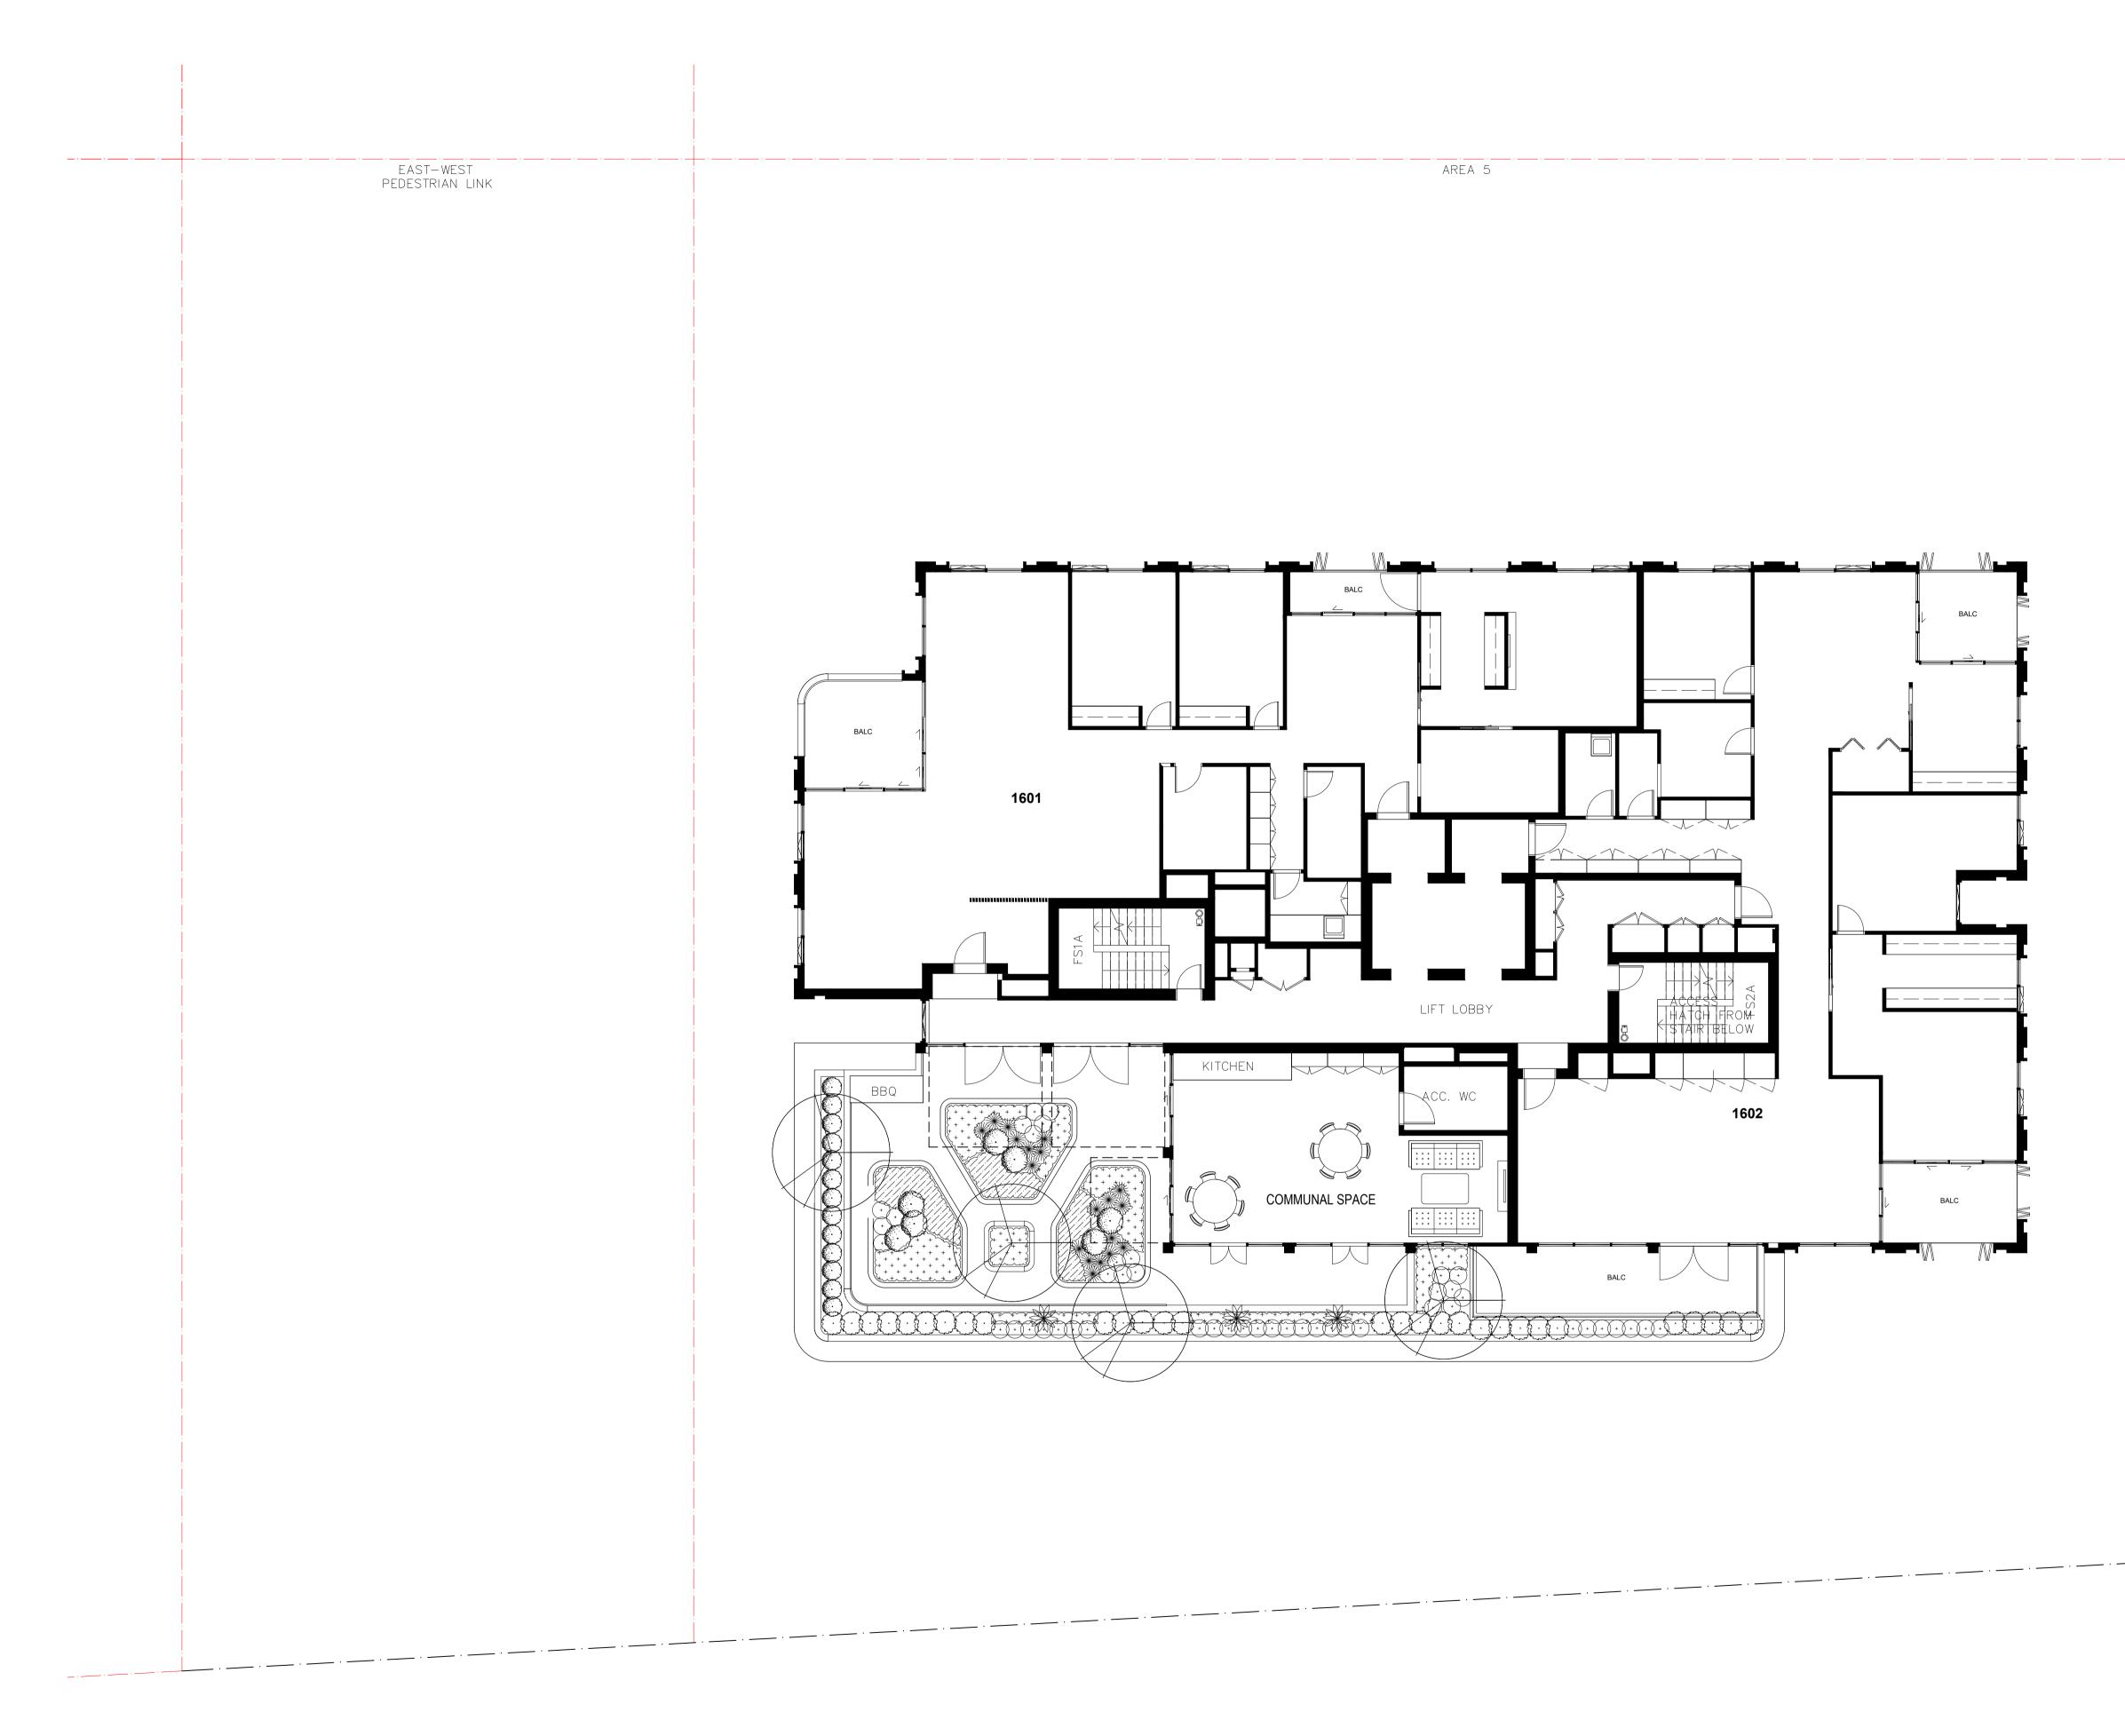
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Property Group

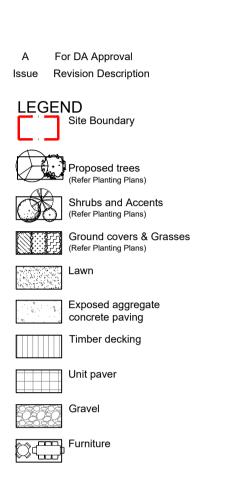

Project:

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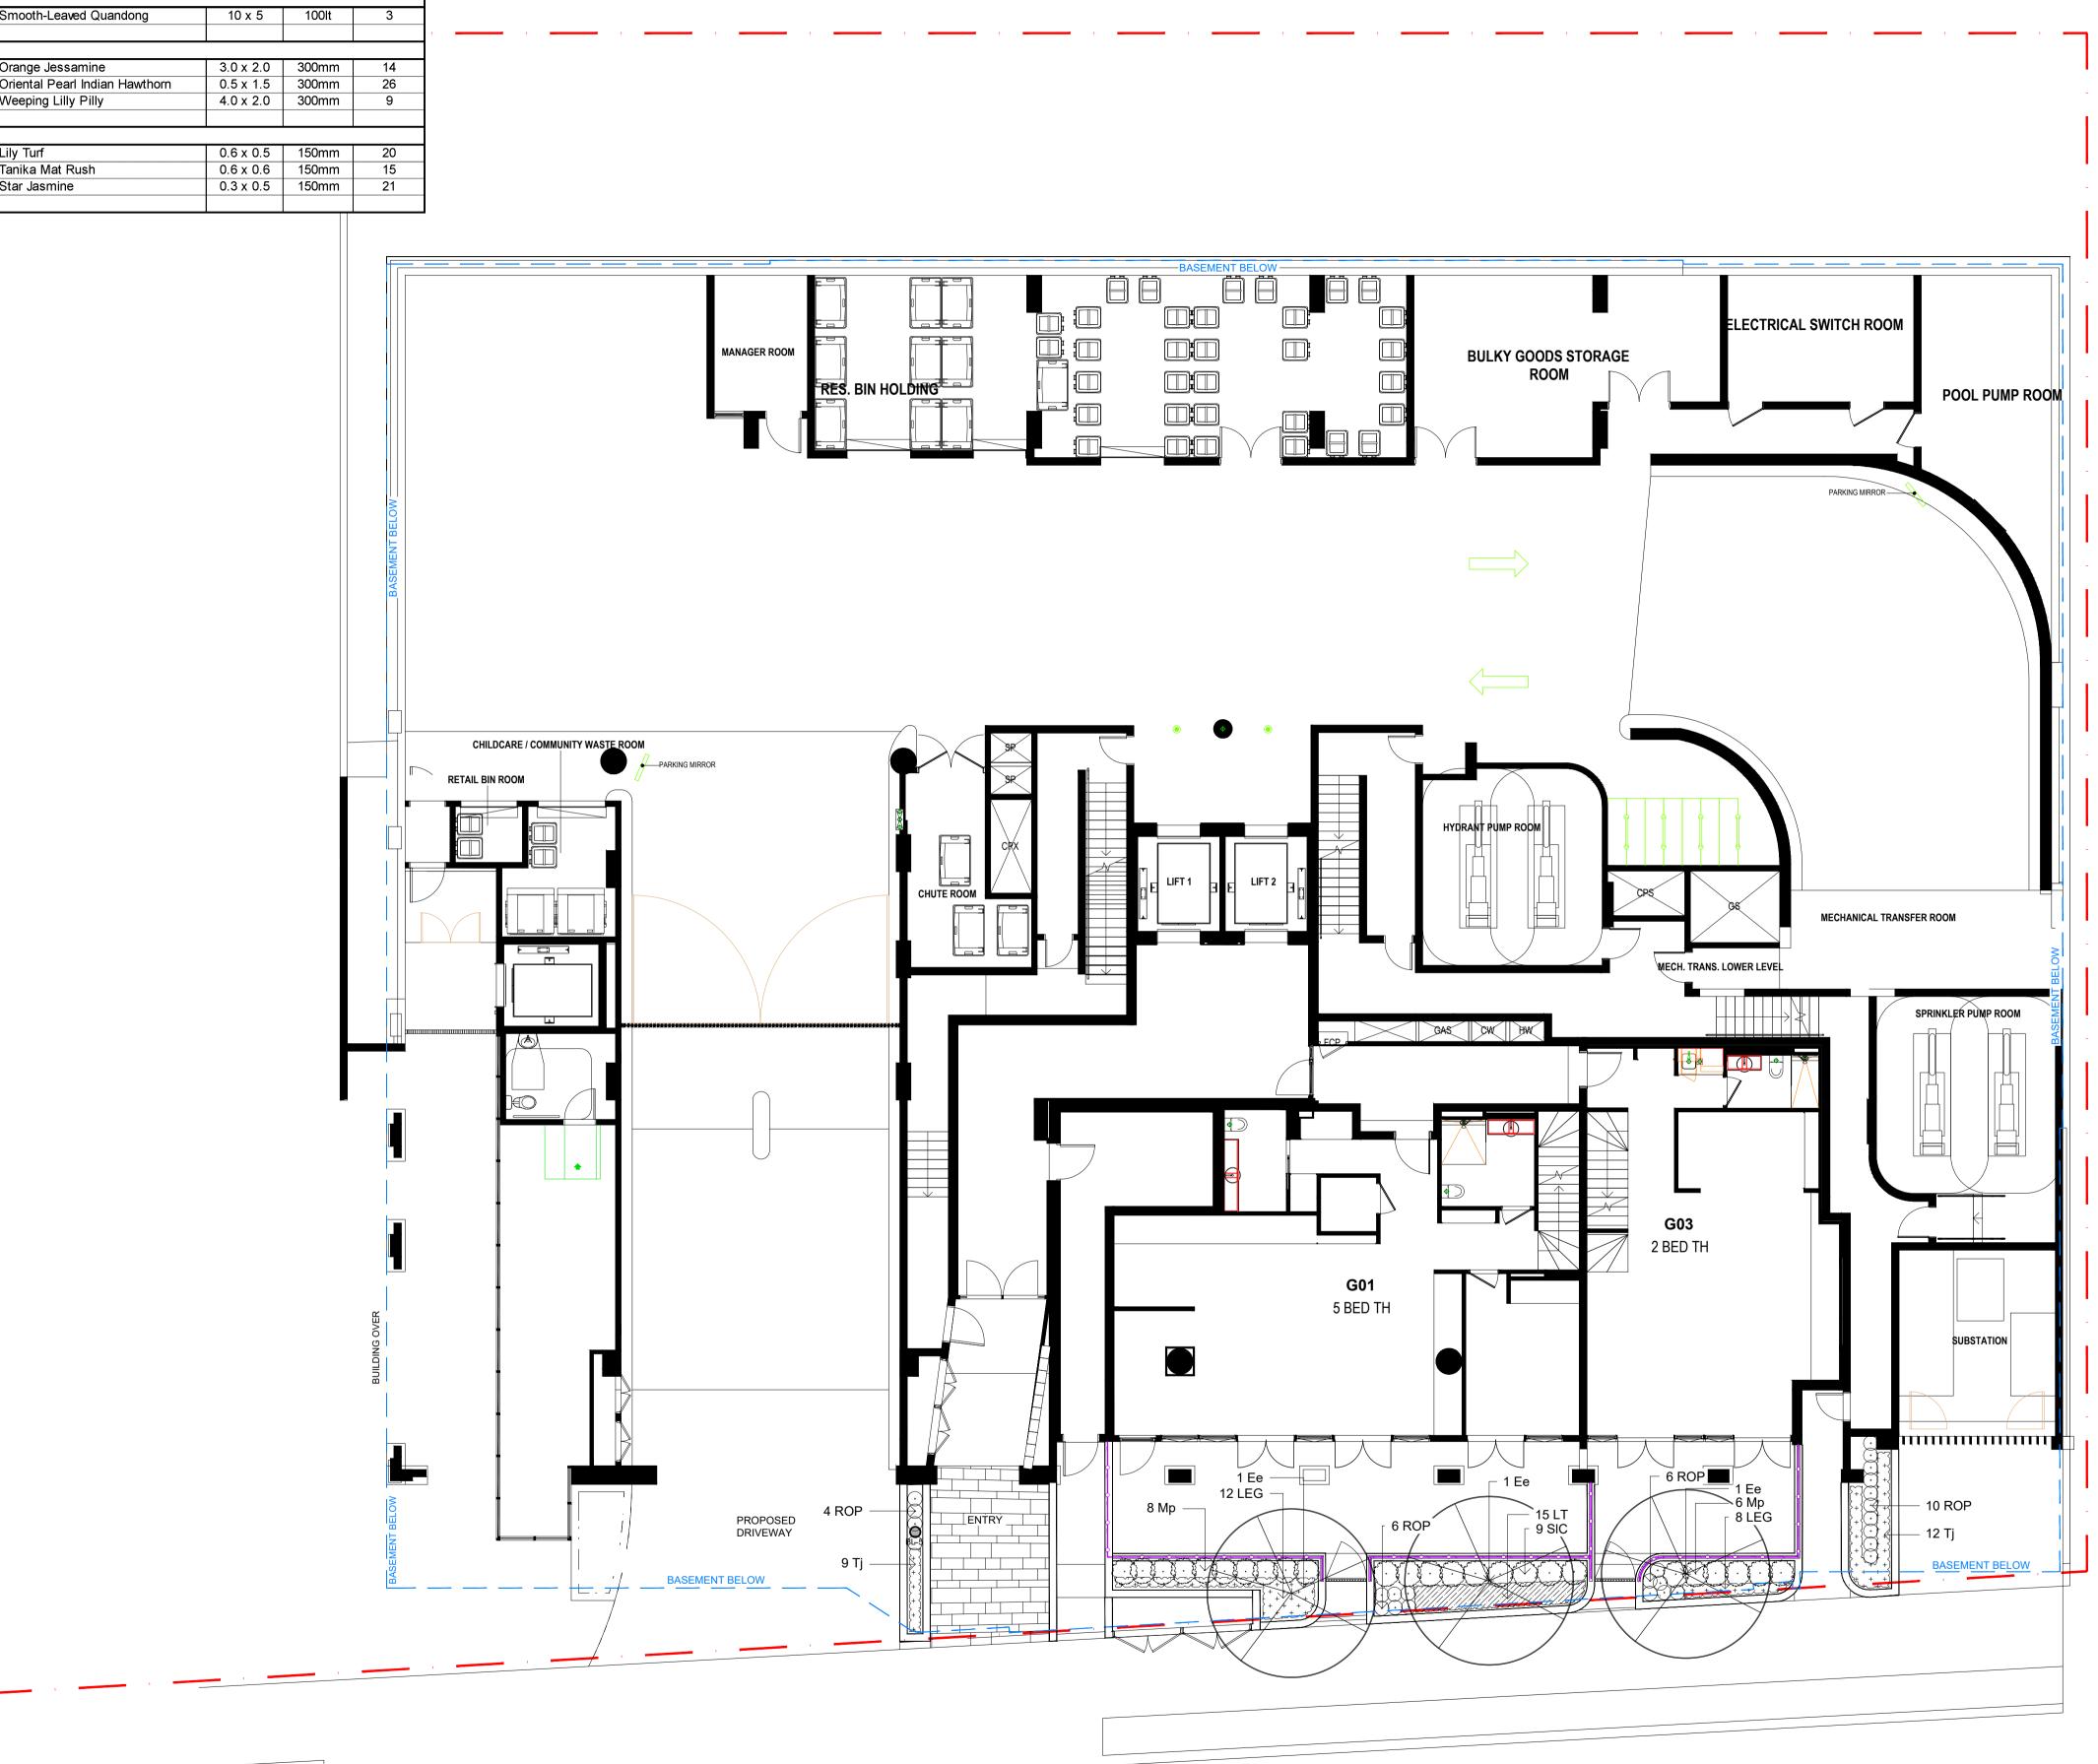
DEVELOPMENT APPLICATION

Drawing Name: Landscape Level 17 General arrangement Scale: 1:100 @ A1

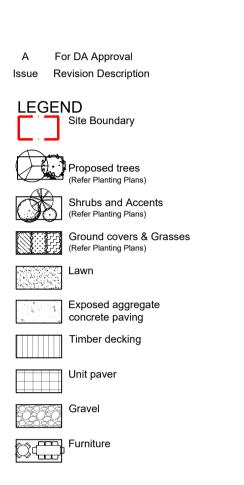Drawing Number: Issue AH-105 A

SS21-4691-1





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A For DA Approval

LEGEND

Lawn


Issue Revision Description

Site Boundary

(Refer Planting Plans)

Shrubs and Accents (Refer Planting Plans)

(Refer Planting Plans)

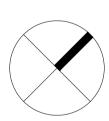

NH RS 08.04.2024

Drawn Check Date

Property Group

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Project:

Client: HYECORP



13 - 19 Canberra Ave St leonards

Drawing Number: Issue AH-200 A

SITE IMAGE

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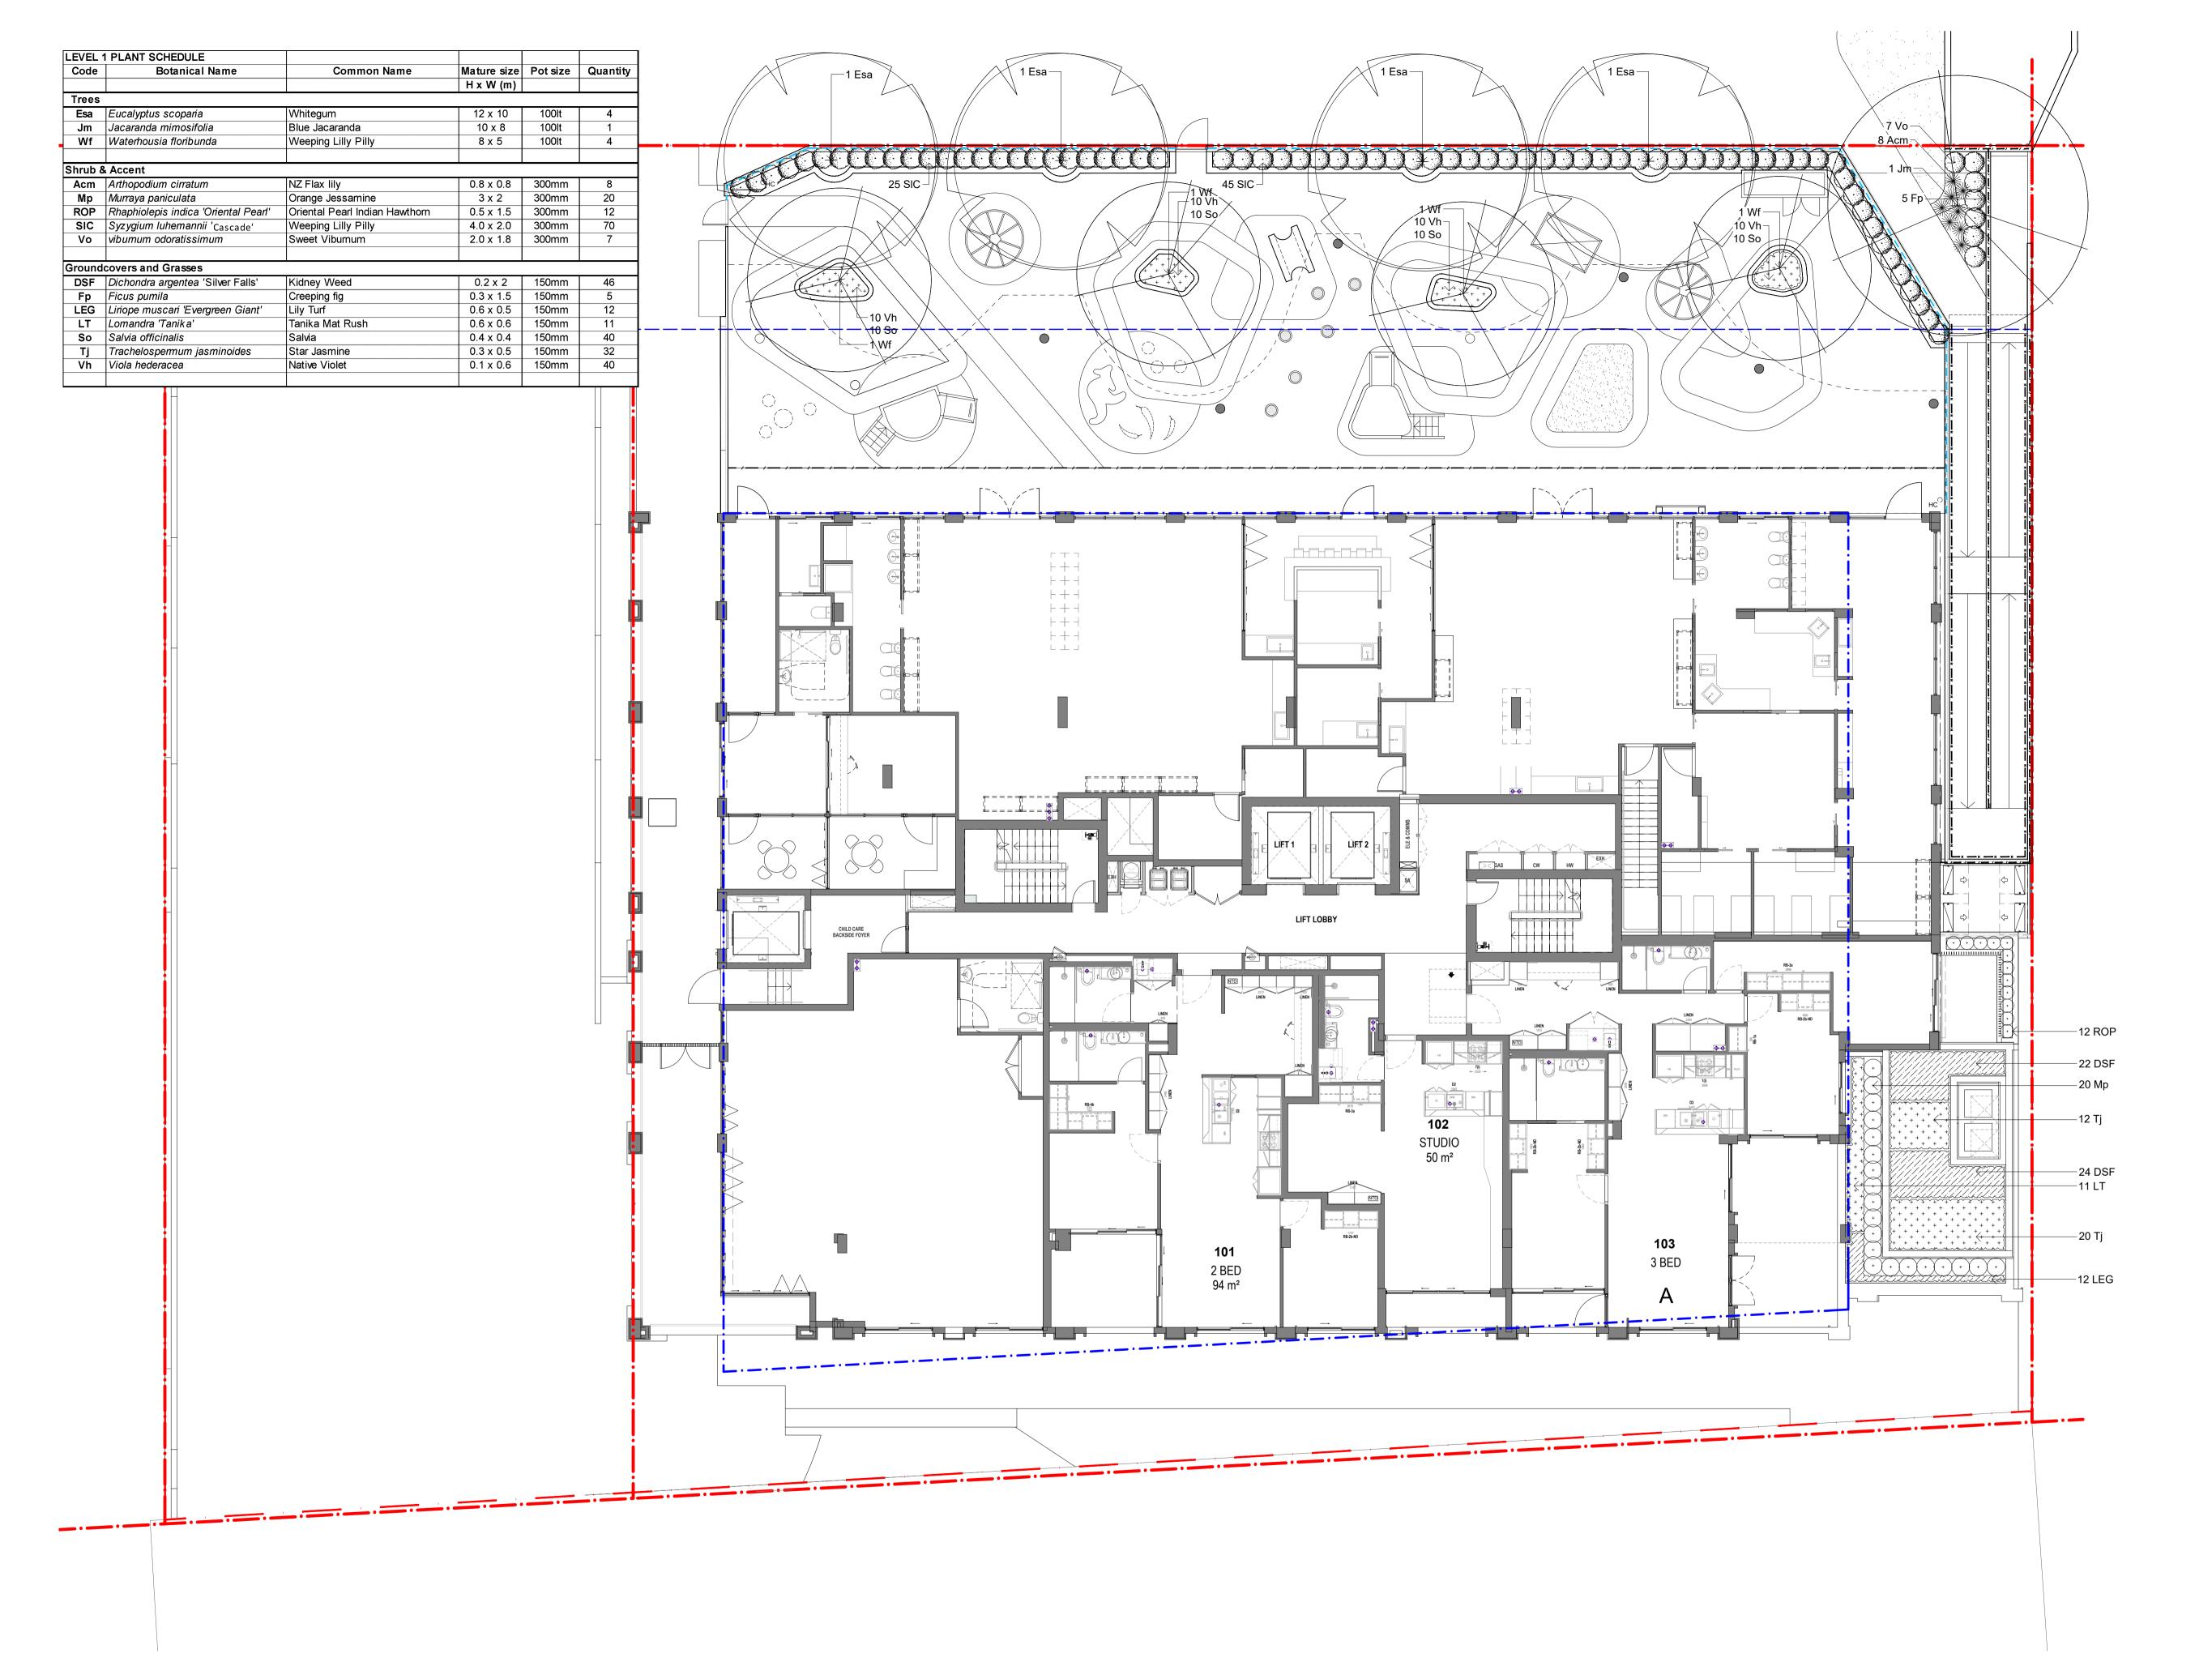
Planting plan

Scale: 1:100 @ A1

Job Number:

SS21-4691-1

Landscape Ground



SS21-4691-1

Scale: 1:100 @ A1 Job Number:

Planting plan

Landscape Level 1

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SITE IMAGE

DEVELOPMENT APPLICATION

Project: 13 - 19 Canberra Ave St leonards


Client: HYECORP Property Group





Ground covers & Grasses (Refer Planting Plans)

Shrubs and Accents (Refer Planting Plans)

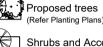





Site Boundary

LEGEND


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NH RS 08.04.2024 Drawn Check Date

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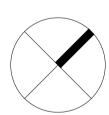
commencing work. Do not scale this drawing. Any required dimensions not shown shall be referred to the Landscape Architect for confirmation.

Code	Botanical Name	Common Name	Mature size	Pot size	Quantity
			H x W (m)		
Trees	•				
MLG	Magnolia grandiflora 'Little Gem'	Little Gem	5 x 3	100lt	4
Shrub 8	Accent				
KSS	Kalanchoe 'Silver Spoons'	Silver Spoons	1.5 x 1.0	300mm	3
Мр	Murraya paniculata	Orange Jessamine	3 x 2	300mm	49
Px	Philodendron 'Xanadu'	Dwarf Philodendron	1 x 1	300mm	30
ROP	Rhaphiolepis indica 'Oriental Pearl'	Oriental Pearl Indian Hawthorn	0.5 x 1.5	300mm	116
SIC	Syzygium luhemannii 'Cascade'	Weeping Lilly Pilly	4.0 x 2.0	300mm	6
Vo	viburnum odoratissimum	Sweet Viburnum	2.0 x 1.8	300mm	11
Ground	covers and Grasses				
DSF	Dichondra argentea 'Silver Falls'	Kidney Weed	0.2 x 2	150mm	35
LT	Lomandra 'Tanika'	Tanika Mat Rush	0.6 x 0.6	150mm	6
Tj	Trachelospermum jasminoides	Star Jasmine	0.3 x 0.5	150mm	234



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Drawing Name:

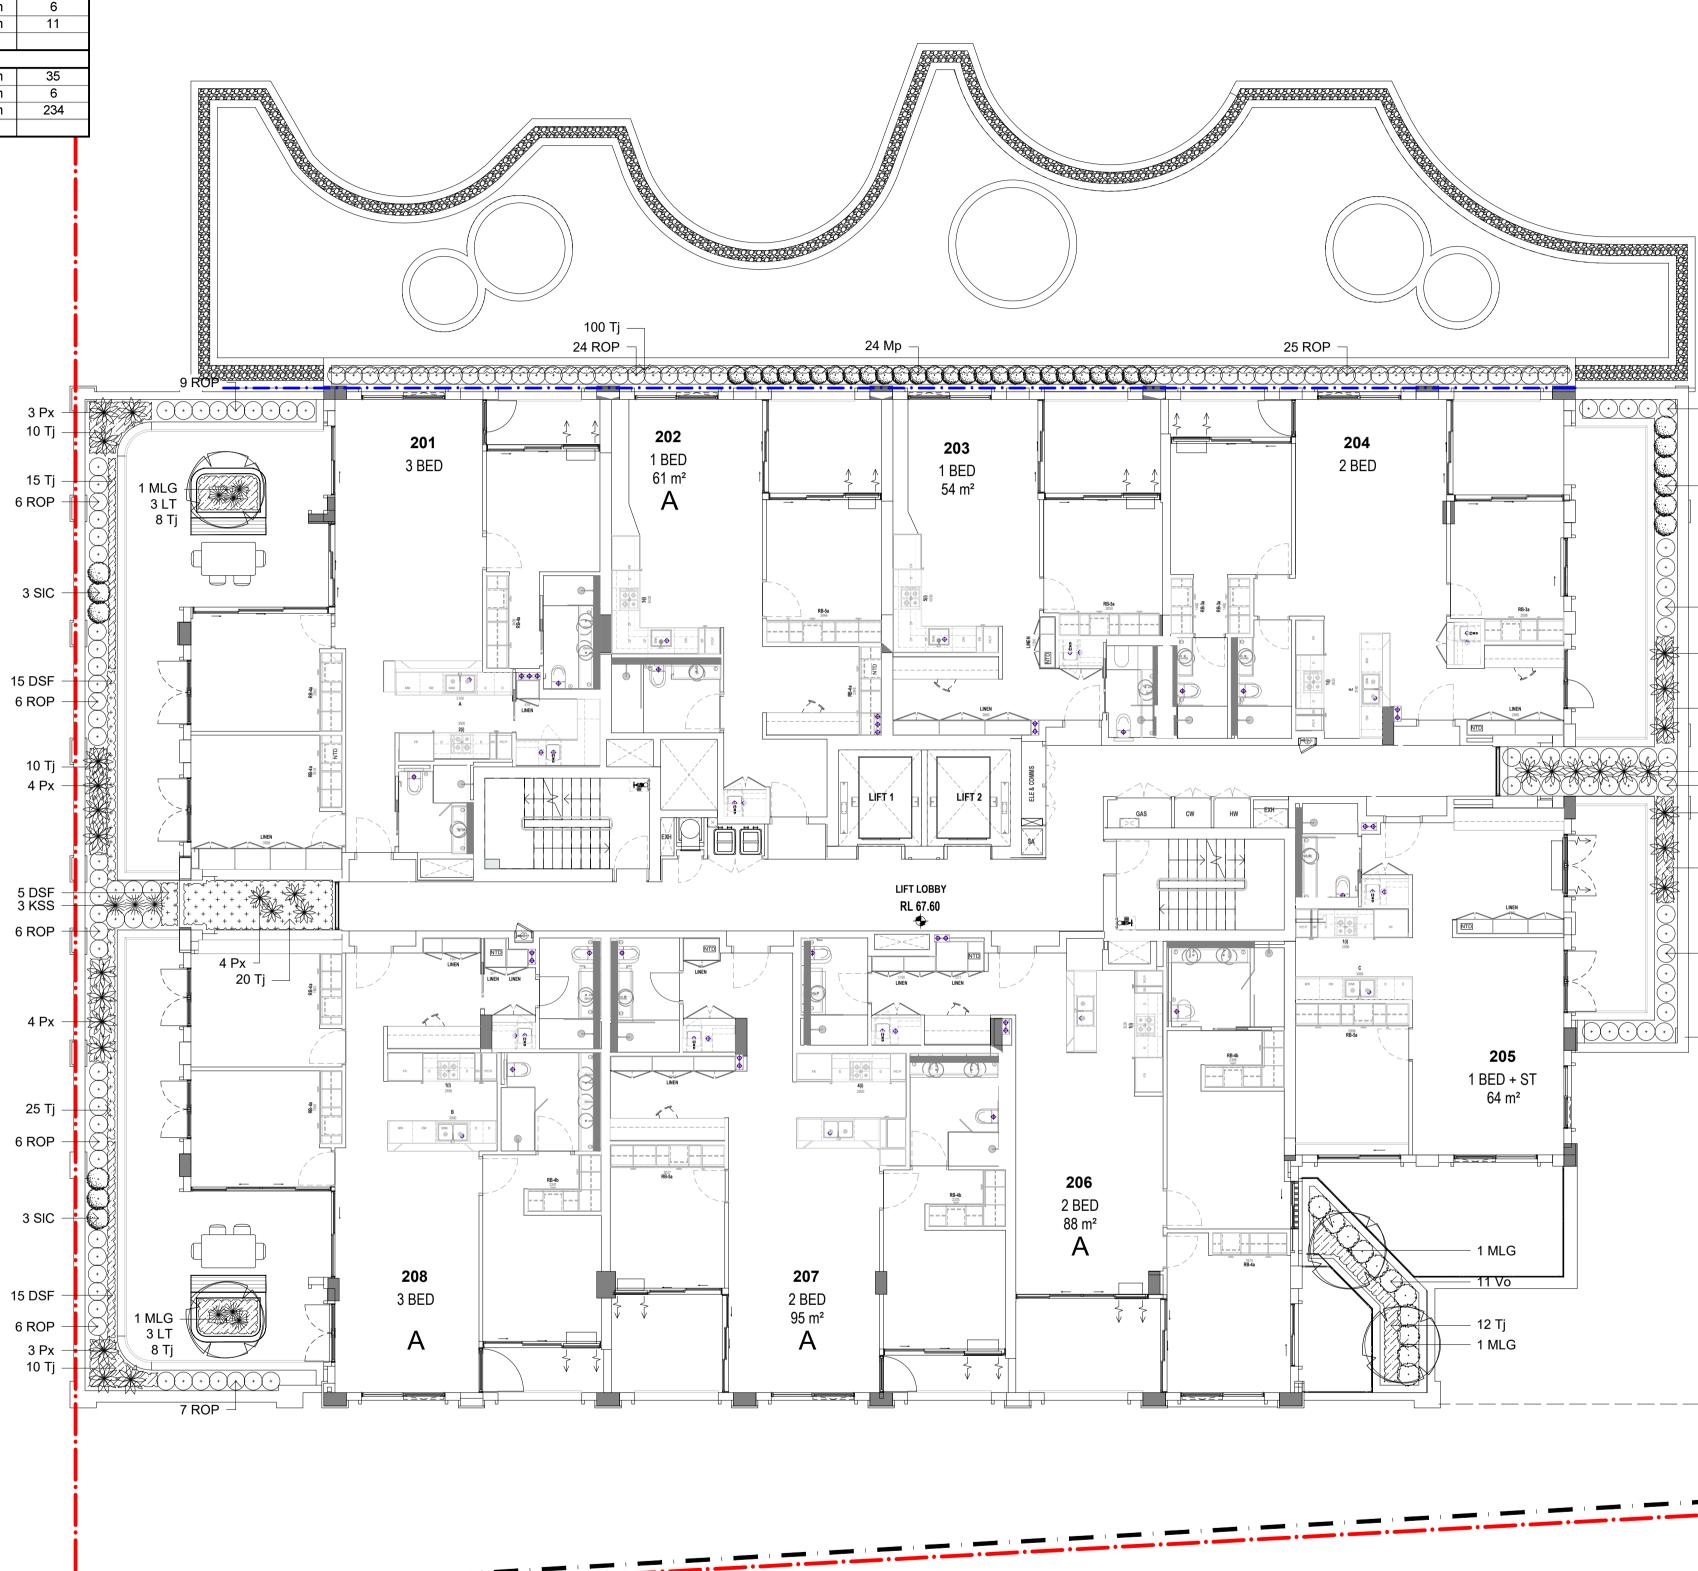Job Number:



Project:

13 - 19 Canberra Ave St leonards

Property Group

– 5 ROP

- 5 ROP

- 6 Mp

– 3 Px - 8 Tj

– 6 Px – 19 Mp - 3 Px – 8 Tj

11 ROP

. Lawn



Issue Revision Description

NH RS 08.04.2024 Drawn Check Date

Proposed trees (Refer Planting Plans) Shrubs and Accents (Refer Planting Plans)


LEGEND Site Boundary

Ground covers & Grasses (Refer Planting Plans)

SITE IMAGE

Landscape Architects

DEVELOPMENT APPLICATION

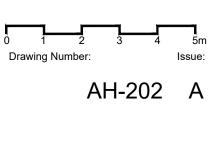


SS21-4691-1

Planting plan

Scale: 1:100 @ A1

Landscape Level 2

	4 PLANT SCHEDULE				
Code	Botanical Name	Common Name	Mature s	ize Pot size	Quantity
			H x W (I	m)	
Shrub 8	& Accent				
Cr	Cycas revoluta	Sago Palm	1.2 x 1.	5 300mm	12
ROP	Rhaphiolepis indica 'Oriental Pearl'	Oriental Pearl Indian Hawthorn	0.5 x 1.	5 300mm	21
Vo	viburnum odoratissimum	Sweet Viburnum	2.0 x 1.	8 300mm	26
Ground	covers and Grasses				
LT	Lomandra 'Tanika'	Tanika Mat Rush	0.6 x 0.	6 150mm	25
Tj	Trachelospermum jasminoides	Star Jasmine	0.3 x 0.	5 150mm	30

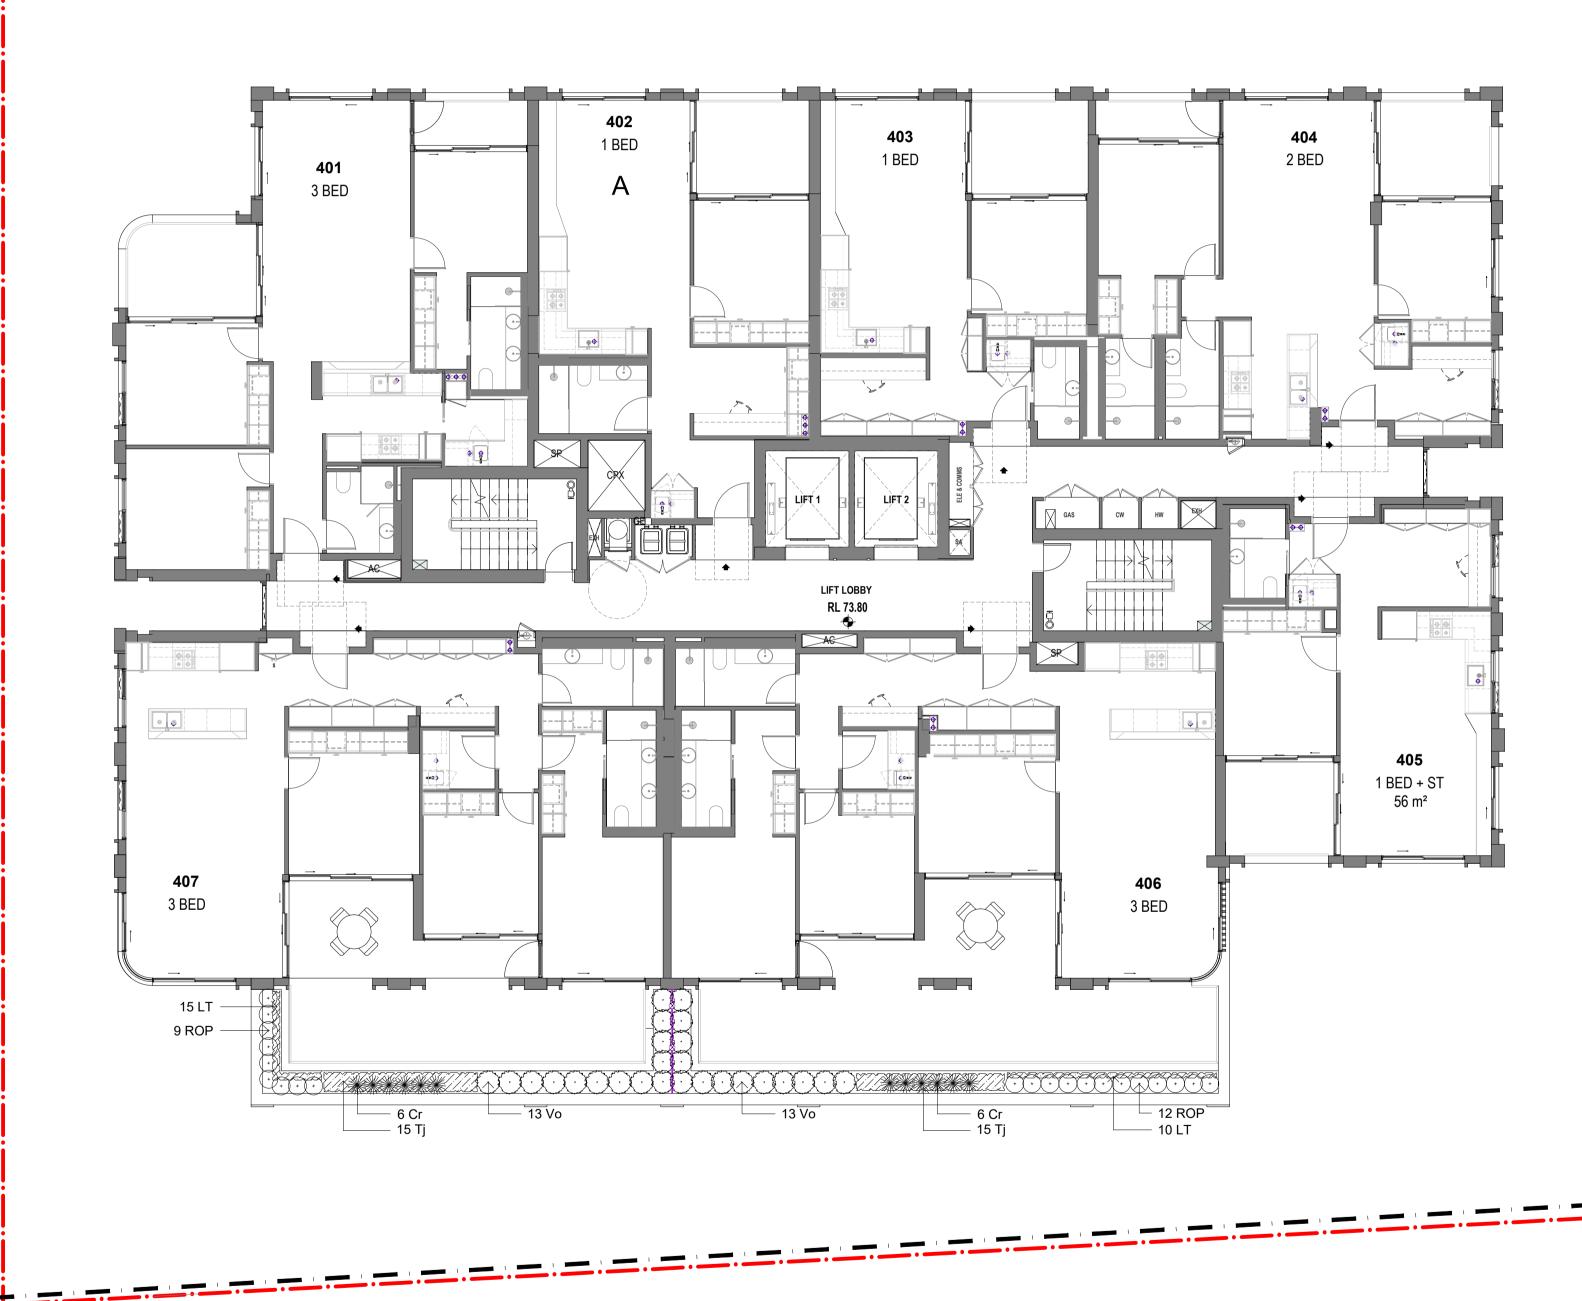

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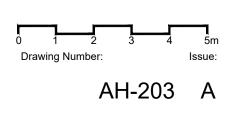


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DEVELOPMENT APPLICATION

Drawing Name: Landscape Level 4 Planting plan

Scale: 1:100 @ A1



SS21-4691-1

Job Number:

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Issue Revision Description



LEGEND Site Boundary






Shrubs and Accents (Refer Planting Plans)

(Refer Planting Plans)

Lawn

LEVEL '	16 PLANT SCHEDULE				
Code	Botanical Name	Common Name	Mature size	Pot size	Quantity
			H x W (m)		
Trees					
LiN	Lagerstroemia indica 'Natchez'	White Crepe Myrtle	6 x 3	100lt	2
MLG	Magnolia grandiflora 'Little Gem'	Little Gem	5 x 3	100lt	2
Shrub 8	k Accent				
Cr	Cycas revoluta	Sago Palm	1.2 x 1.5	300mm	3
GaF	Gardenia augusta 'Florida'	Gardenia	0.5 x 1.5	300mm	47
ROP	Rhaphiolepis indica 'Oriental Pearl'	Oriental Pearl Indian Hawthorn	0.5 x 1.5	300mm	44
Vo	vibumum odoratissimum	Sweet Vibumum	2.0 x 1.8	300mm	13
WWG	Westringia 'Wynyabbie Gem'	Wynyabbie Rosemary	1 x 1	300mm	16
Ground	covers and Grasses				
DSF	Dichondra argentea 'Silver Falls'	Kidney Weed	0.2 x 2	150mm	10
LT	Lomandra 'Tanika'	Tanika Mat Rush	0.6 x 0.6	150mm	57
Tj	Trachelospermum jasminoides	Star Jasmine	0.3 x 0.5	150mm	58

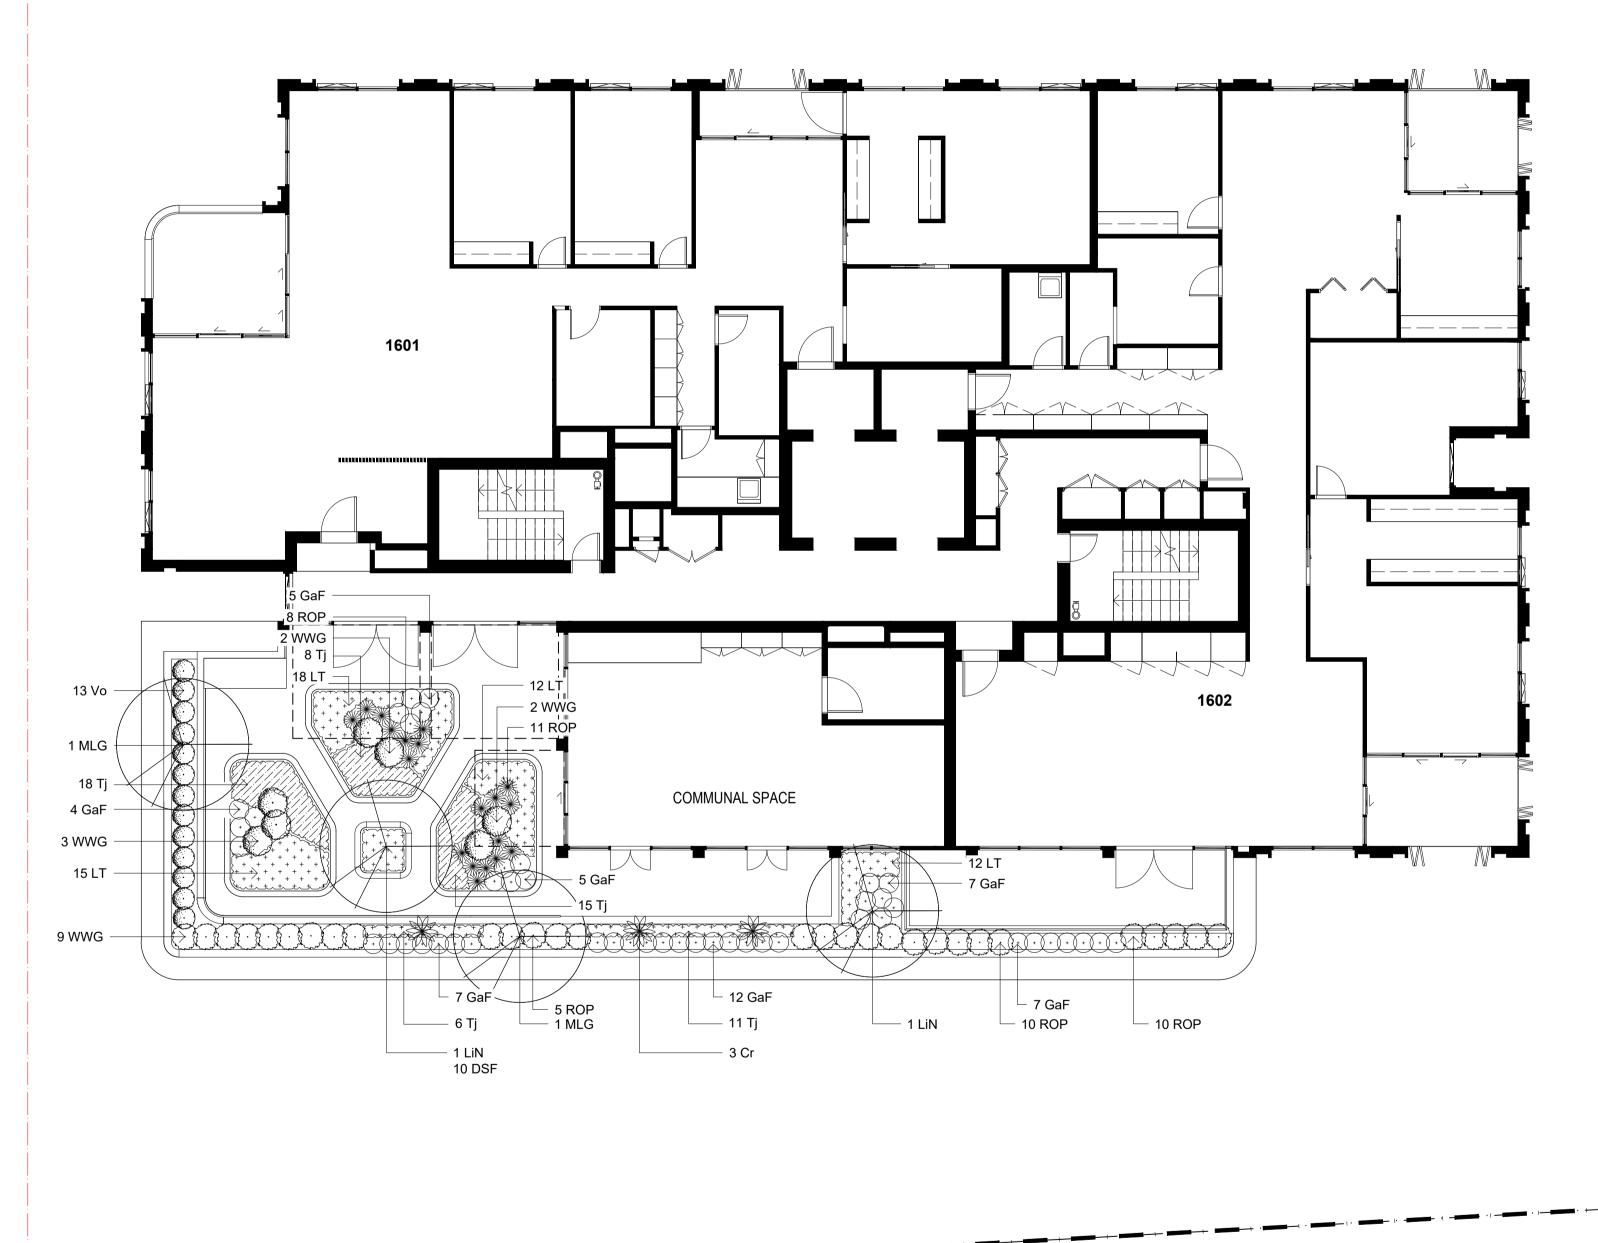

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LEGEND Site Boundary


Proposed trees (Refer Planting Plans)

Shrubs and Accents (Refer Planting Plans)

Lawn

Ground covers & Grasses (Refer Planting Plans)

Issue Revision Description

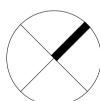


NH RS 08.04.2024

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Client:

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Project:



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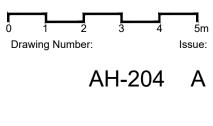
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DEVELOPMENT APPLICATION

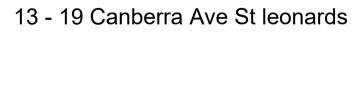Drawing Name: Landscape Level 16 Planting plan




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Scale: 1:100 @ A1


EAST-WEST PEDESTRIAN LINK

	17 PLANT SCHEDULE				
Code	Botanical Name	Common Name	Mature size	Pot size	Quantity
			H x W (m)		
Shrub 8	Accent				
Vo	vibumum odoratissimum	Sweet Viburnum	2.0 x 1.8	300mm	6
WWG	Westringia 'Wynyabbie Gem'	Wynyabbie Rosemary	1 x 1	300mm	14
Ground	covers and Grasses				
Тj	Trachelospermum jasminoides	Star Jasmine	0.3 x 0.5	150mm	16

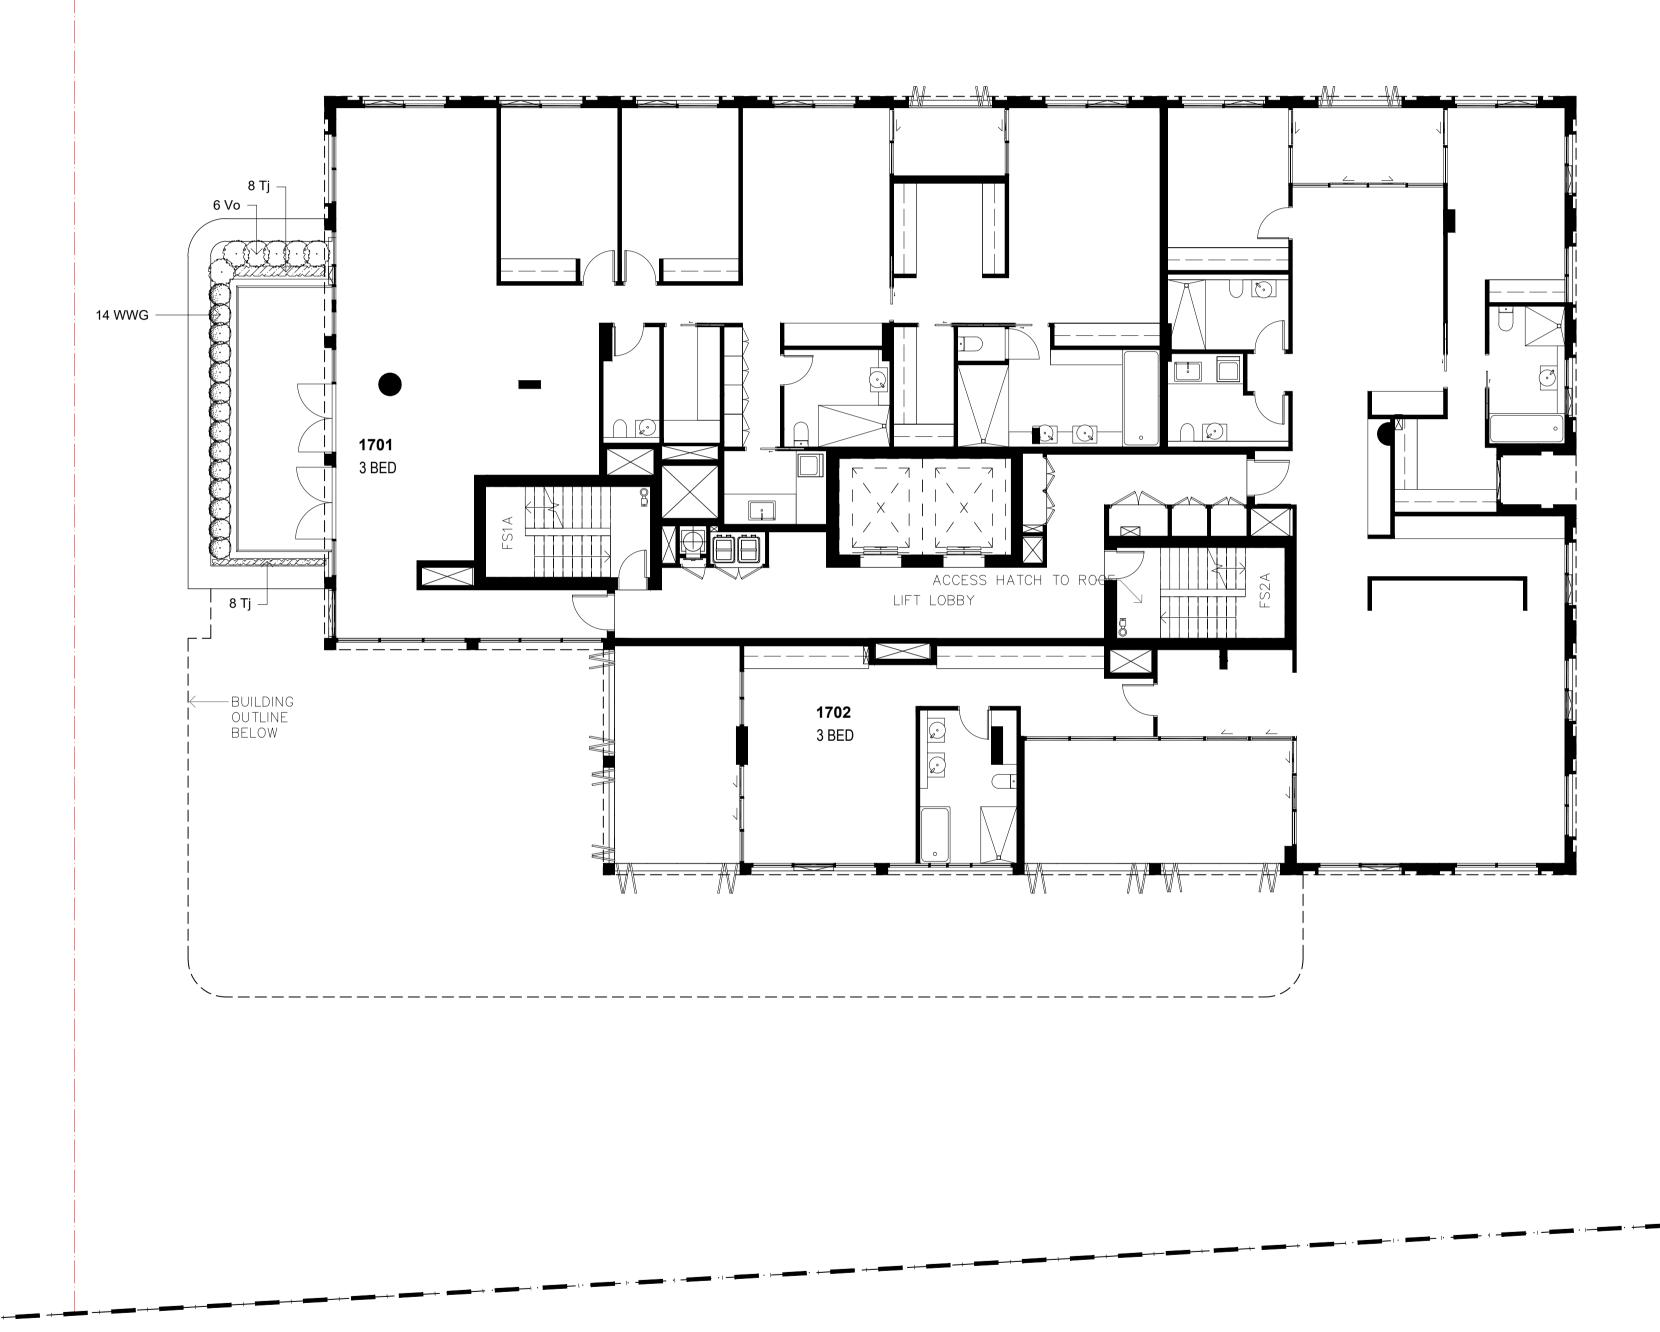

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Client: HYECORP

Property Group

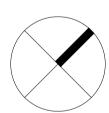

Project: 13 - 19 Canberra Ave St leonards

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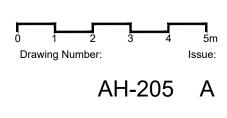
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DEVELOPMENT APPLICATION

Drawing Name: Landscape Level 17 Planting plan

Scale: 1:100 @ A1

Job Number:




SS21-4691-1

LEGEND Site Boundary

A For DA Approval Issue Revision Description

NH RS 08.04.2024 Drawn Check Date

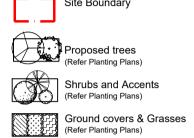

Lawn

LANDSCAPE SPECIFICATION NOTES

GENERAL NOTES

References

All plans and details included in the project documents shall be read in conjunction with this specification. All structural and civil works components of the landscape design shall be referenced to engineers' details and specifications. Read this specification in conjunction with the plant and materials schedules on the drawings. If in doubt about any detail or if conflicts are found in the documents, seek advice.

Workmanship and Materials

The whole of the landscape works shall be carried out by a competent, trained and qualified landscape contractor who is experienced in horticultural practices, landscape construction and planting techniques. The landscape contractor shall hold a current Building Contractors License and/or be a financial member of LNA Landscape Association NSW & ACT or equivalent organisations in other states.

EXISTING TREES AND SHRUBS

Trees and Shrubs to be Retained and Protected

Identify and mark trees and shrubs to be retained using a suitable non-injurious, easily visible and removable means of identification. Protect from damage the trees and shrubs to be retained, including those beyond the site area, both above and below the ground. If a tree becomes damaged during the works or it is proposed to perform work on a tree, give written notice immediately and obtain instructions.

Work Near Trees and Shrubs

Keep the area of the drip-line free from construction material and debris. Do not place bulk materials and harmful materials under foliage canopies or near trees. Do not place spoil from excavations against tree trunks. Prevent wind-blown building materials, such as cement, from covering trees and other plants. Do not remove topsoil from, or add topsoil to, the area within the drip-line of trees.

EARTHWORKS

Excavation, Trimming and Filling

Except as otherwise noted in the contract, bulk excavation is excluded from the landscape works. After the completion of bulk excavation by others, trim and fill the excavated ground surfaces to achieve design levels to accommodate finish materials as detailed. Prepare the sub-grade surface as required for the various finished ground treatments.

Site Drainage

Keep the excavated works drained and free of standing water. Allow to supply and install sub-soil drainage pipes as required for the new works to ensure that all gardens are well drained. Connect the sub-soil drainage pipes to the nearest downstream stormwater pits. Include pipe filter socks and course sharp aggregate backfilling of trenches.

HARDWORKS

Furniture, Handrails, Balustrades

Supply and install the scheduled items in accordance with the manufacturer's recommendations, as detailed and in the locations shown on plan. Provide all footings and fixings required for the items to be stable and in accordance with applicable codes and standards.

Balustrades: Equal to Stainform ONYX 50 316 Satin SS

Handrails: Equal to Stainform ONYX 50 316 Satin SS

Garden Walls, Fences, Steps, TGSI and Edging Construct garden walls, fences, steps, TGSI and edging as shown on plan, as detailed and of the material scheduled. Provide footings, step nosings, tactile surfaces to comply with Australian Standards and applicable legislation. Refer to engineer's details for structural retaining walls, concrete stairs, concrete strength, reinforcing and joint placement.

Continuous, Unit and Loose Pavement

naterial pavement to the locations shown on plan. Ensure that all subgrade/subsurface works are complete prior to commencing paving. Confer with the engineer to ensure the structural integrity of the subgrade. Ensure that the base course under paved surfaces is a continuous plane offering a constant depth of bedding material not exceeding 50mm. If laying unit pavers in a cement mortar bed on a concrete sub-base ensure that joints in paying match the location of joints in the concrete. Refer to engineer's details for heavy duty slabs, concrete stairs, concrete strength, reinforcing, and joint type and placement.

 Insitu concrete paths: Wood float coved finish, tool edged. Path joints: Construction joints at 3000mm centres max.

Landscape Structures

All landscape structures shall have a common appearance in detail and material content while providing for the functional design requirements. The structure of all elements shall consist of a base frame of structural grade hardwood timber of sizes that sustain spans and maintain stability. Refer to drawn details for further information.

SOFTWORKS

Site Soil Testing

Where site soil is to be retrieved from site and stored on site for reuse, undertake at least two (2) soil tests in locations as advised by the Project Manager or as shown on the plans. Provide results and recommendations regarding soil additives for the benefit of healthy plant growth and to adjust the soil components to achieve an appropriate planting medium for successful plant development. Where topsoil is imported to site no testing of the imported soil is necessary but ensure that imported soil can be supplied with test data to verify that it suits the design plants.

Subsoil

Excavate and/or fill all garden beds to bring the top of subsoil to at least 300mm below finished design soil levels. Excavate all turf areas to bring the subsoil to at least 100mm below finished design levels. In all areas shape the subsoil to fall to subsoil drains where applicable. Do not excavate within the drip line of trees and shrubs to be retained. Cultivate or rip the subsoil to a further depth of 100mm before placing top soil. Remove stones of size exceeding 25mm, clods of earth exceeding 50mm, and weeds, rubbish or other deleterious material brought to the surface during cultivation. Do not disturb services or existing tree roots. If necessary, cultivate these areas by hand. During cultivation, thoroughly mix in materials required to be incorporated into the subsoil, as recommended in the soil testing results and to manufacturer's recommendations. Trim the surface to design levels again after cultivation.

Subsoil Drainage

Provide and install subsoil drainage equal to Vinidex 65mm (min) Draincoil with filter sock at the base of slopes, on the high side of paths, at the base behind retaining walls and where water is likely to accumulate at depth in the soil. Connect all subsoil drainage to the nearest downstream stormwater pit to ensure that subsoil water is managed and channelled to a stormwater drainage system. On sites with cross fall of less than 1:50 install subsoil drains to remove excess water from the subsoil in areas where water is likely to accumulate and may not penetrate lower strata naturally. Rip the sub-base surface 150mm deep before placing any soil. Install drainage pipes in subsoil trenches backfilled with 10mm blue metal (basalt) equal to ANL Blue Metal.

Coordinate the connection of subsoil drains to stormwater pits with the Civil or Hydraulic contractor.

Topsoil

Import topsoil for the garden and turf areas, unless the topsoil can be provided from material recovered from the site, as recommended in the soil testing results. Spread the topsoil on the prepared subsoil and grade evenly, compact lightly and uniformly in 150mm layers. Avoid differential subsidence and excess compaction and produce a finished topsoil surface which has the following characteristics:

- Finished to design levels, allowing for mulch or turf, which is to finish flush with adjoining hard surfaces such as paths and edges;
- Smooth and free from inorganic matter, stones or clods of soil; • Graded to drain freely, without ponding, to catchment and/or sub-soil drains;
- Graded evenly to adjoining surfaces; and • Ready for planting.

Compost

Provide, in accordance with AS 4454, well rotted vegetative material or animal manure, free from harmful chemicals, inorganic matter, grass, weeds and the reproductive parts of unwanted plants.

Fertilise

Provide proprietary fertilisers, delivered to the site in sealed containers marked to show manufacturer or vendor, weight, fertiliser type, N:P:K ratio, recommended uses, application rates and safety procedures. Apply appropriate fertiliser suited to the provenance of plants (indigenous or exotic) included in the design.

- Supply plants in accordance with the landscape design drawings and schedules, which have the following characteristics • Large healthy root systems, with no evidence of root curl, restriction or damage;
- Vigorous, well established, free from disease and pests, of good form consistent with the species/variety;
- Hardened off, not soft or forced, and suitable for planting in the natural climatic conditions prevailing at the site in full sun, partial shade or full shade conditions; • Grown in final containers for not less than twelve weeks;
- Trees, unless required to be multi-stemmed, shall have a single leading shoot; and • Containers shall be free from weeds and of appropriate size in relation to the
- specified plant size.

Plant Installation

Following excavation of the planting hole, place and spread 15gms of wetting agent pre-mixed with one (1) litre of water. Place the plant correctly orientated to north or for best presentation. Backfill the planting holes with specified topsoil mixture. Lightly tamp and water to eliminate air pockets. Ensure that the backfill soil is not placed over the top of the root ball and that the root ball is not higher than the soil in which it is planted. Apply fertiliser, as specified around the plants in the soil at the time of plantin<u>g</u>.

Embankment Stabilisation

Where necessary and shown on the drawings prevent soil erosion or soil movement by stabilising embankments as follows. As a minimum, this should be on slopes steeper than or equal to 1:3 gradient. Stabilise embankments using biodegradable fibre reinforced heavy weight jute fabric. Lay fabric from top to bottom of slope. Install in accordance with manufacturer's specification, including 300 x 300mm anchor trench at top and bottom of slope, backfilled with soil over the fabric and compacted into the trenches. Using U-shaped galvanised steel pegs at 1000 mm centres generally and 250mm centres at edge overlaps, secure the fabric to the prepared soil surface. Plant through the fabric after it is installed.

Root Barrier

Supply and install root control barriers to all new tree plantings adjacent to walls, paths, kerbs and all service trenches, where their proximity poses a threat to the stability of the built infrastructure. Install in accordance with manufacturer's recommendations.

Mulch

Unless noted otherwise, mulch shall be approved proprietary recycled wood fibre or pine bark material. Place mulch in all garden beds to a depth of 75mm after all specified plants are installed. Keep mulch clear of all plant stems and rake to an even plane, flush with the surrounding surfaces evenly graded between design surface levels. Over fill to allow mulch to settle to the specified depth.

Stakes and Ties

Stakes shall be durable hardwood, straight, free of knots and twists, pointed at one end, in the following quantities and sizes for each of the various plant pot sizes:

• Plants >25 lt: 1 off 38 x 38 x 1200mm;

• Semi-advanced plants >75 lt: 2 off 50x50x 1800mm;

• Advanced plants >100 It: 3 off 50 x 50 x 2400mm.

Turf

Turf shall be delivered to site as 25mm minimum thick cut rolls. Obtain turf from a specialist grower of cultivated turf. Turf shall have an even thickness, free from weeds and other foreign matter. Deliver turf to the site within 24 hours of being cut and lay it within 24 hours of delivery. Prevent it form drying out between cutting and laying. Lay the turf in the following manner:

- In stretcher pattern, joints staggered and close butted;
- Parallel long sides of level areas, with contours on slopes; and • To finish flush, after lightly tamping, with adjacent finished surfaces and design levels.
- Species: Stenotaphrum secundatum Sir Walter Soft-leaf Buffalo.

IRRIGATION


Scope: Unless otherwise noted or instructed irrigate all planted areas shown on plans including planters, tubs, gardens, turf and the like. The irrigation system shall be an automatic permanent system, with an irrigation controller self operated via a soil moisture sensor. The system shall be calibrated to deliver the optimum rate and volume of water appropriate to the type of plants in the design. The system shall be adjustable and fully serviceable. The layout of the entire irrigation system shall focus on delivering the required amount of water to maintain healthy and vigorous growth. The irrigation system shall be such that, component theft, vandalism, over-spray and wetting of paths shall be reduced to a minimum or eliminated with the use of drip, pop-up sprinklers and judiciously placed fixed spray emitters. Generally, do not use fine mist emitters that provide a drifting mist that may wet paths and the buildings unless specifically required by the design.

The Landscape Contractor shall engage a qualitied irrigation consultant to design the system, document all components, accessories and materials for review by the Landscape Architect prior to starting landscape works generally.

LANDSCAPE MAINTENANCE

The Landscape Contractor shall rectify defects during installation and that become apparent in the works under normal use for the duration of the contract Defects Liability Period. Unless contracted otherwise, the Landscape Contractor shall maintain the contract areas by the implementation of industry accepted horticultural practices for 52 weeks from Practical Completion of the works. The landscape maintenance works shall include, but not be limited to: Replacing failed plants;

- Pruning;
- Insect and pest control;
- Fertilising; Maintaining and removing stakes and ties;
- Maintaining mulch;

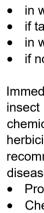

 Mowing and top dressing; Irrigation and watering; Erosion control; and

Weeding and rubbish removal.

Maintenance Log Book

Implement and keep a maintenance log book recording when and what maintenance work has been undertaken and what materials, actions and decisions have been used, implemented and concluded to keep the landscape always looking its best. Enter data daily and review information every 2 weeks. Observe trends and develop a maintenance regime around seasonal and observed event occurrences.

Maintenance Activities

During the defect maintenance period schedule the following activities to occur on a timely basis.

Plant replacement - Replace plants that have failed to mature, die or are damaged. Replacement plants shall be in a similar size and quality and identical species or variety to the plant that has failed. Replacement of plants shall be at the cost of the landscape contractor unless advised otherwise. If the cause of the failure is due to a controllable situation then correct the situation prior to replacing plants. Observe and replace failed plants within 2 weeks of observation.

Pruning - Prune dead wood, broken limbs, dead or infected foliage and as needed to develop strong, healthy plants to achieve the shape and form expected of the plant type. Observe daily and prune plants as necessary to maintain acceptable growth

Insect, disease and pest control - Avoid spraying: if ever possible; in wet weather or if wet weather is imminent;

• if target plants are still wet after rain; in windy weather; and

if non-target species are too close.

Immediately report to the Project Manager any evidence of intensive weed infestation, insect attack or disease amongst plant material. Submit all proposals to apply chemicals and obtain approval before starting this work. When approved, spray with herbicide, insecticide, fungicide as appropriate in accordance with the manufacturers' recommendations. Observe daily and act as necessary to control any infestation or disease. Record in the logbook all relevant details of spraying activities including: • Product brand / manufacturer's name,

Chemical / product name,

Chemical contents,

Application quantity and rate

Date of application and location,

 Results of application, and Use approval authority.

Fertilising

Fertilise gardens with a proprietary slow release fertiliser applied in accordance with the manufacturer's directions and recommendations. Apply 6-12 monthly. Record in the logbook all relevant details of fertilising including: Product brand / manufacturer's name,

• Fertiliser / product name,

• Application quantity and rate, and • Date of application and location.

Stakes and ties - Adjust and replace as required to ensure plants remain correctly staked. Remove those not required at the end of the planting establishment period (Defects Liability Period). Inspect and act at least every 2 weeks.

Maintaining mulch - Maintain the surface in a clean, tidy and weed free condition and reinstate the mulch as necessary to ensure correct depth as specified. Observe weekly and replenish mulch as required.

Mowing and top dressing - Mow the turf to maintain a grass height of between 30-50mm. Do not remove more than one third of the grass height at any one time. Remove grass clippings from the site after each mowing. Top dress to a maximum of 10mm to fill depressions and hollows in the surface. Mow weekly/fortnightly in warmer months. Mow monthly or as required in cooler months. Top dress at approximately 6 monthly intervals.

Irrigation and watering - Maintain the irrigation system to sure that each individual plant receives the required amount of water to maintain healthy and vigorous growth. Adjust and calibrate as required. Provide additional watering, if necessary but inspect irrigation weekly and make repairs as necessary.

Erosion control - Where necessary, maintain the erosion control fabric in a tidy and weed free condition and reinstate as necessary to ensure control measures are effective where deemed necessary. Inspect every 2 weeks and act to repair any damage as soon as possible.

Weeding and rubbish removal - During the plant establishment period remove by hand, rubbish and weed growth that may occur or re-occur throughout all planted, mulched and paved areas. The contractor shall target weeds that are capable of producing a major infestation of unwanted plants by seed distribution. Whenever possible, time weed removal to precede flowering and seed set. Constant observation and removal of weeds is essential.

SS21-4691-1

AH-500 A

Job Number

Landscape specification notes

DEVELOPMENT APPLICATION

Drawing Number

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Australia

Drawing Name:

Scale:


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SITE IMAGE

Landscape Architects

13 - 19 Canberra Ave St leonards

HYECORP **Property Group**

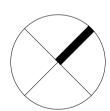

LEGEND

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Drawn Check Date


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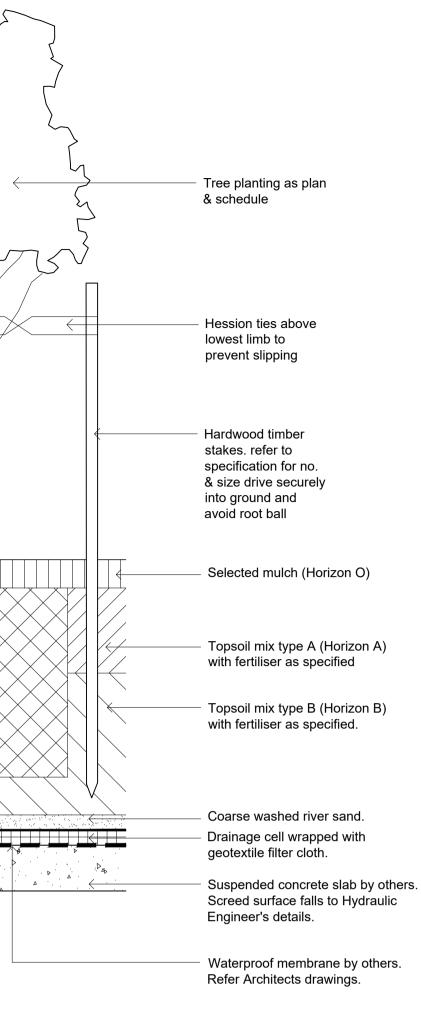
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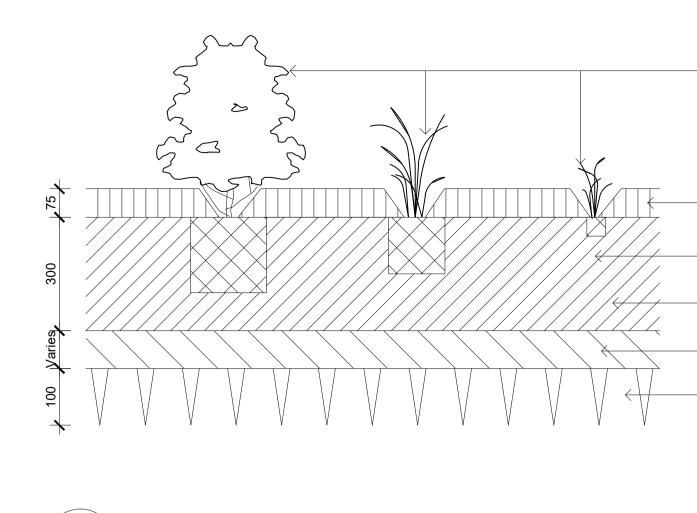
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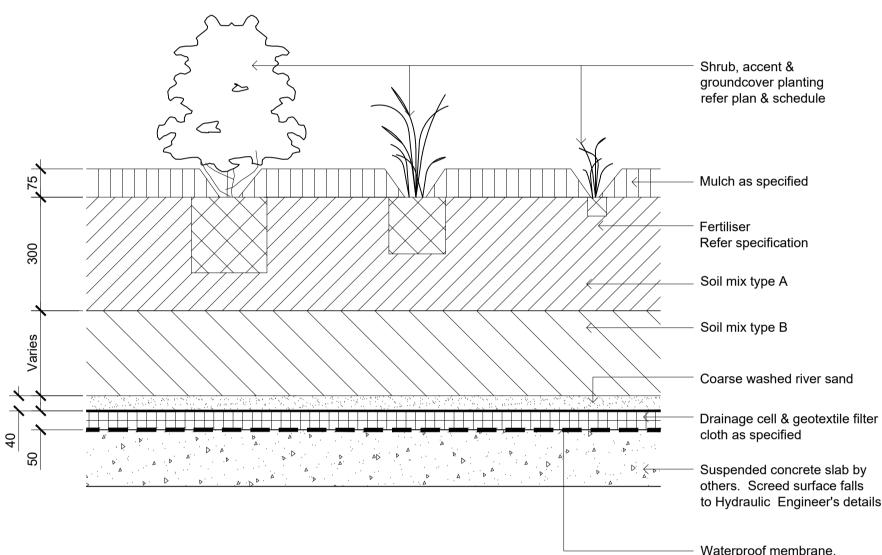



A1







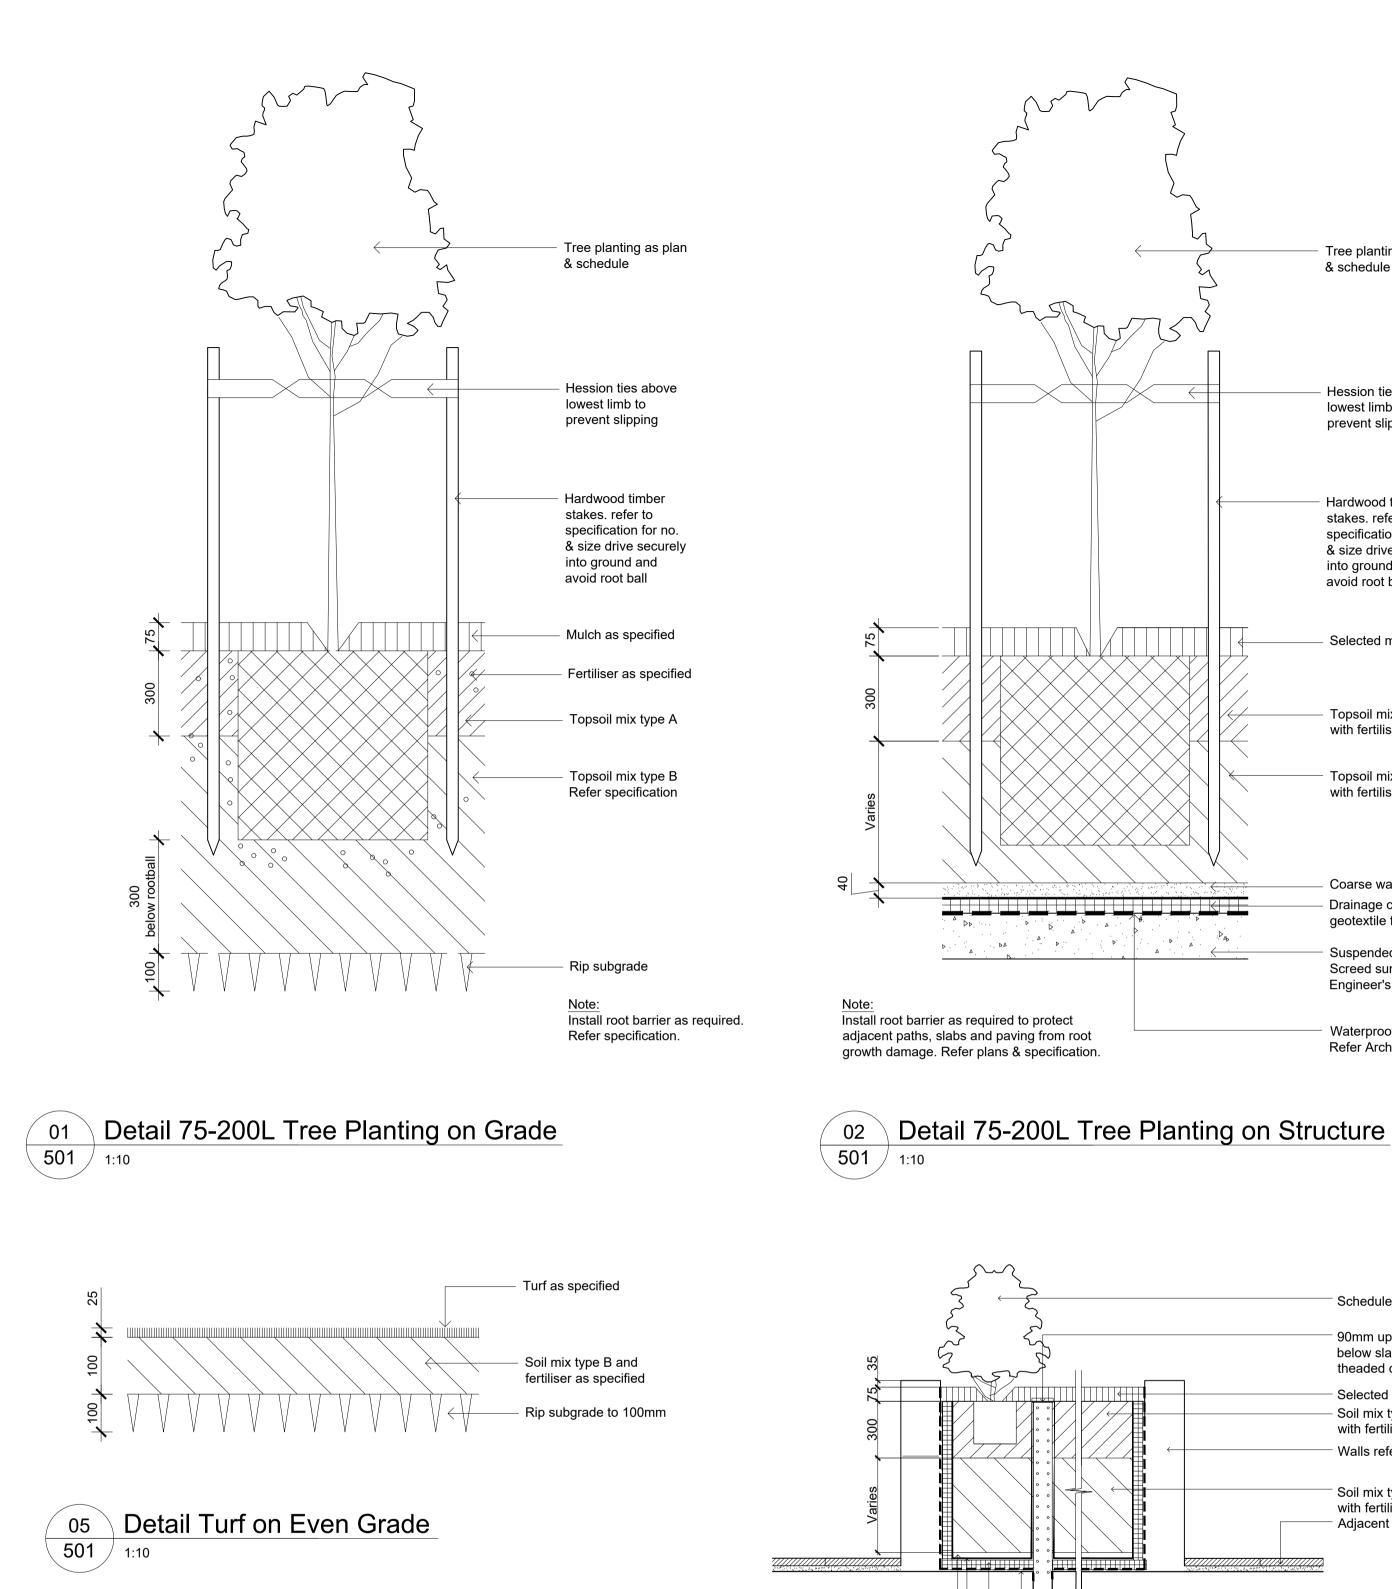

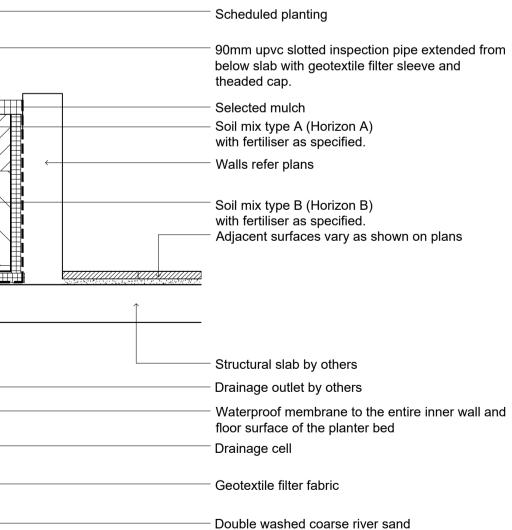

Detail Shrub Accent & Groundcover Planting on Structure <u>____</u> 501 1:10

Section - Typical Raised Planter Bed on Structure

06

501 1:20

Inspection riser pipe

Shrub, accent & groundcover planting refer plan & schedule

Mulch as specified

Fertiliser Refer specification

Soil mix type A

Soil mix type B

Rip subgrade to 100mm


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> Suspended concrete slab by others. Screed surface falls to Hydraulic Engineer's details.

Waterproof membrane. Refer Architects drawings



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Project: 13 - 19 Canberra Ave St leonards

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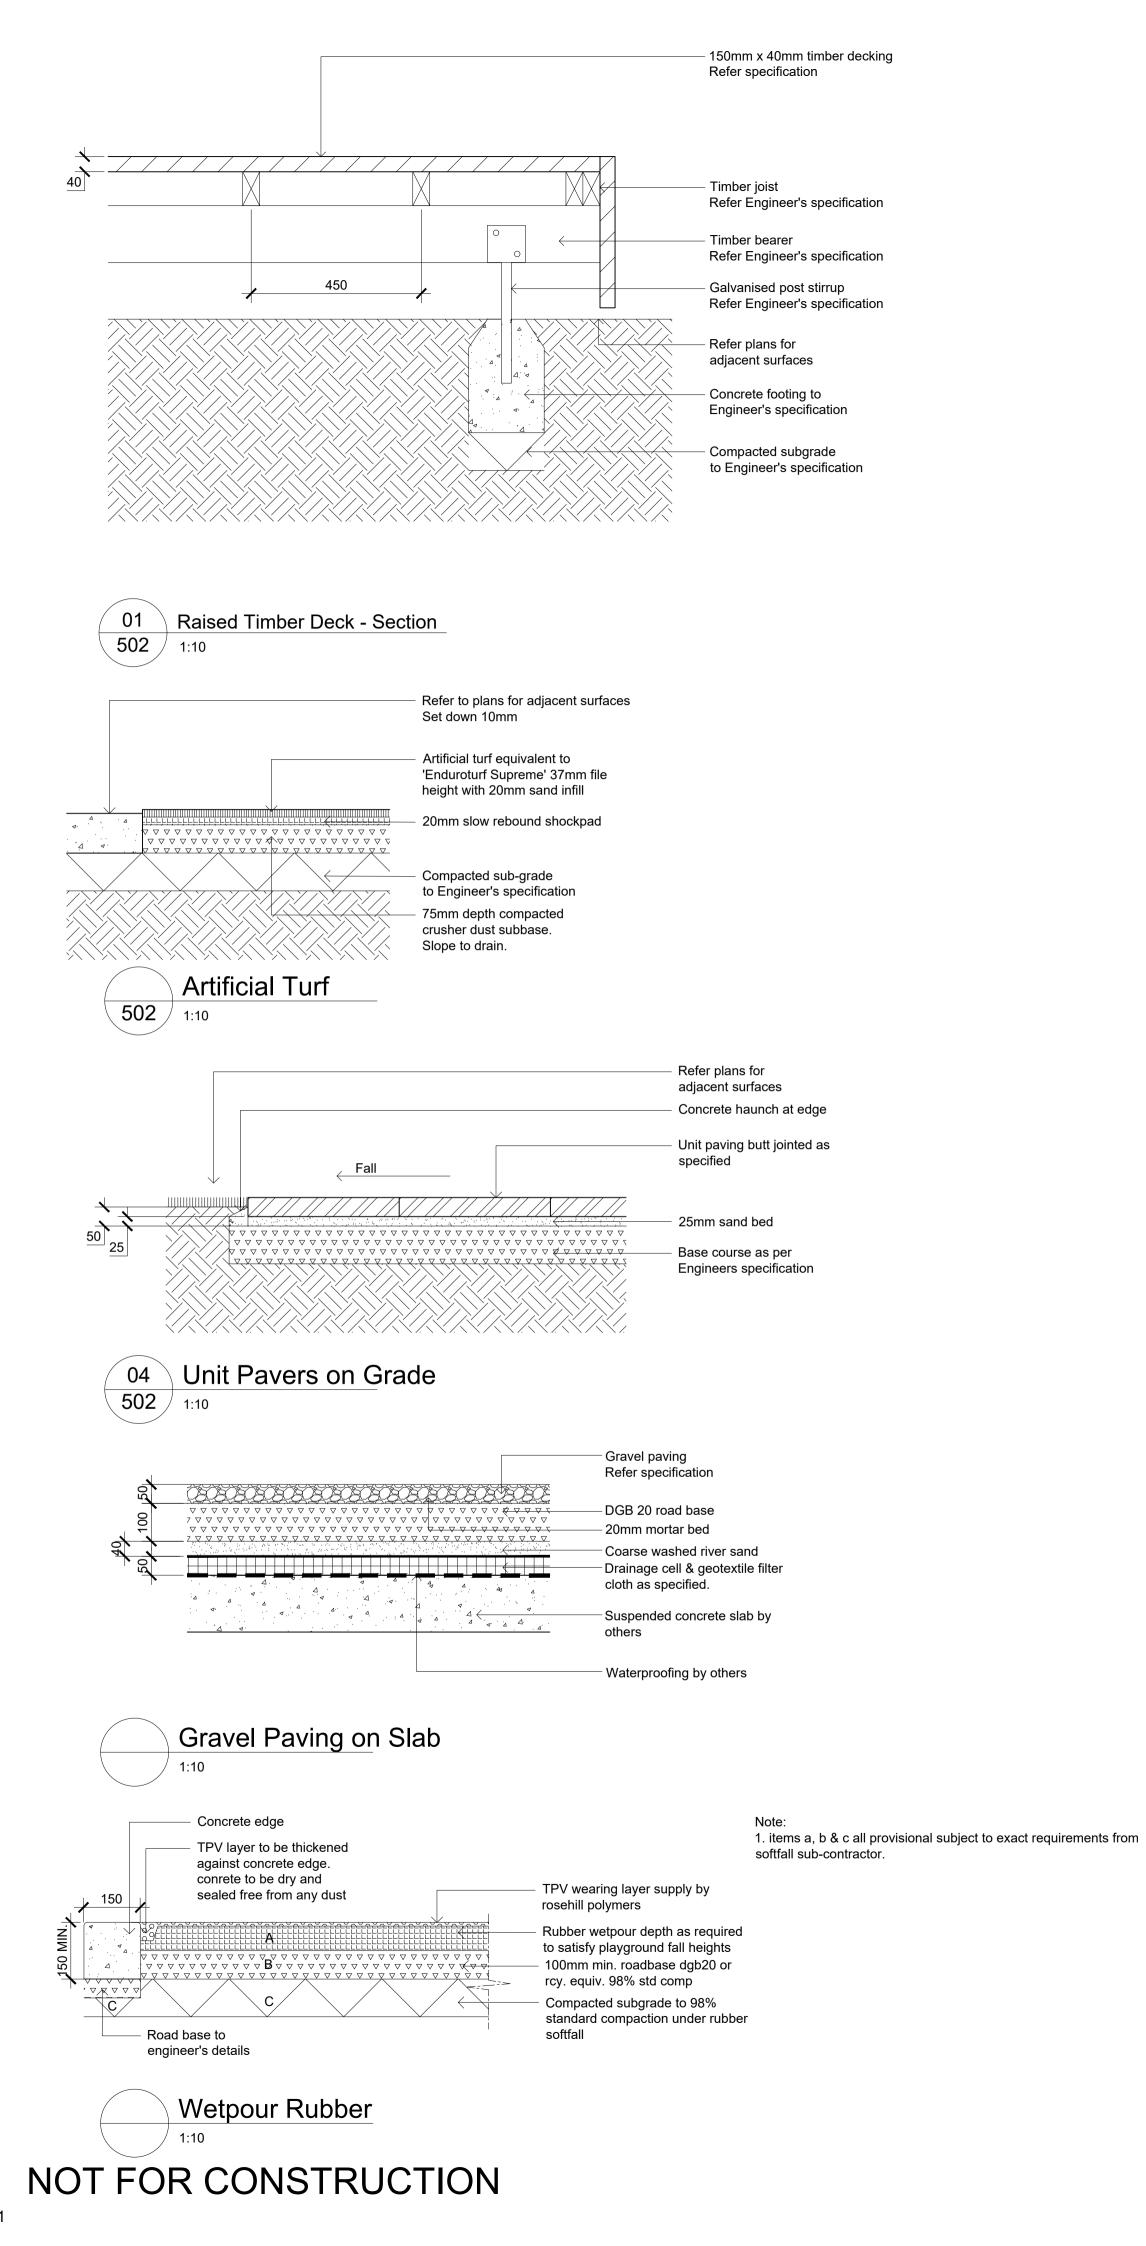
DEVELOPMENT APPLICATION

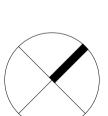Drawing Name: Landscape Details

Scale: As Shown Job Number:

SS21-4691-1

Drawing Number: Issue AH-501 A



SS21-4691-1

Scale: As Shown Job Number:

Drawing Number:

Landscape Details

Drawing Name:

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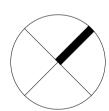
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Issue:

AH-502 A

Project: 13 - 19 Canberra Ave St leonards

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LEGEND

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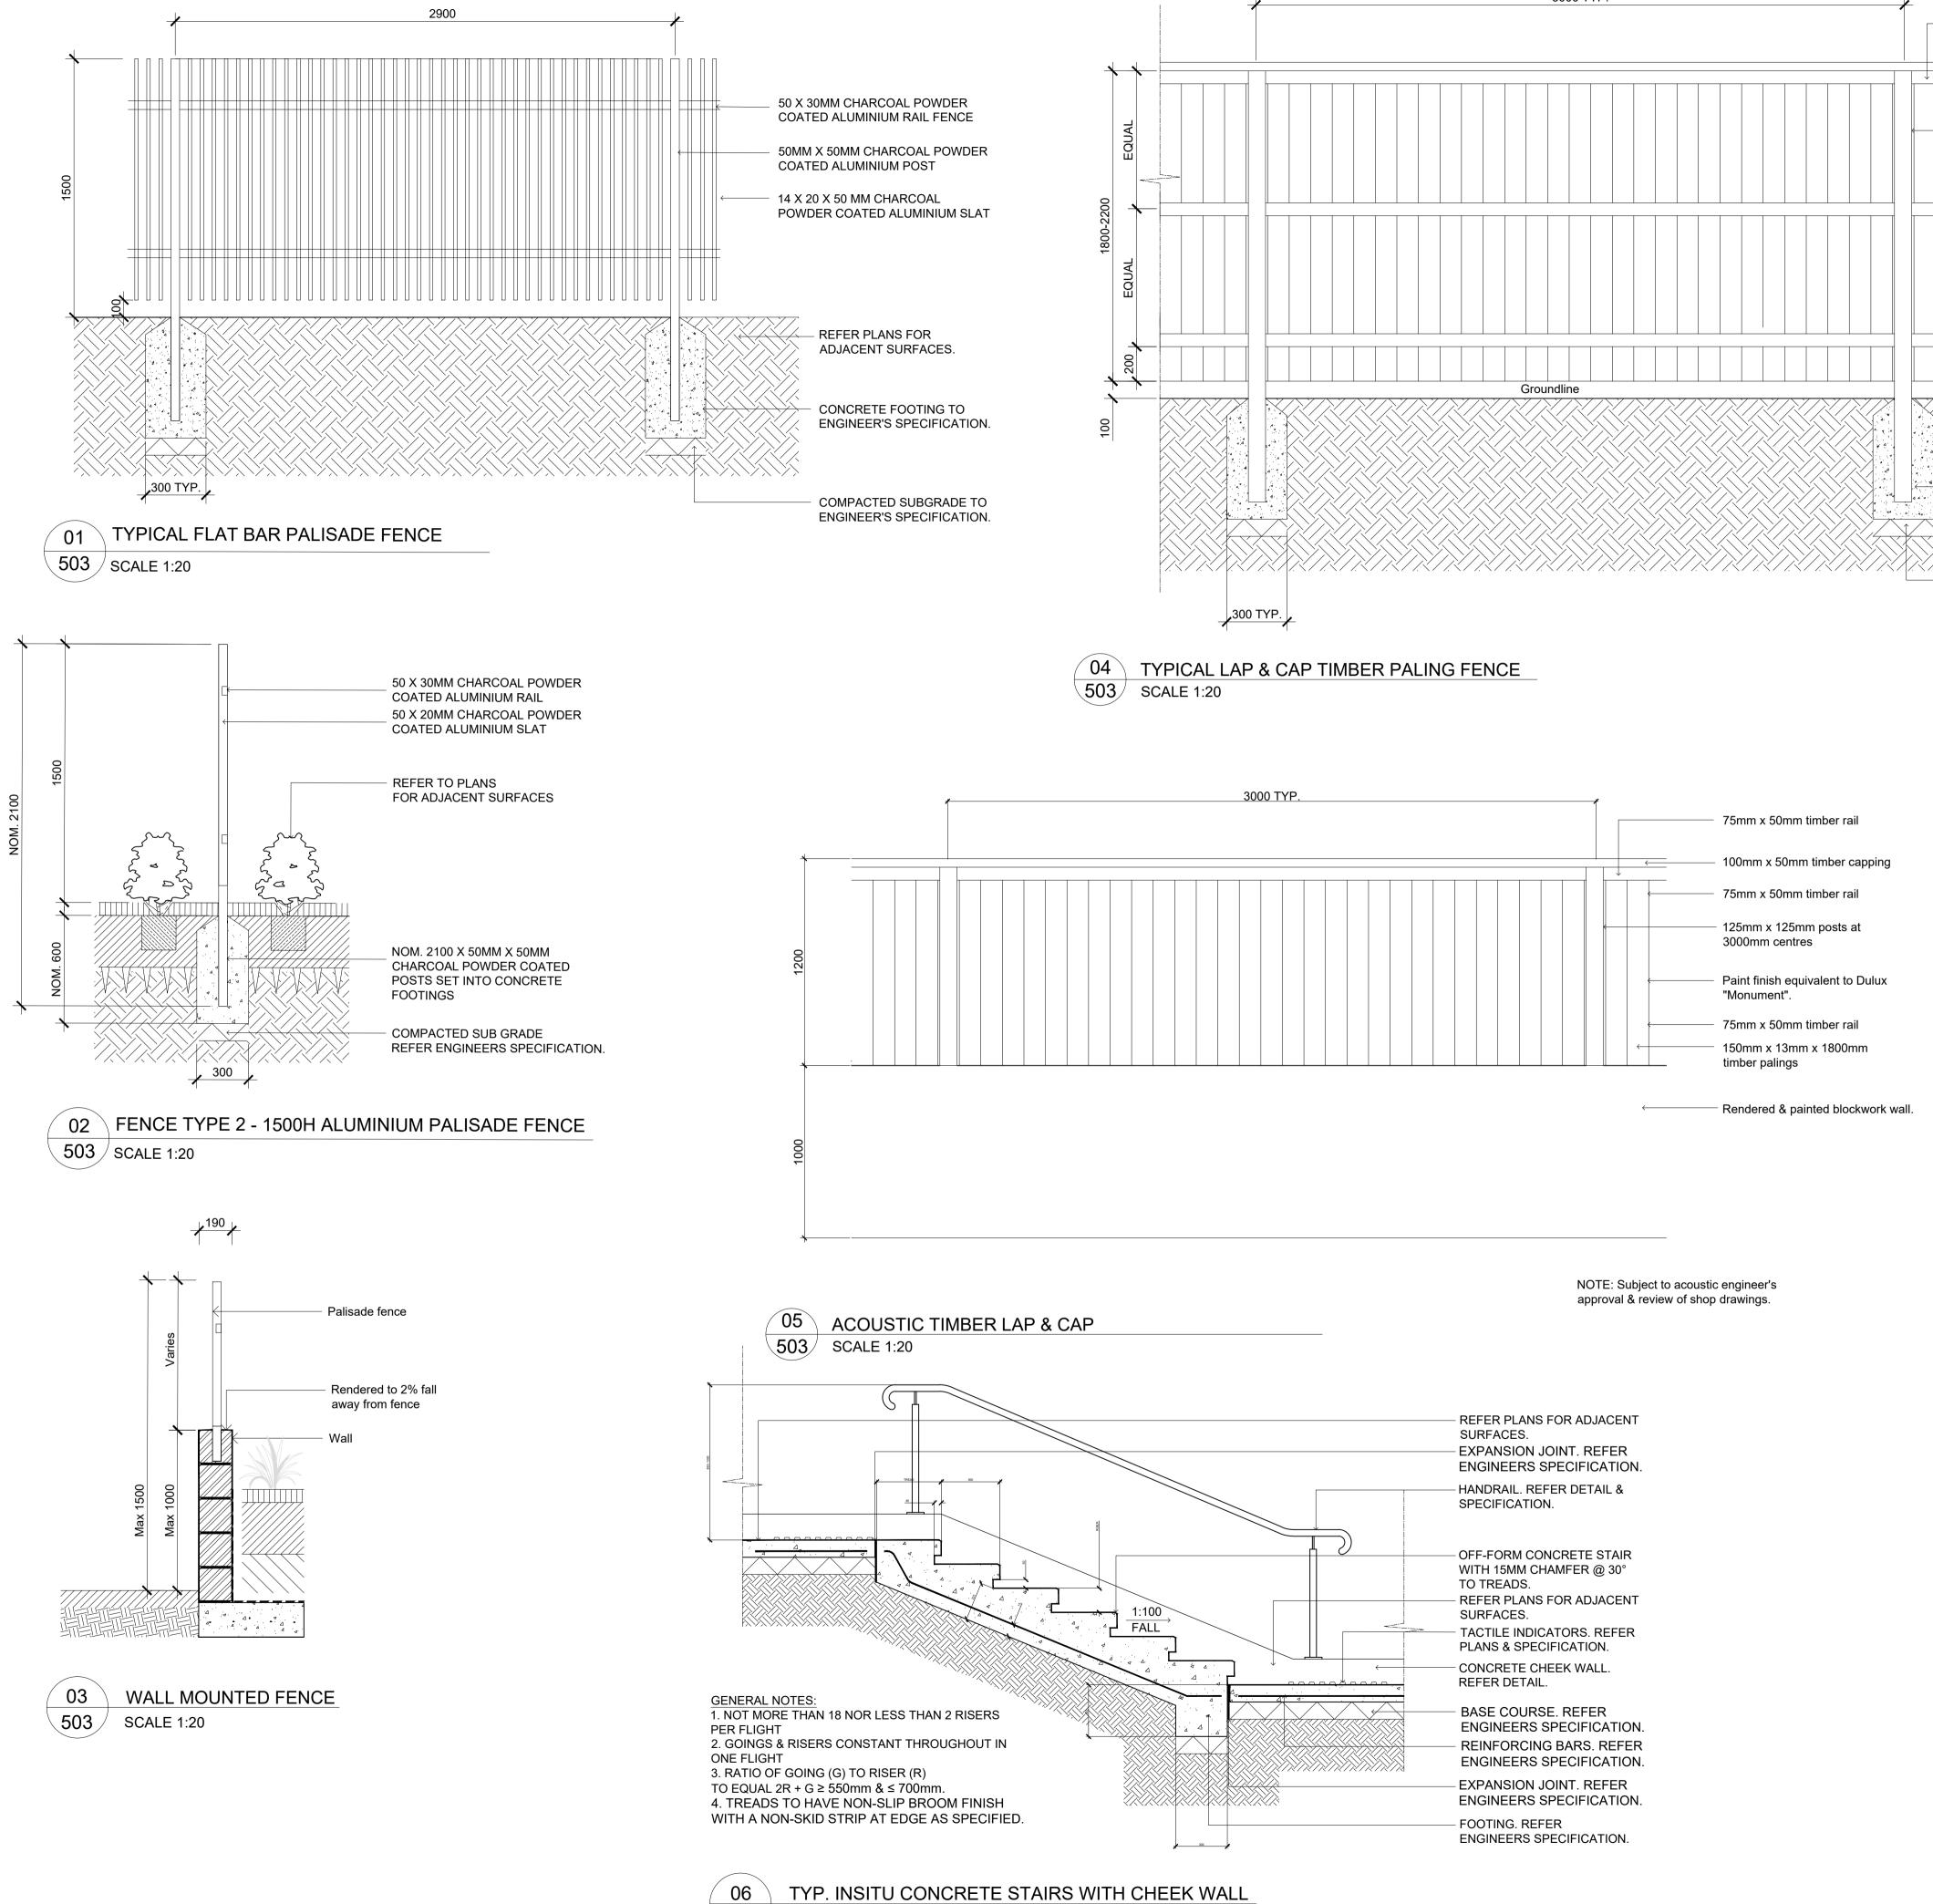
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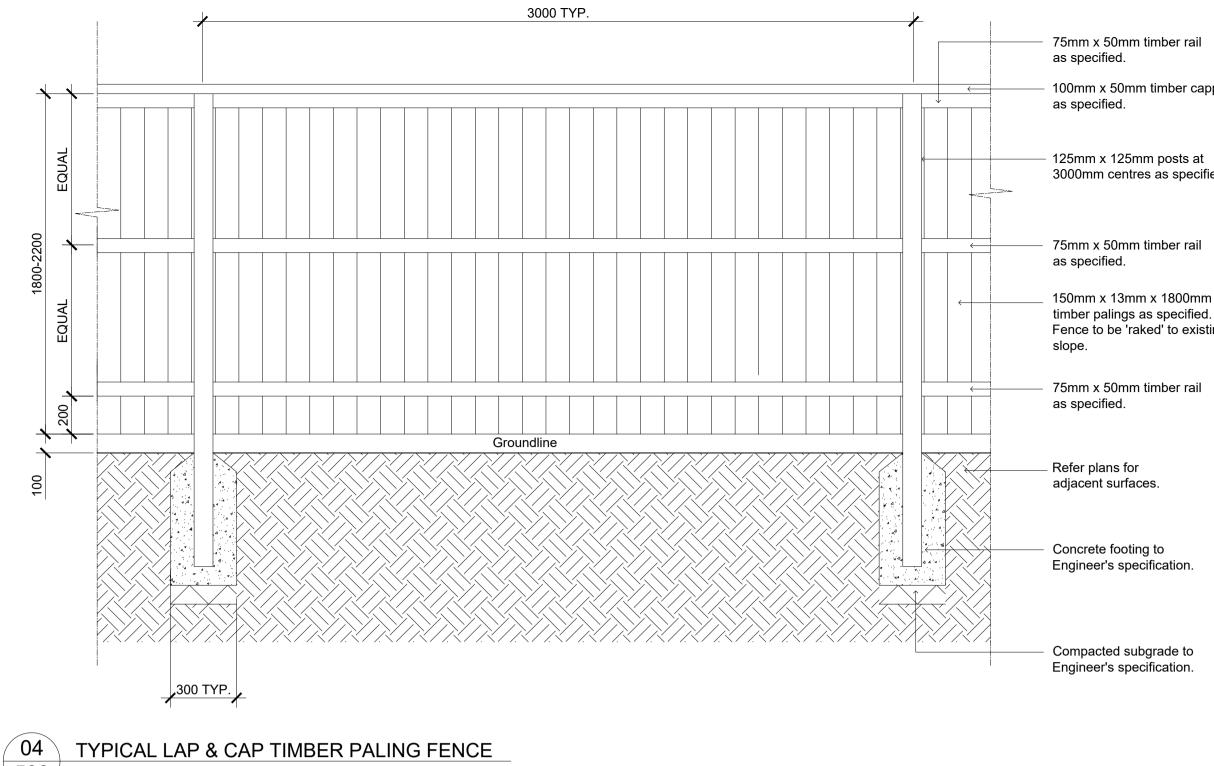
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TYP. INSITU CONCRETE STAIRS WITH CHEEK WALL

503 SCALE 1:20

100mm x 50mm timber capping

125mm x 125mm posts at 3000mm centres as specified.

75mm x 50mm timber rail

150mm x 13mm x 1800mm

Fence to be 'raked' to existing

75mm x 50mm timber rail

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LEGEND

Client: HYECORP

Property Group

Project:

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DEVELOPMENT APPLICATION

Drawing Name:

Landscape Details

Drawing Number

AH-503 A

SS21-4691-1

Scale: As Shown



CHILDCARE

+ PUBLIC +

PEDESTRIAN LINK 15190

SS21-4691

Scale: 1:150 @ A1 Job Number:

0 1 2 3 4 5m Drawing Number:

Drawing Name: Landscape Elevation West

REVISED DA

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SITE IMAGE

Project: 13 - 19 Canberra Ave St leonards

HYECORP Property Group



Issue Revision Description LEGEND

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party.

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Client:



Landscape Architects

Issue:

AH-601 A



RETAIL

LANDSCAPE

CANBERRA AVE

SS21-4691

Scale: 1:150 @ A1 Job Number: 0 1 2 3 4 5m Drawing Number: Issue: AH-602 A

Drawing Name: Landscape Elevation South

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SITE IMAGE

Project: 13 - 19 Canberra Ave St leonards

^{Client:} HYECORP Property Group



LEGEND

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SS21-4691

Scale: 1:150 @ A1 Job Number:

0 1 2 3 4 5m Drawing Number: AH-603 A

Drawing Name: Landscape Elevation

East

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Issue:

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Landscape Elevation North

Drawing Name:

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Issue

Project: 13 - 19 Canberra Ave St leonards

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LEGEND

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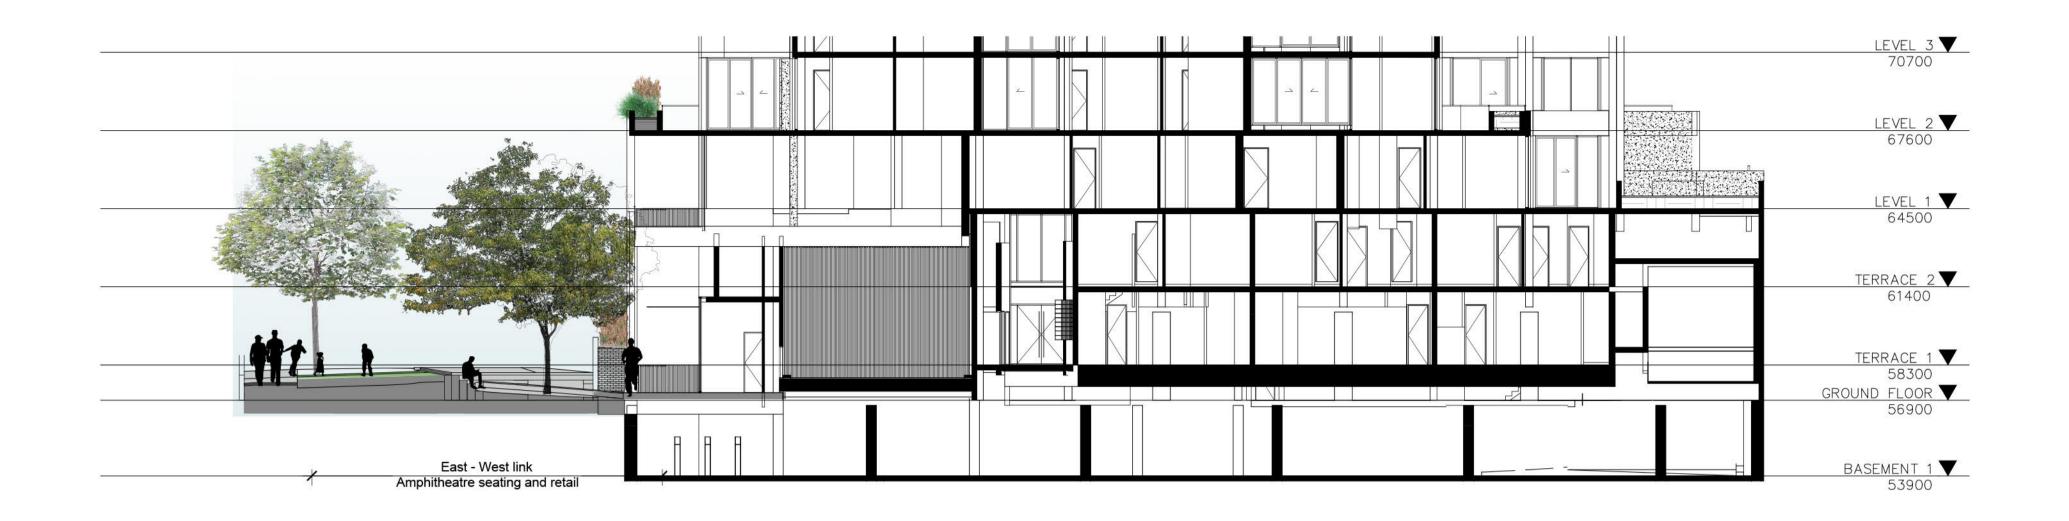
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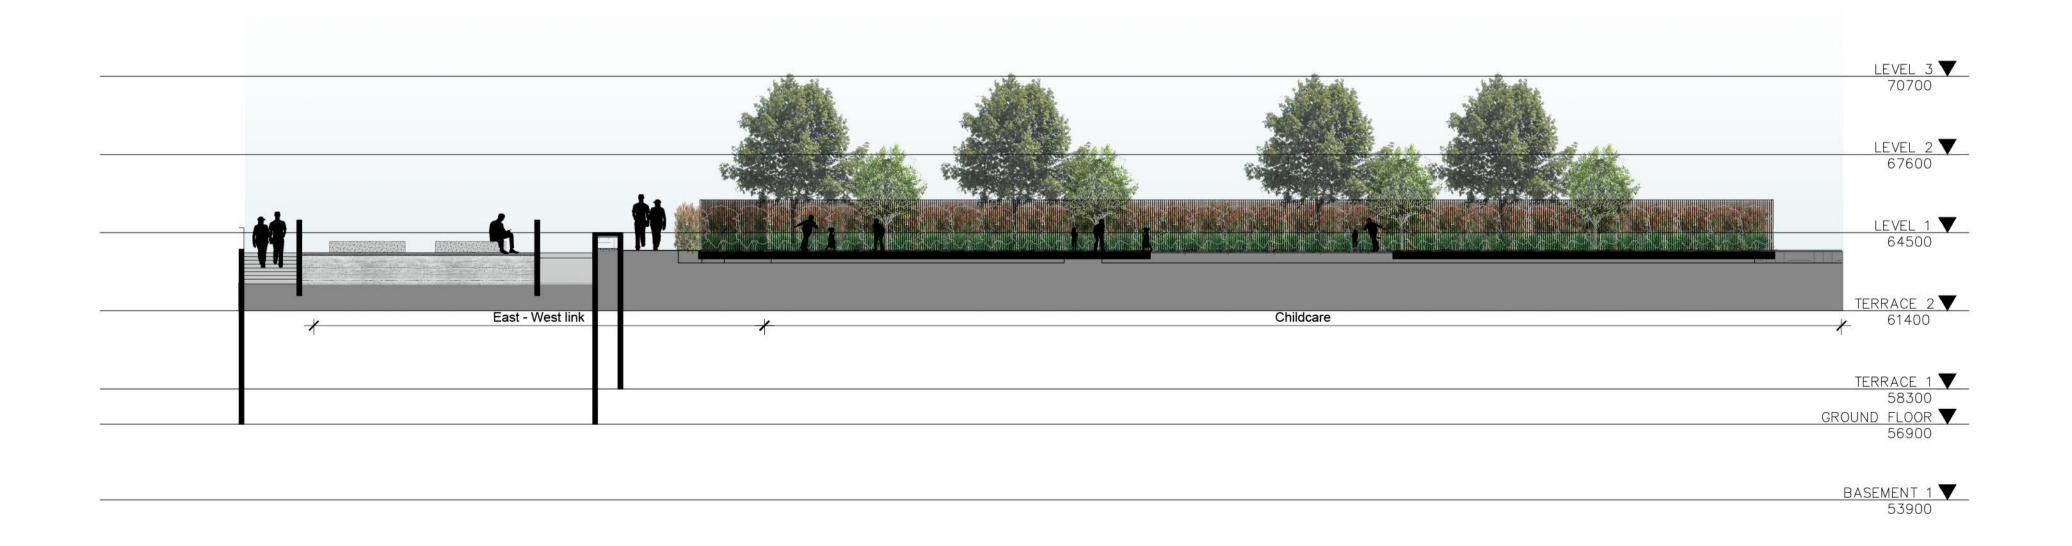
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SS21-4691

AH-605 D

Issue:

Retail / Terrace / Childcare Scale: 1:150 @ A1 Job Number:

0 1 2 3 4 5m Drawing Number:

Landscape Elevation

Drawing Name:

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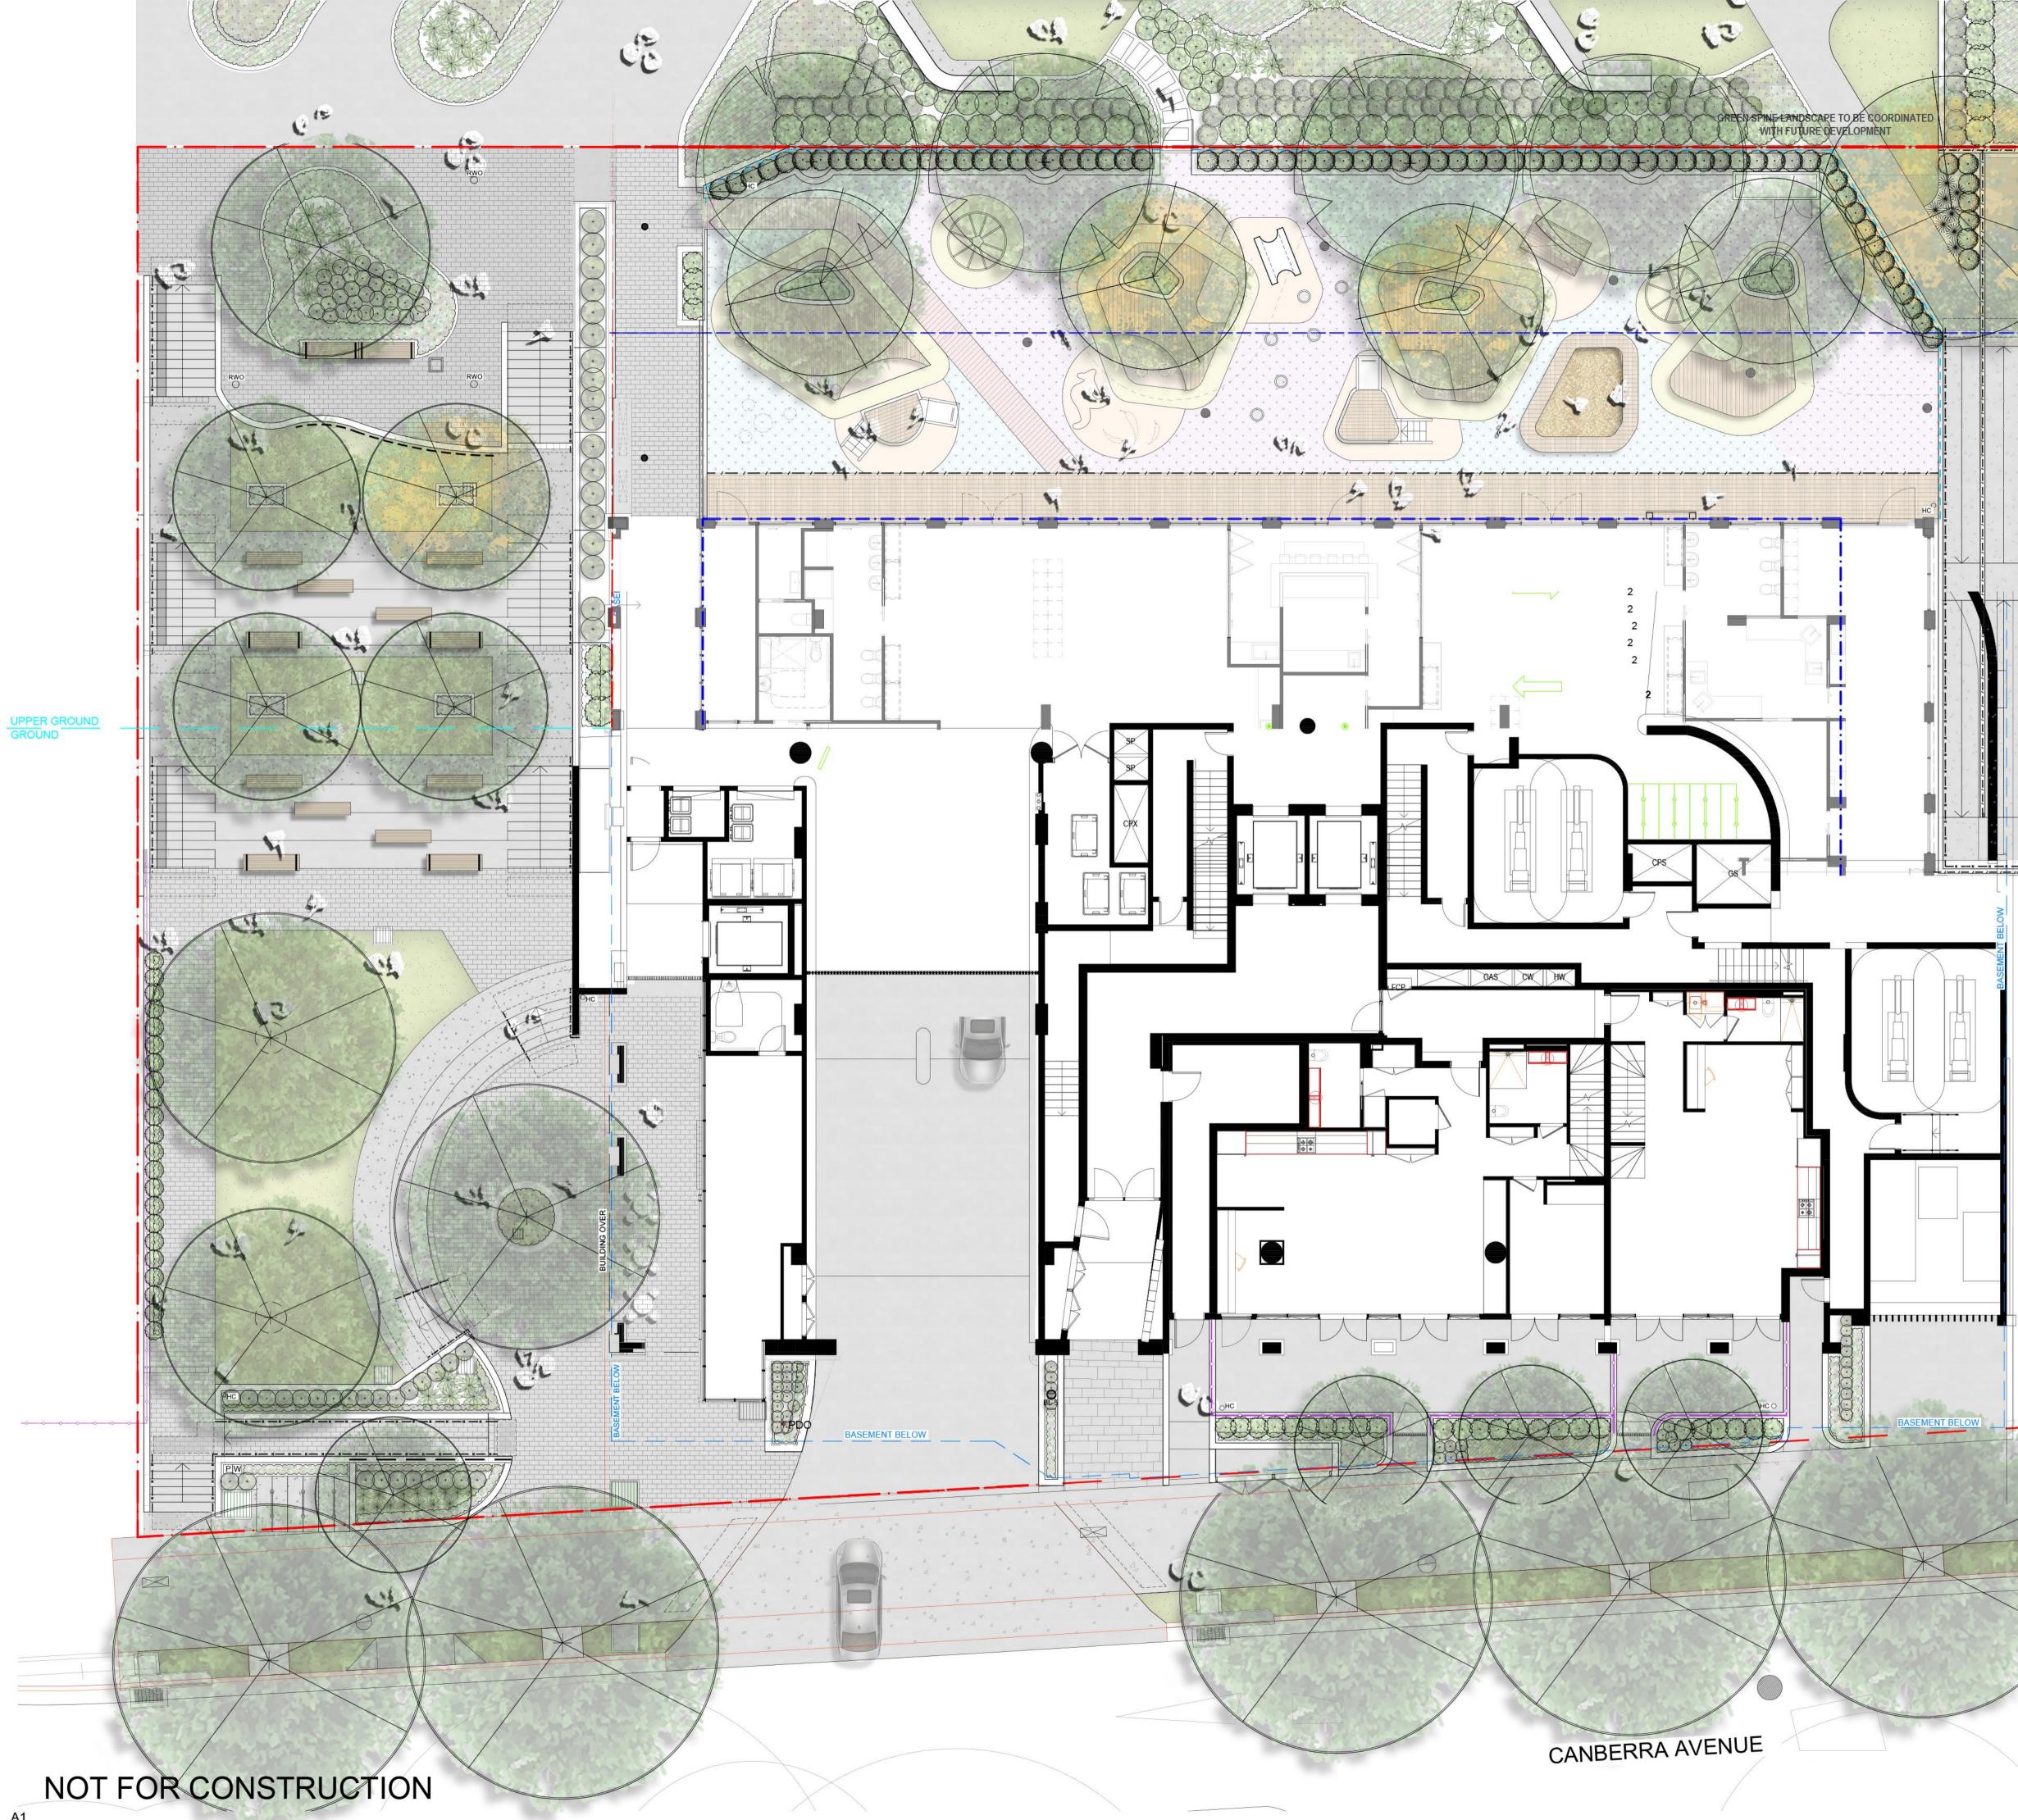
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Scale: 1:100 @ A1

Job Number:

2 3 4 5m Drawing Number: Issue AH-C100 A

Landscape ground, Upperground, and Level 1 Render

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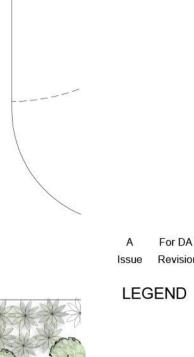
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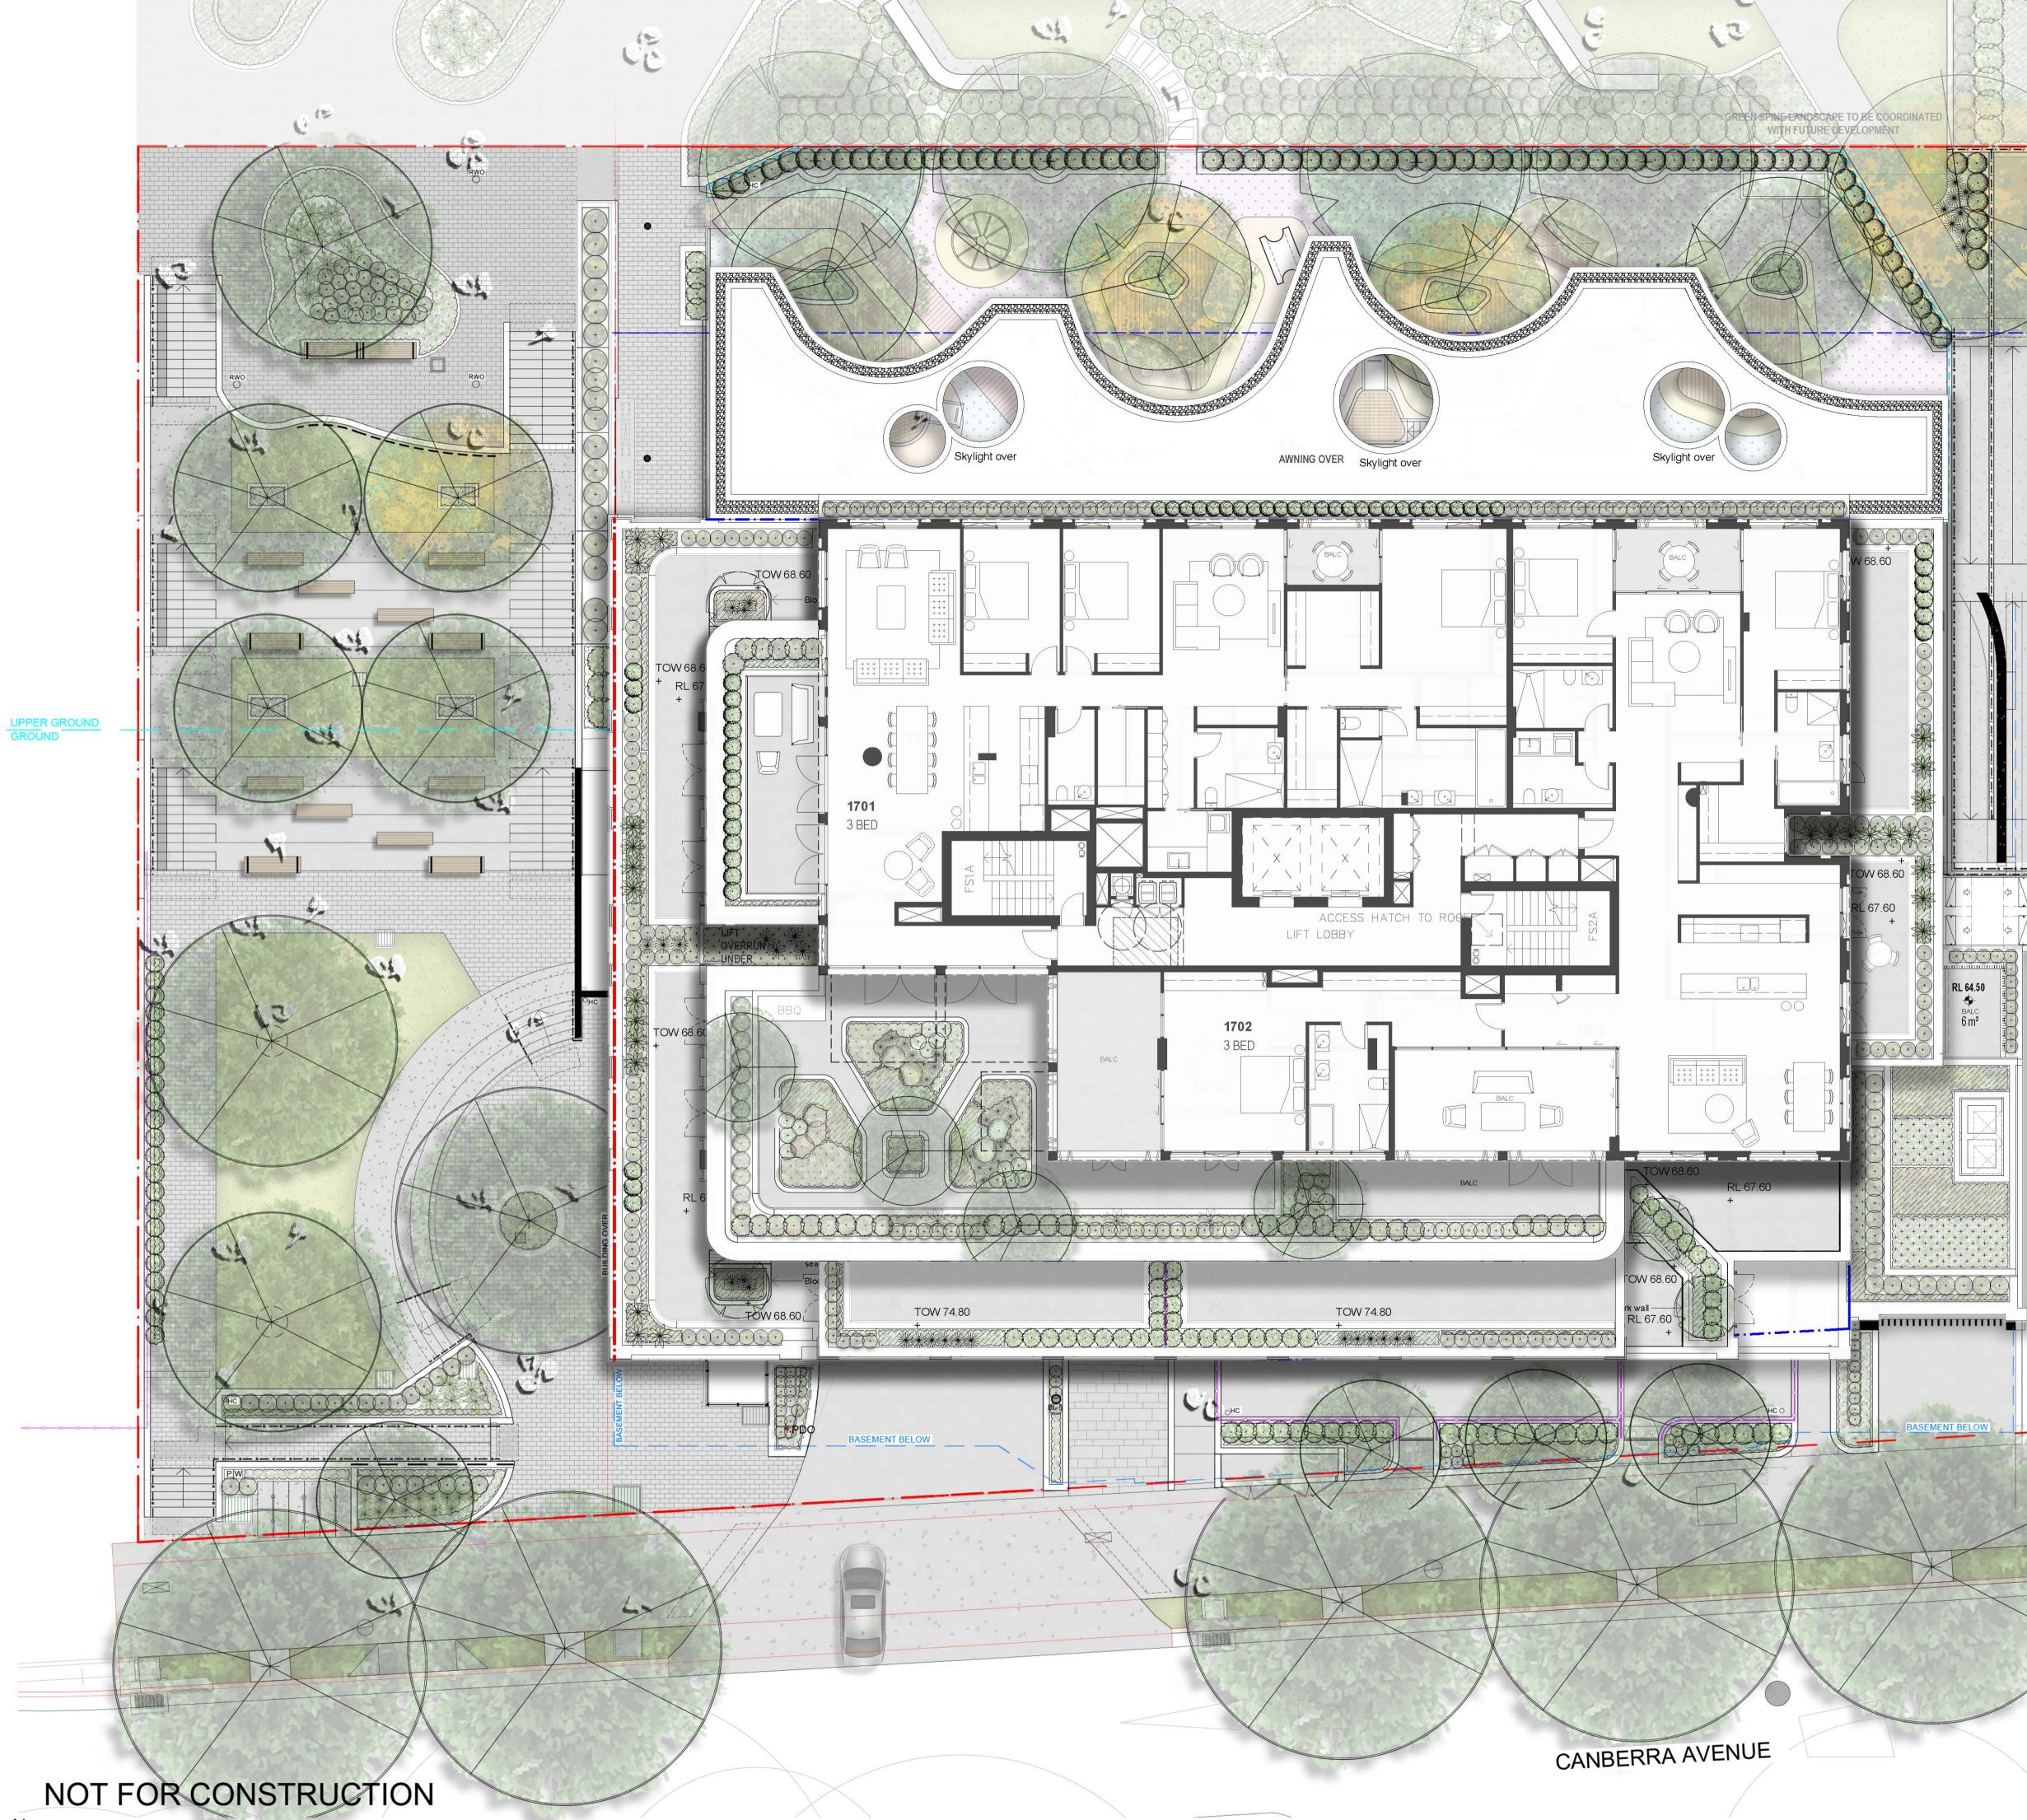
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Drawing Name: Landscape composite render

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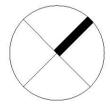
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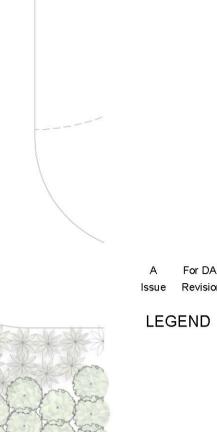
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13 - 19 Canberra Ave St leonards

Client: HYECORP Property Group

Project:





BALC 6 m²

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HYECORP PROPERTY GROUP

Heritage House, Suite 1, 256 Victoria Avenue, Chatswood, NSW 2067 Australia. **PO Box 779 Artarmon 1570.**

T (02) 9967 9910 **F** (02) 9967 9930

info@hyecorp.com.au www.hyecorp.com.au

Project Number:	2000192
Date:	09.04.2024
Client:	HYECORP PROPERTY GROUP

STORMWATER SERVICES DRAWINGS

LIST OF DRAWINGS

000	STORMWATER - COVER PAGE
001	STORMWATER - LEGEND & GENERAL NOTES
101	STORMWATER SERVICES - BASEMENT 4
102	STORMWATER SERVICES - BASEMENT 3
103	STORMWATER SERVICES - BASEMENT 2
104	STORMWATER SERVICES - BASEMENT 1
105	STORMWATER SERVICES - GROUND FLOOR
106	STORMWATER SERVICES - UPPER GROUND FLOOR
107	STORMWATER SERVICES - LEVEL 1
201	EROSION AND SEDIMENTATION - CONTROL PLAN
202	EROSION & SEDIMENTATION - CONTROL DETAIL
203	STORMWATER SERVICES - MUSIC MODEL
301	STORMWATER SERVICES - TYPICAL DETAILS
302	STORMWATER SERVICES - OSD DETAILS
303	STORMWATER SERVICES - PUMPOUT PIT DETAILS
304	STORMWATER SERVICES - WATER TREATMENT SYSTEM SCHEMATIC
305	STORMWATER SERVICES - KIP STANDARD DETAIL
401	DRAINAGE DETAILS



13-19 CANBERRA AVE, ST LEONARDS NSW 2065 STORMWATER SERVICES - DA SUBMISSION 2024

|--|

,	
₽/® PDO	- PLANTER DRAIN OUTLET

■/● RWO - RAINWATER OUTLET

- GRATED INLET PIT

 \ge - PUMP CONTROL PANEL

- GRATED DRAIN

- RHS OVERFLOW PIPE

RISER PIPE LEGEND

— - FLOW DIRECTION - SERVICE - SERVICE SIZE

PIPE SYSTEM LEGEND

- STORMWATER DRAIN (CAST-IN SLAB)
- STORMWATER DRAIN (UNDER SLAB)
- CHARGED LINE
- PRESSURED LINE
- AG LINE IN OVER-EXCAVATED AREA
- RAIN WATER TANK OVERFLOW

ABBREVIATIONS

- CHARGED LINE

- DIAMETER DIA
- DP - DOWN PIPE - FLOOR LEVEL
- FLOOR WASTE FW
- FFL - FINISHED FLOOR LEVEL
- FDO FLOOR DRAIN OUTLET - GRATED SURFACE INLET PIT
- GSIP GL - GROUND LEVEL
- HIGH LEVEL HL
- INSPECTION CHAMBER
- INVERT LEVEL - INSPECTION OPENING TO SURFACE
- IOS MH - MANHOLE
- O/F - OVERFLOW
- ON-SITE STORMWATER DETENTION OSD
- PLANT DRAIN OUTLET PDO
- RECTANGULAR HOLLOW SECTION RHS - RAINWATER OUTLET RWO
- RELATIVE LEVEL RI
- RW - RAIN WATER
- STORM WATER STW
- SURFACE/STORM WATER PIT SP

GENERAL NOTES

- ALL WORKS SHALL BE CONSTRUCTED IN ACCORDANCE WITH THE TECHNICAL SPECIFICATION. THE CONTRACTOR SHALL PREPARE A DILAPIDATION REPORT FOR THE EXISTING INFRASTRUCTURE WITHIN THE ROAD RESERVE, INCLUDING BUT NOT LIMITED TO KERBS, GUTTERS, FOOTPATHS, VEHICULAR CROSSINGS, STREET SIGNS, SERVICE FITTING COVERS, ETC.
- THE CONTRACTOR SHALL REVIEW, BE AWARE AND AT ALL TIMES COMPLY WITH THE SPECIFIC REQUIREMENTS FOR THIS DEVELOPMENT AS SET OUT IN THE DEVELOPMENT APPROVAL FOR THE PROJECT.
- ANY CHANGES MADE BY THE CONTRACTOR TO ANY LEVEL, DIMENSION, LOCATION, POSITION, ALIGNMENT ETC, OF ANY OF THE WORKS SHOWN ON THE DRAWINGS WITHOUT THE WRITTEN CONSENT OF TORINEX CONSULTING ENGINEERS AND OR THE PRINCIPAL CERTIFYING AUTHORITY IS DONE SO AT THE CONTRACTOR'S OWN RISK.
- THE CONTRACTOR SHALL ALLOW TO LIAISE WITH AND PROVIDE SUFFICIENT NOTICE TO COUNCIL AND TO THE PRINCIPAL CERTIFYING AUTHORITY TO ENSURE THAT ALL WORKS ARE INSPECTED TO ENABLE COMPLIANCE CERTIFICATES TO BE ISSUED THROUGHOUT THE CONSTRUCTION PERIOD. THE CONSTRUCTOR SHALL LIAISE WITH THE PRINCIPAL CERTIFYING AUTHORITY PRIOR TO ANY CONSTRUCTION WORKS COMMENCING AND PREPARE AN INSPECTION AND TEST PLAN WITH A MUTUALLY AGREED WITNESS AND HOLD POINTS FOR THE CONSTRUCTION WORKS.
- IF THE PRINCIPAL CERTIFYING AUTHORITY IS NOT COUNCIL. THEN THE CONTRACTOR MUST CONTACT COUNCIL'S WORKS DIVISION TO ENABLE THEIR INSPECTION OF ALL WORKS (INCLUDING EROSION AND SEDIMENT CONTROL MEASURES) WITHIN THE ROAD RESERVE AREA.
- THE CONTRACTOR SHALL BE RESPONSIBLE FOR THE MAINTENANCE OF ALL ACCESS TO THE SITE. THE ACCESS SHALL BE ALL WEATHER SAFE ACCESS TO THE CONTRACTOR'S SITE FACILITIES AT ALL TIMES FOR THE DURATION OF THE CONTRACT. A TEMPORARY HOARDING OR FENCE OF MINIMUM 1.5m HIGH IS TO BE PROVIDED AROUND THE SITE TO PROTECT THE PUBLIC
- PRIOR TO COMMENCEMENT OF WORKS. HOARDING OR FENCES ARE TO BE STRUCTURALLY ADEQUATE. THE CONTRACTOR SHALL OBTAIN AN APPROVAL FROM COUNCIL PRIOR TO ERECTING THE HOARDING OR FENCE.
- ALL NEW WORKS SHALL MAKE A SMOOTH CONNECTION WITH ANY FORMATIONS, STRUCTURES, ETC.

CLIENT

- ALL ALTERATIONS AND/OR ADDITIONS TO EXISTING WORK, THE CONTRACTOR SHALL VERIFY THE DIMENSIONS OF THE EXISTING WORK BEFORE PROCEEDING AND NOTIFY THE SUPERINTENDENT OF DISCREPANCIES. THE CONTRACTOR SHALL USE MANUFACTURED ITEMS IN THE WORK ONLY IN ACCORDANCE WITH THE CURRENT PUBLISHED 10.
- RECOMMENDATIONS. THE WORKS SHALL BE CONSTRUCTED IN SUCH A MANNER THAT THERE IS MINIMUM DISTURBANCE TO EXISTING TREES AND 11.
- VEGETATION.

HYECORP

ARCHITECT

HYE

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ENGINEERED BY:

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PROPOSED DEVELOPMENT

12. THE PUBLIC FOOTWAY AND ROADWAY FRONTING THE SITE SHALL BE MAINTAINED IN A SAFE AND UNOBSTRUCTED MANNER AT ALL TIMES DURING THE CONSTRUCTION WORKS. 13. THE CONTRACTOR SHALL BE RESPONSIBLE FOR REPAIRING TO THE SATISFACTION OF THE ASSET OWNER, ANY DAMAGE CAUSED TO ANY

EXISTING INFRASTRUCTURE WITHIN THE ROAD RESERVE, INCLUDING BUT NOT LIMITED TO KERBS, GUTTERS, FOOTPATHS, VEHICULAR CROSSINGS, STREET SIGNS, SERVICE FITTING COVERS, ETC.

14. THE SITE SHALL BE KEPT IN A TIDY CONDITION AT ALL TIMES. LITTER RUBBISH AND BUILDING RUBBLE SHALL BE PLACED IN CONTAINERS OR BINS AND REGULARLY REMOVED FROM SITE AS REQUIRED

CONCRETE NOTES

1. ALL WORKMANSHIP, MATERIALS AND TESTING FOR CONCRETE WORKS SHALL COMPLY WITH THE REQUIREMENTS OF AS 3600. ALL WORKMANSHIP AND MATERIALS FOR FORMWORK SHALL COMPLY WITH THE REQUIREMENTS OF AS3610. THE CONSTRUCTOR SHALL ENSURE THAT ALL REINFORCEMENT IS SECURELY TIED AND SUPPORTED IN IT'S CORRECT POSITION AND WITHIN ACCEPT TABLE TOLERANCES SO AS NOT TO BE DISPLACED DURING CONCRETE POURING.

4. PROVIDE CONCRETE WITH A MAXIMUM SLUMP OF 80. TYPE SL CEMENT, MAXIMUM AGGREGATE SIZE 20. APPROVED ADMIXTURES AND STRENGTH GRADE AS FOLLOWS:

ELEMENT	EXPOSURE CLASSIFICATION	STRENGTH (MPa)
PAVEMENT	A2	32
KERB (ALL TYPES)	A2	25
FOOTPATH	A2	25
RETAINING WALL FOOTING	G A1/B1	20

PROJECT CONTROL TESTING SHALL BE CARRIED OUT IN ACCORDANCE WITH AS3600

5. PROVIDE LAPS ONLY AT LOCATIONS SHOWN AND OF DIMENSIONS AS FOLLOWS UNLESS DETAILED OTHERWISE OR APPROVED IN WRITING BY THE ENGINEER.

BAR SIZE	LAP
N12	500
N16	750
N20	1000

OVERLAP FIRST AND SECOND CROSS WIRES OF EACH STREET OF FABRIC BY 25 AT LAPS. DO NOT WELD REINFORCEMENT UNLESS SHOWN OR APPROVED BY THE ENGINEER. 8. TIE ALL UNSUPPORTED BARS TO N12.350.B OR N12.450.T CROSSRODS, LAPPED 450 WHERE REQUIRED. 9. PROP, CURE AND STRIP IN ACCORDANCE WITH AS3600, AS3610 AND THE SPECIFICATION. 10. CONCRETE SAWN JOINTS MUST BE DONE WITH 8 HOURS OF CONCRETE POUR.

11. JOINT SEALANT MUST BE SILICONE SEALANT FOR CASTING IN -SITU AS SPECIFIED ON DRAWINGS.

SETTING OUT NOTES

1. THE CONTRACTOR SHALL USE A SUITABLY QUALIFIED SURVEYOR TO SET OUT ALL WORKS. THE SURVEYOR SHALL ISSUE A CERTIFICATE TO THE PRINCIPAL CERTIFYING AUTHORITY CERTIFYING THAT THE WORKS HAVE BEEN SET OUT IN ACCORDANCE WITH THE APPROVED DRAWINGS PRIOR TO THE WORKS BEING CONSTRUCTED.

SAFETY IN DESIGN

 THERE ARE INHERENT RISKS WITH CONSTRUCTING, MAINTAINING, OPERATING, DEMOLISHING, DISMANTLING AND DISPOSING FOR THE DESIGN THAT ARE TYPICAL OF SIMILAR DESIGNS. AS FAR AS IS REASONABLY PRACTICAL RISKS HAVE BEEN ELIMINATED OR MINIMIZED THROUGH THE DESIGN PROCESS. HAZARD CONTROLS MUST STILL BE IMPLEMENTED BY THE CONTRACTOR, OWNER OR OPERATOR TO ENSURE THE SAFETY OF WORKERS.

EXISTING IN-GROUND SERVICES

REFER TO SERVICE LOCATION PLANS, PROVIDED AS A SEPARATE DOCUMENT (i.e. NOT PART OF THIS DRAWING SET).

ENVIRONMENTAL CONTROL NOTES

EROSION AND SEDIMENT CONTROL 1. THE CONTRACTOR SHALL BE SOLELY RESPONSIBLE FOR THE CONTROL OF EROSION AND SEDIMENTATION TO THE SATISFACTION OF COUNCIL, THE RELEVANT STATE AUTHORITIES AND THE PRINCIPAL CERTIFYING AUTHORITY. TO THIS END, THE EROSION AND SEDIMENTATION CONTROLS SHOWN ON THE DRAWINGS SHALL ONLY BE USED AS A GUIDE BY THE CONTRACTOR AND SHALL REPRESENT THE MINIMUM REQUIREMENT ONLY.

2. NO CONSTRUCTION WORKS ARE TO COMMENCE ON SITE UNTIL ALL EROSION AND SEDIMENT CONTROL MEASURES ARE IN PLACE AND HAVE BEEN INSPECTED AND APPROVED BY THE COUNCIL AND/OR PRINCIPAL CERTIFYING AUTHORITY

3. ALL EROSION AND SEDIMENT CONTROL MEASURES SHALL BE REGULARLY INSPECTED, IN PARTICULAR AFTER STORMS, AND REPAIRED OR MAINTAINED AS REQUIRED TO ENSURE THE MEASURES CORRECT AND EFFICIENT FUNCTION THROUGHOUT THE DURATION OF THE WORKS UNTIL SUCH TIME AS THE COUNCIL AND/ OR PRINCIPAL CERTIFYING AUTHORITY AUTHORIZES THE REMOVAL OF SUCH MEASURES. 4. ALL STOCKPILES SHALL BE CLEAR OF ALL TREES AND DRAINAGE LINES (INCLUDING OVERLAND FLOW PATHS) AND PROTECTED FROM EROSION

5. IN THE CASE OF THE TEMPORARY CONSTRUCTION EXIT, THE CONTRACTOR SHALL UNDERTAKE WEEKLY SURFACE CLEANING BY DRAG BROOM OR EQUIVALENT, TO REMOVE ALL BUILD UP OF FOREIGN MATERIAL TO THE SATISFACTION OF THE SUPERINTENDENT. TRAFFIC CONTROLS

1. THE CONTRACTOR SHALL BE SOLELY RESPONSIBLE FOR THE CONTROL OF TRAFFICS INCLUDING VEHICLES AND PEDESTRIANS TO THE SATISFACTION OF COUNCIL, THE RELEVANT STATE AUTHORITIES AND THE PRINCIPAL CERTIFYING AUTHORITY.

2. THE CONTRACTOR IS TO PREPARE A TRAFFIC MANAGEMENT PLAN TO THE REQUIREMENTS OF THE RMS - TRAFFIC CONTROL AT WORK SITE, AS1742 - AUSTRALIAN STANDARD MANUAL OF UNIFORM TRAFFIC CONTROL DEVICES AND LOCAL COUNCIL STANDARDS OTHER ENVIRONMENTAL CONTROLS

1. OTHER ENVIRONMENTAL CONTROLS LIKE NOISE, DUST, VIBRATION, FLORA & FAUNA, FIRE, HAZMAT, AND CONTAMINATIONS MUST BE CONTROLLED TO THE REQUIREMENT OF THE COUNCIL AND THE RELEVANT STATE AUTHORITIES.

STORMWATER NOTES

1. STORMWATER DESIGN CRITERIA

- MINOR STORM ARI: 20 YEARS MAJOR STORM ARI:
- 100 YEARS IFD DATA LOCALITY: ST LEONARDS/LANE COVE COUNCIL
- U.N.O. PIPES DN300 AND SMALLER SHALL BE GRADE SH (SEWER GRADE) uPVC WITH RUBBER RING JOINTS.
- EQUIVALENT STRENGTH FIBRE REINFORCED CONCRETE PIPES MAY BE USED UP TO DN450.
- REQUIREMENT OF AS 2439.
- ALL PITS/TANKS DEEPER THAN 1200mm TO HAVE STEP IRONS.
- ALL PITS SHOULD HAVE COVERS/LIDS/GRATES APPROPRIATE TO VEHICLE LOADING.
- BALCONY OVERFLOW SPOUTS TO BE AT LEAST 2.4m APART.
- 12. GRATES 900 DEEP OR GREATER OR 600x600 OR GREATER TO BE LOCKABLE AND HINGED.
- 13. PITS TO HAVE APPROPRIATE BENCHING OR AS PER COUNCIL REQUIREMENTS. COMPLY WITH THE REQUIREMENTS OF AS 1214 OR AS 1650, AS APPROPRIATE.
- 15. GEOFABRIC FILTER SHALL BE PERMEABLE, NON -WOVEN FABRIC MANUFACTURED FROM A POLYMER SUCH AS POLYPROPYLENE OR
- POLYESTER OF MASS NOT LESS THAN 135g/m² 16. THE MINIMUM TRENCH WIDTHS SHALL BE AS FOLLOWS:
- CONCRETE AND FRC PIPES: EXTERNAL PIPE DIAMETER PLUS 400 mm.
- uPVC PIPE: SUBSOIL PIPE:

SUBSOIL DRAINS:

- 250 mm.
- 17. ALL PIPES SHALL BE PLACED CENTRALLY WITHIN THE TRENCH WITH EQUAL CLEARANCE EACH SIDE. PIPE BEDDING MATERIAL SHALL BE CLEAN COARSE RIVER SAND WITH DEPTH AS FOLLOWS: CONCRETE AND FRC PIPES: 100 mm (175 mm IN ROCK)
- uPVC PIPE:
- 75 mm (100 mm IN ROCK) 50 mm
- LEAST 100% STANDARD MAXIMUM DRY DENSITY
- 22. UNLESS OTHERWISE DETAILED OR PERMITTED. THE MINIMUM GRADE OF ALL PIPE WORKS SHALL BE 1.0%.

AS SIEVE SIZE (mm)	SAND	7mm ROCK
9.5	100	100
6.7		75-100
4.75	90-100	20-55
2.36	75-100	0-15
1.18	50-90	
0.6	20-60	
0.3	10-30	
0.15	2-10	
0.075	0-3	0-2

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PIPES DN375 AND LARGER TO BE STEEL REINFORCED CONCRETE PIPES CLASS '2' APPROVED SPIGOT AND SOCKET WITH RUBBER RING JOINTS

PIPES FOR SUB-SOIL DRAINS SHALL BE SLOTTED 100MM DIAMETER CLASS 1000 WRAPPED IN GEOFABRIC, U.O.N. COMPLYING WITH THE

PRECAST PITS, WHERE ALLOWED, AND THE IN-SITU BASE SHALL COMPLY WITH THE REQUIREMENT OF THE MANUFACTURER.

10. ALL BALCONIES/ROOF AREAS TO HAVE 150X75 OVERFLOW SPOUTS, 50mm BELOW INTERIOR FFL, UNLESS NOTIFIED BY THE ARCHITECT.

14. ALL MILD STEEL FIXTURES INCLUDING GRATES, FRAMES, STEP IRONS, LADDERS, ETC., SHALL BE HOT DIP GALVANISED, GALVANIZING SHALL


EXTERNAL DIAMETER OF PIPE PLUS 200 mm.

19. ALL PIPES SHALL BE BACKFILLED WITH GRANULAR MATERIAL SUCH AS QUARRY FINES OR COARSE RIVER SAND TO A MINIMUM OF 150 mm ABOVE THE PIPE. THE GRANULAR MATERIAL SHALL BE PLACED IN 150 mm THICK MAXIMUM LAYERS AND COMPACTED TO ACHIEVE A DENSITY INDEX (ID) OF 70%. FREQUENCIES OF COMPACTION TESTS FOR TRENCHES SHALL BE 1 TEST PER 2 LAYERS PER 40 LINEAR METRE 20. BACKFILL THE REMAINDER OF THE TRENCH ABOVE THE SAND TO SUBGRADE LEVEL WITH TRENCH MATERIAL. PLACE AND COMPACT MATERIALS IN LAYERS NOT EXCEEDING 150MM LOOSE THICKNESS. MATERIALS LOWER THAN 500MM BELOW SUBGRADE LEVEL SHALL BE COMPACTED TO AT LEAST 95% OF STANDARD MAXIMUM DRY DENSITY. THE TOP 500MM BELOW PAVEMENT SUBGRADE LEVELS SHALL BE COMPACTED TO AT

21. FILTER MATERIAL FOR SUBSOIL SHALL BE COARSE SAND OR CRUSHED STONE COMPLYING WITH ONE OF THE GRADING IN THE TABLE BELOW. WHERE NOTED ON THE DRAWINGS THE 7mm CRUSHED ROCK FILTER MATERIAL SHALL BE ENCLOSED WITHIN FILTER FABRIC SHEET AS SPECIFIED. FILTER MATERIAL SHALL BE PLACED IN 250mm LAYERS AND COMPACTED TO DENSITY INDEX (ID) OF 60%.

> ALL SYMBOLS MAY NOT NECESSARILY BE USED IN THESE DRAWINGS PROPOSED DEVELOPMENT AT PROJECT 13-19 CANBERRA AVE, ST LEONARDS NSW 2065 STORMWATER - LEGEND & GENERAL NOTES DRG. TITLE DISC. PROJECT No. DRAWING No. 2000192 STW 001

THIS IS A STANDARD LEGEND.

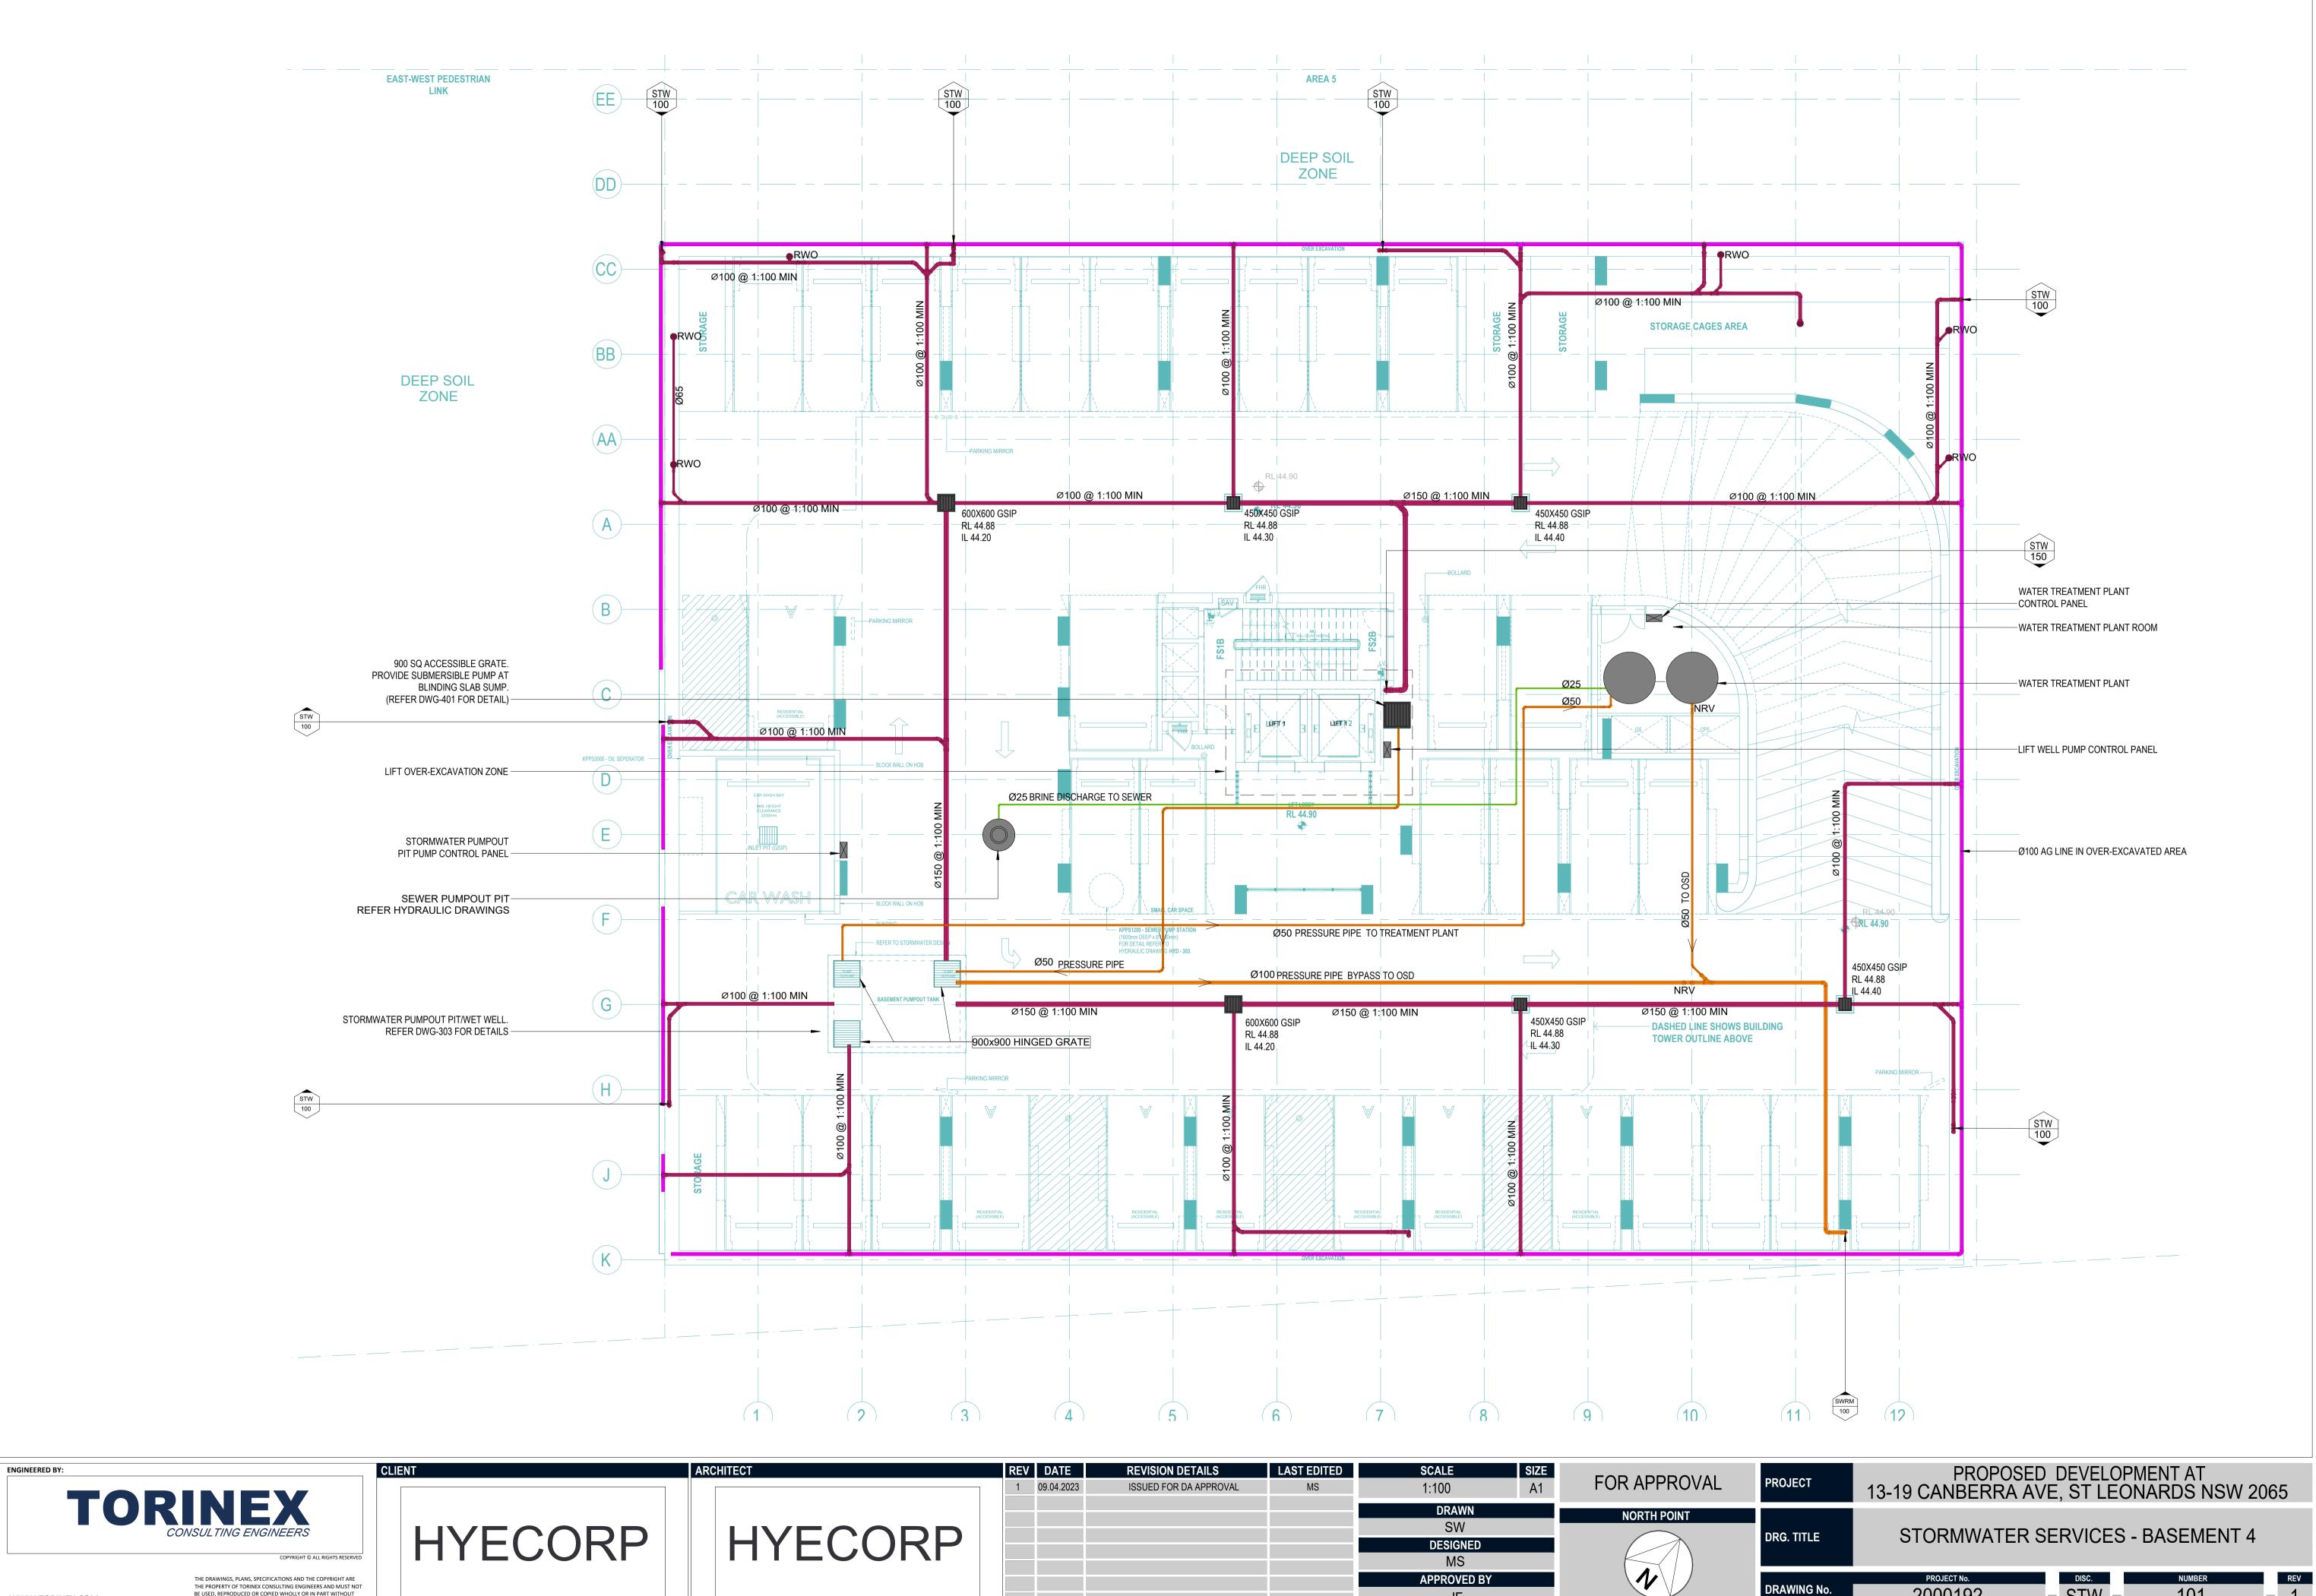

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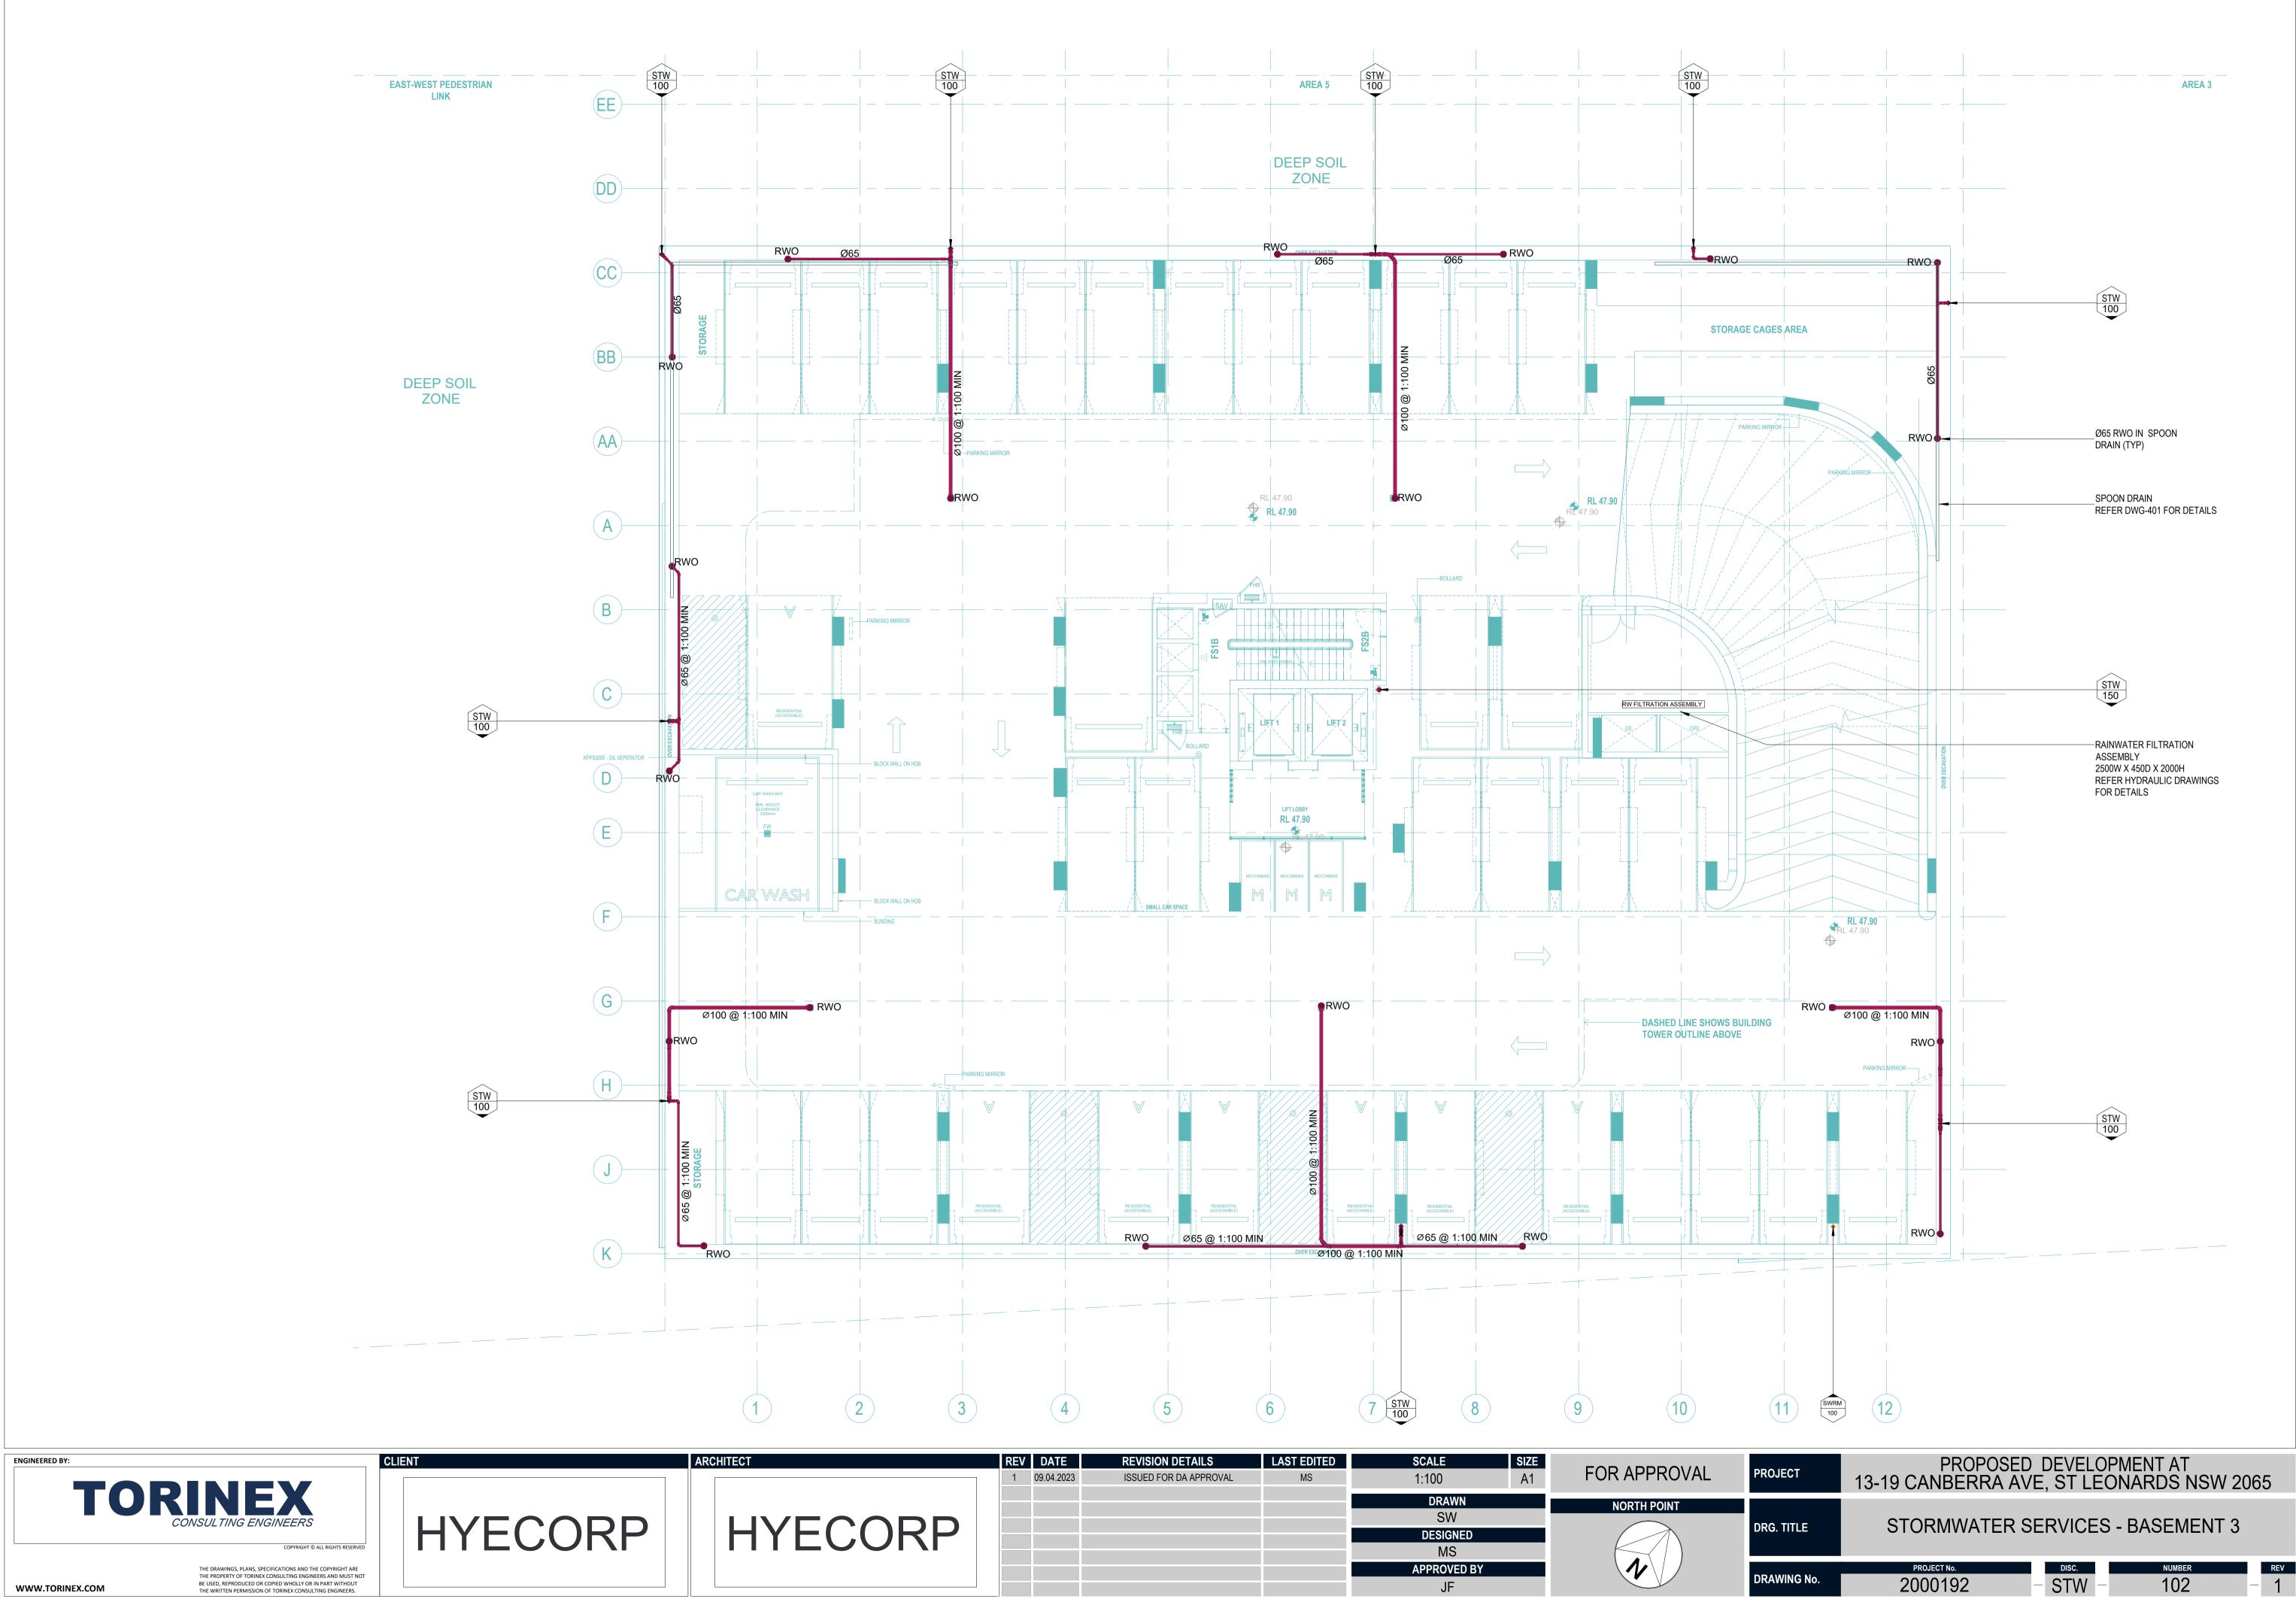
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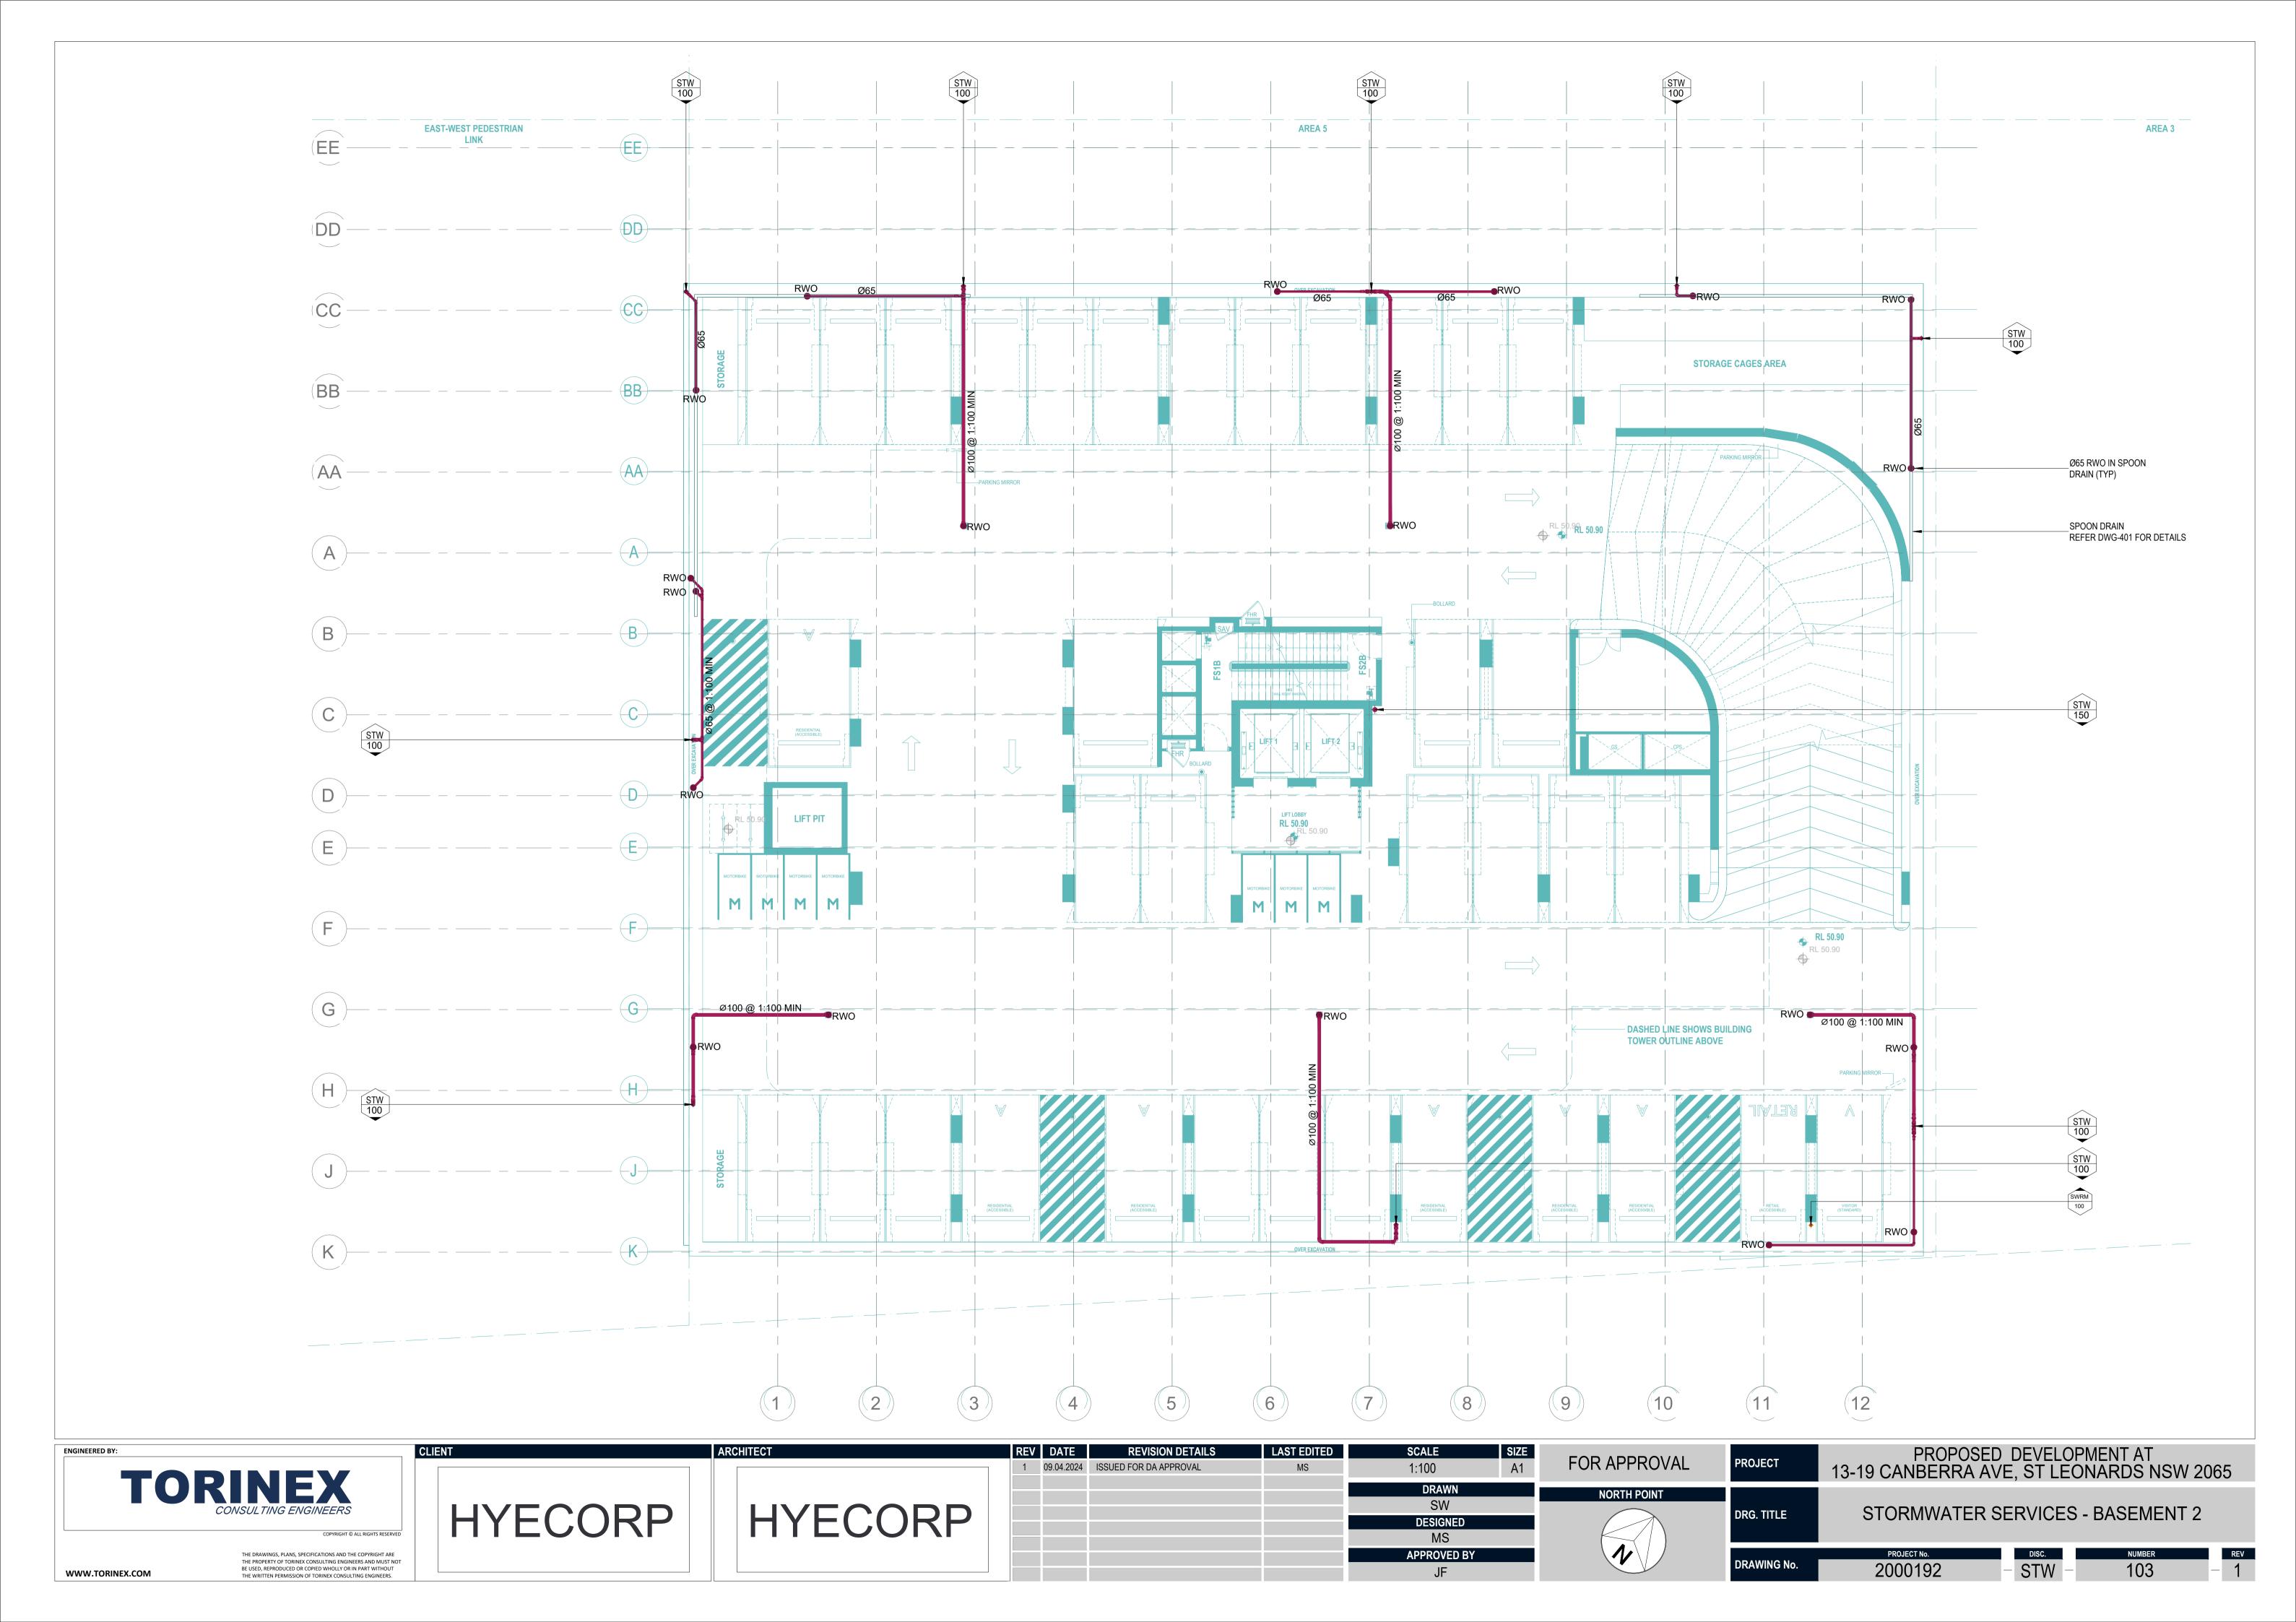
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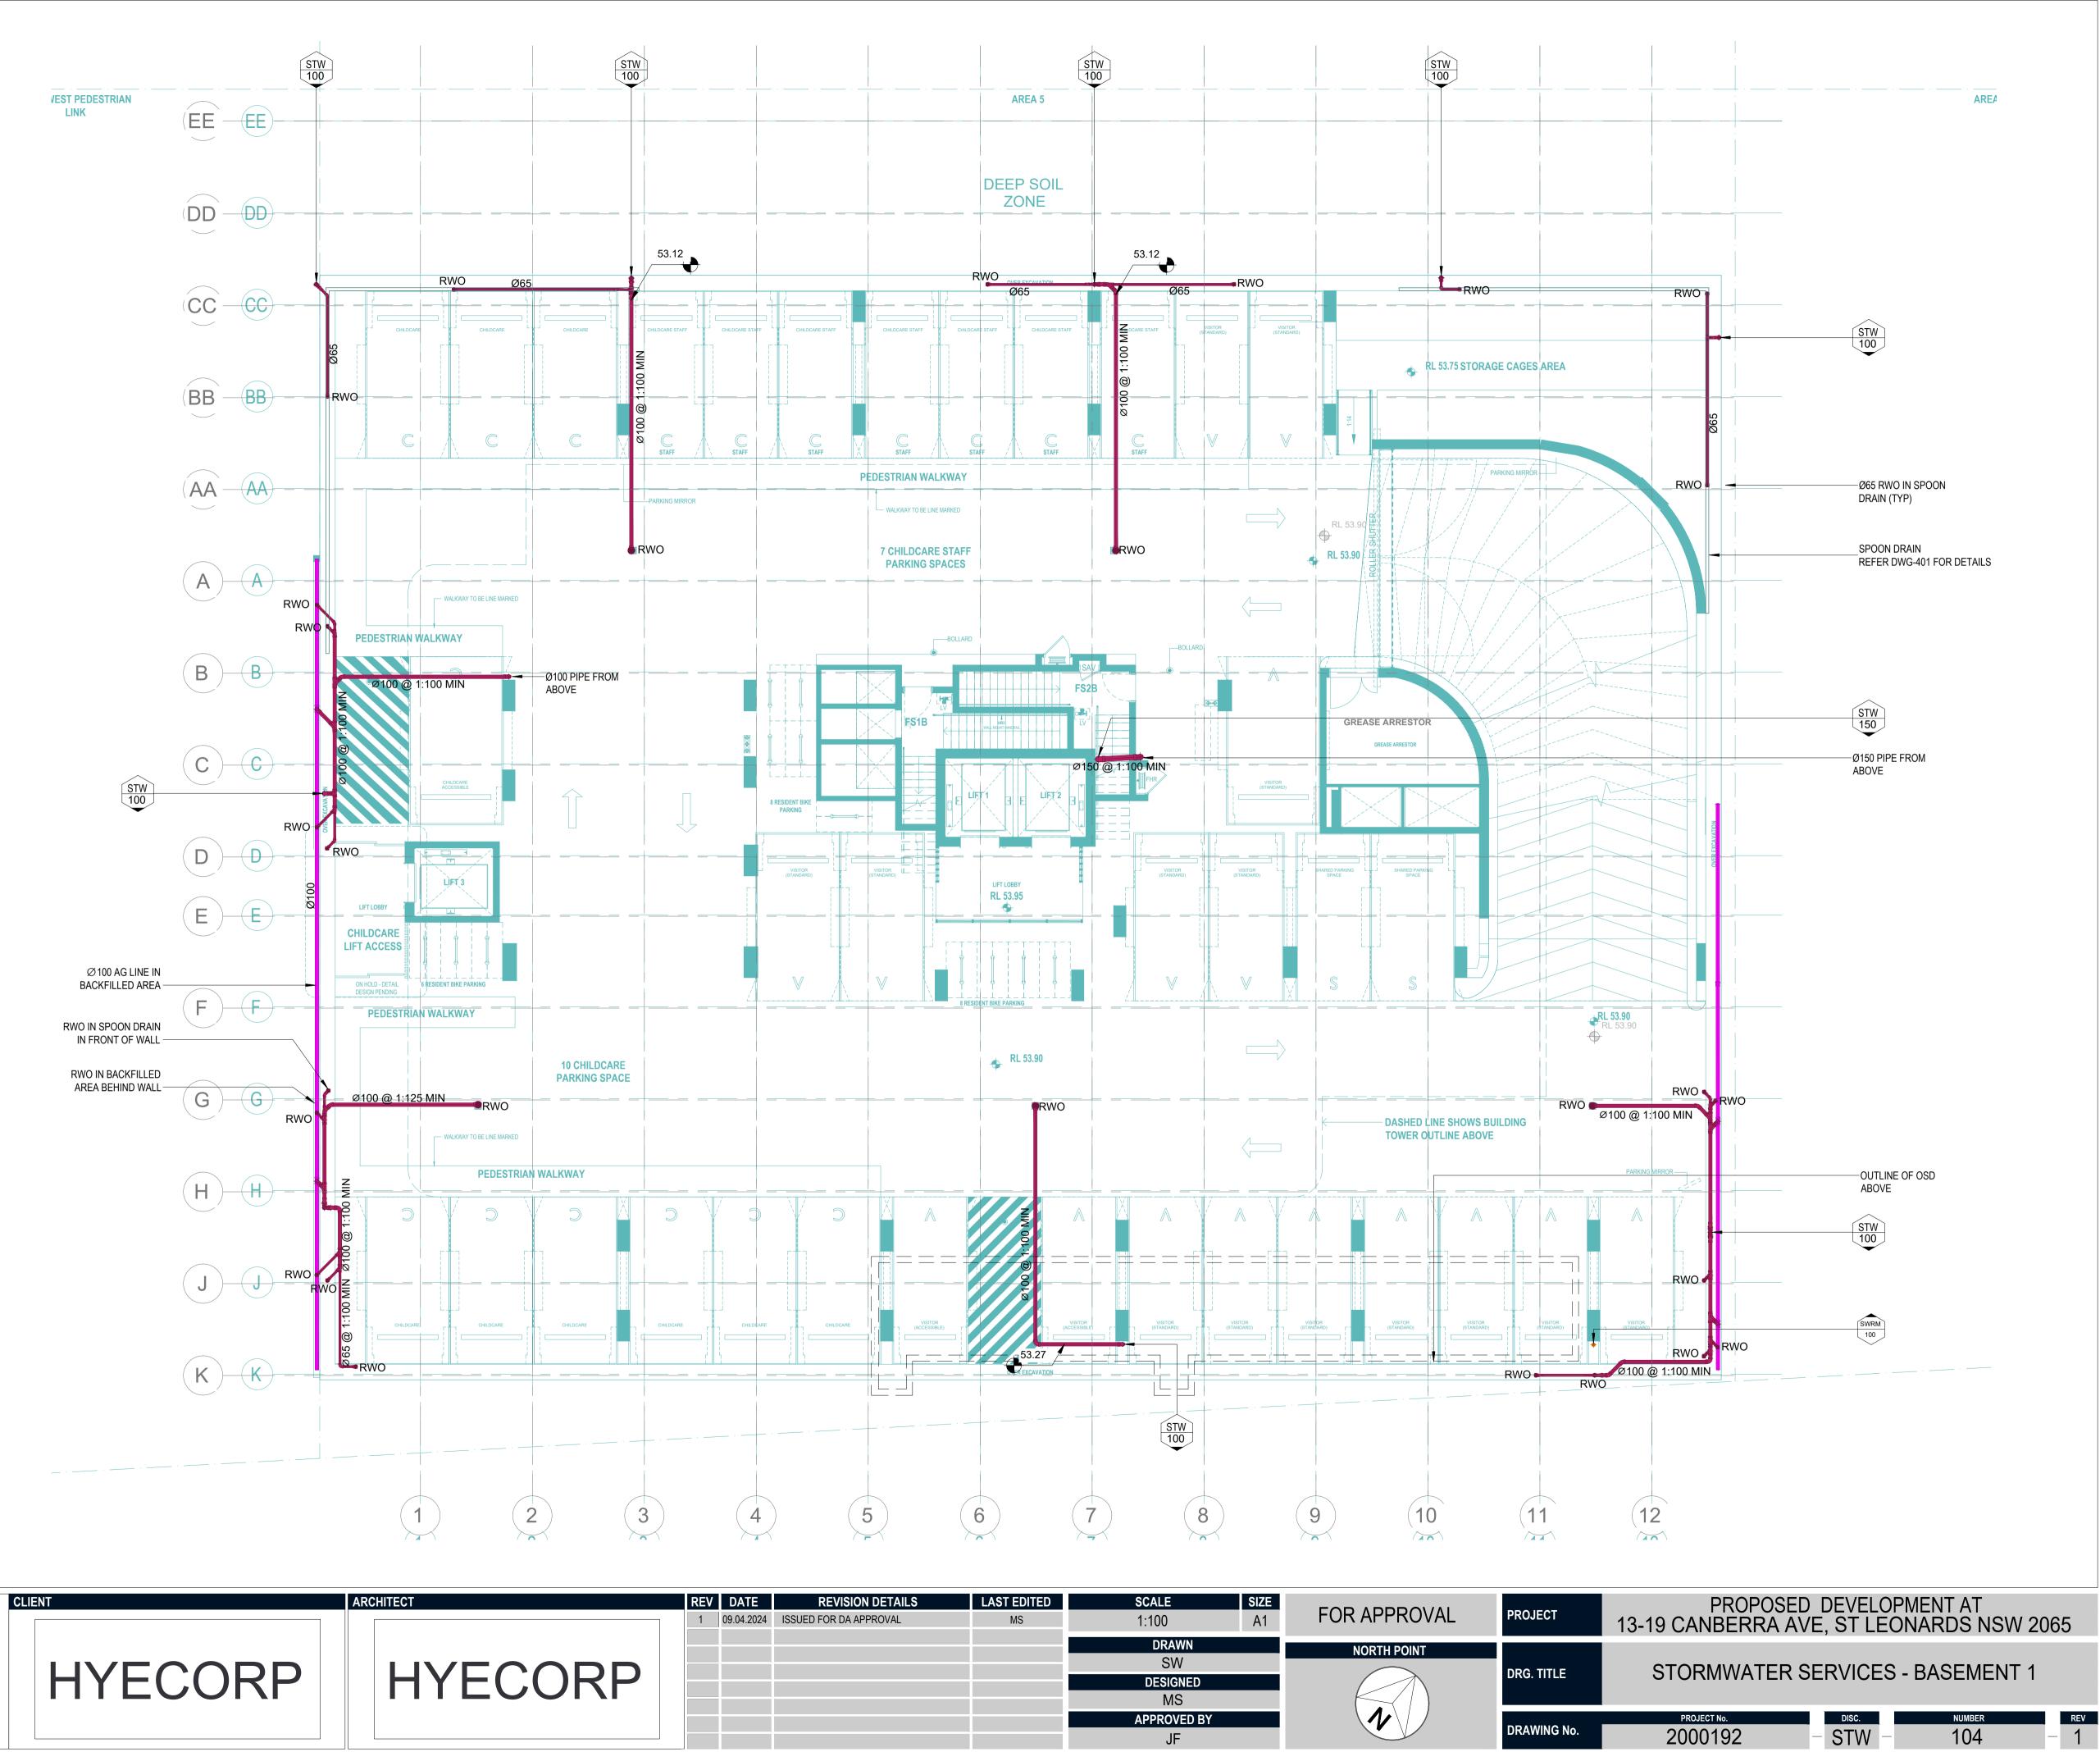


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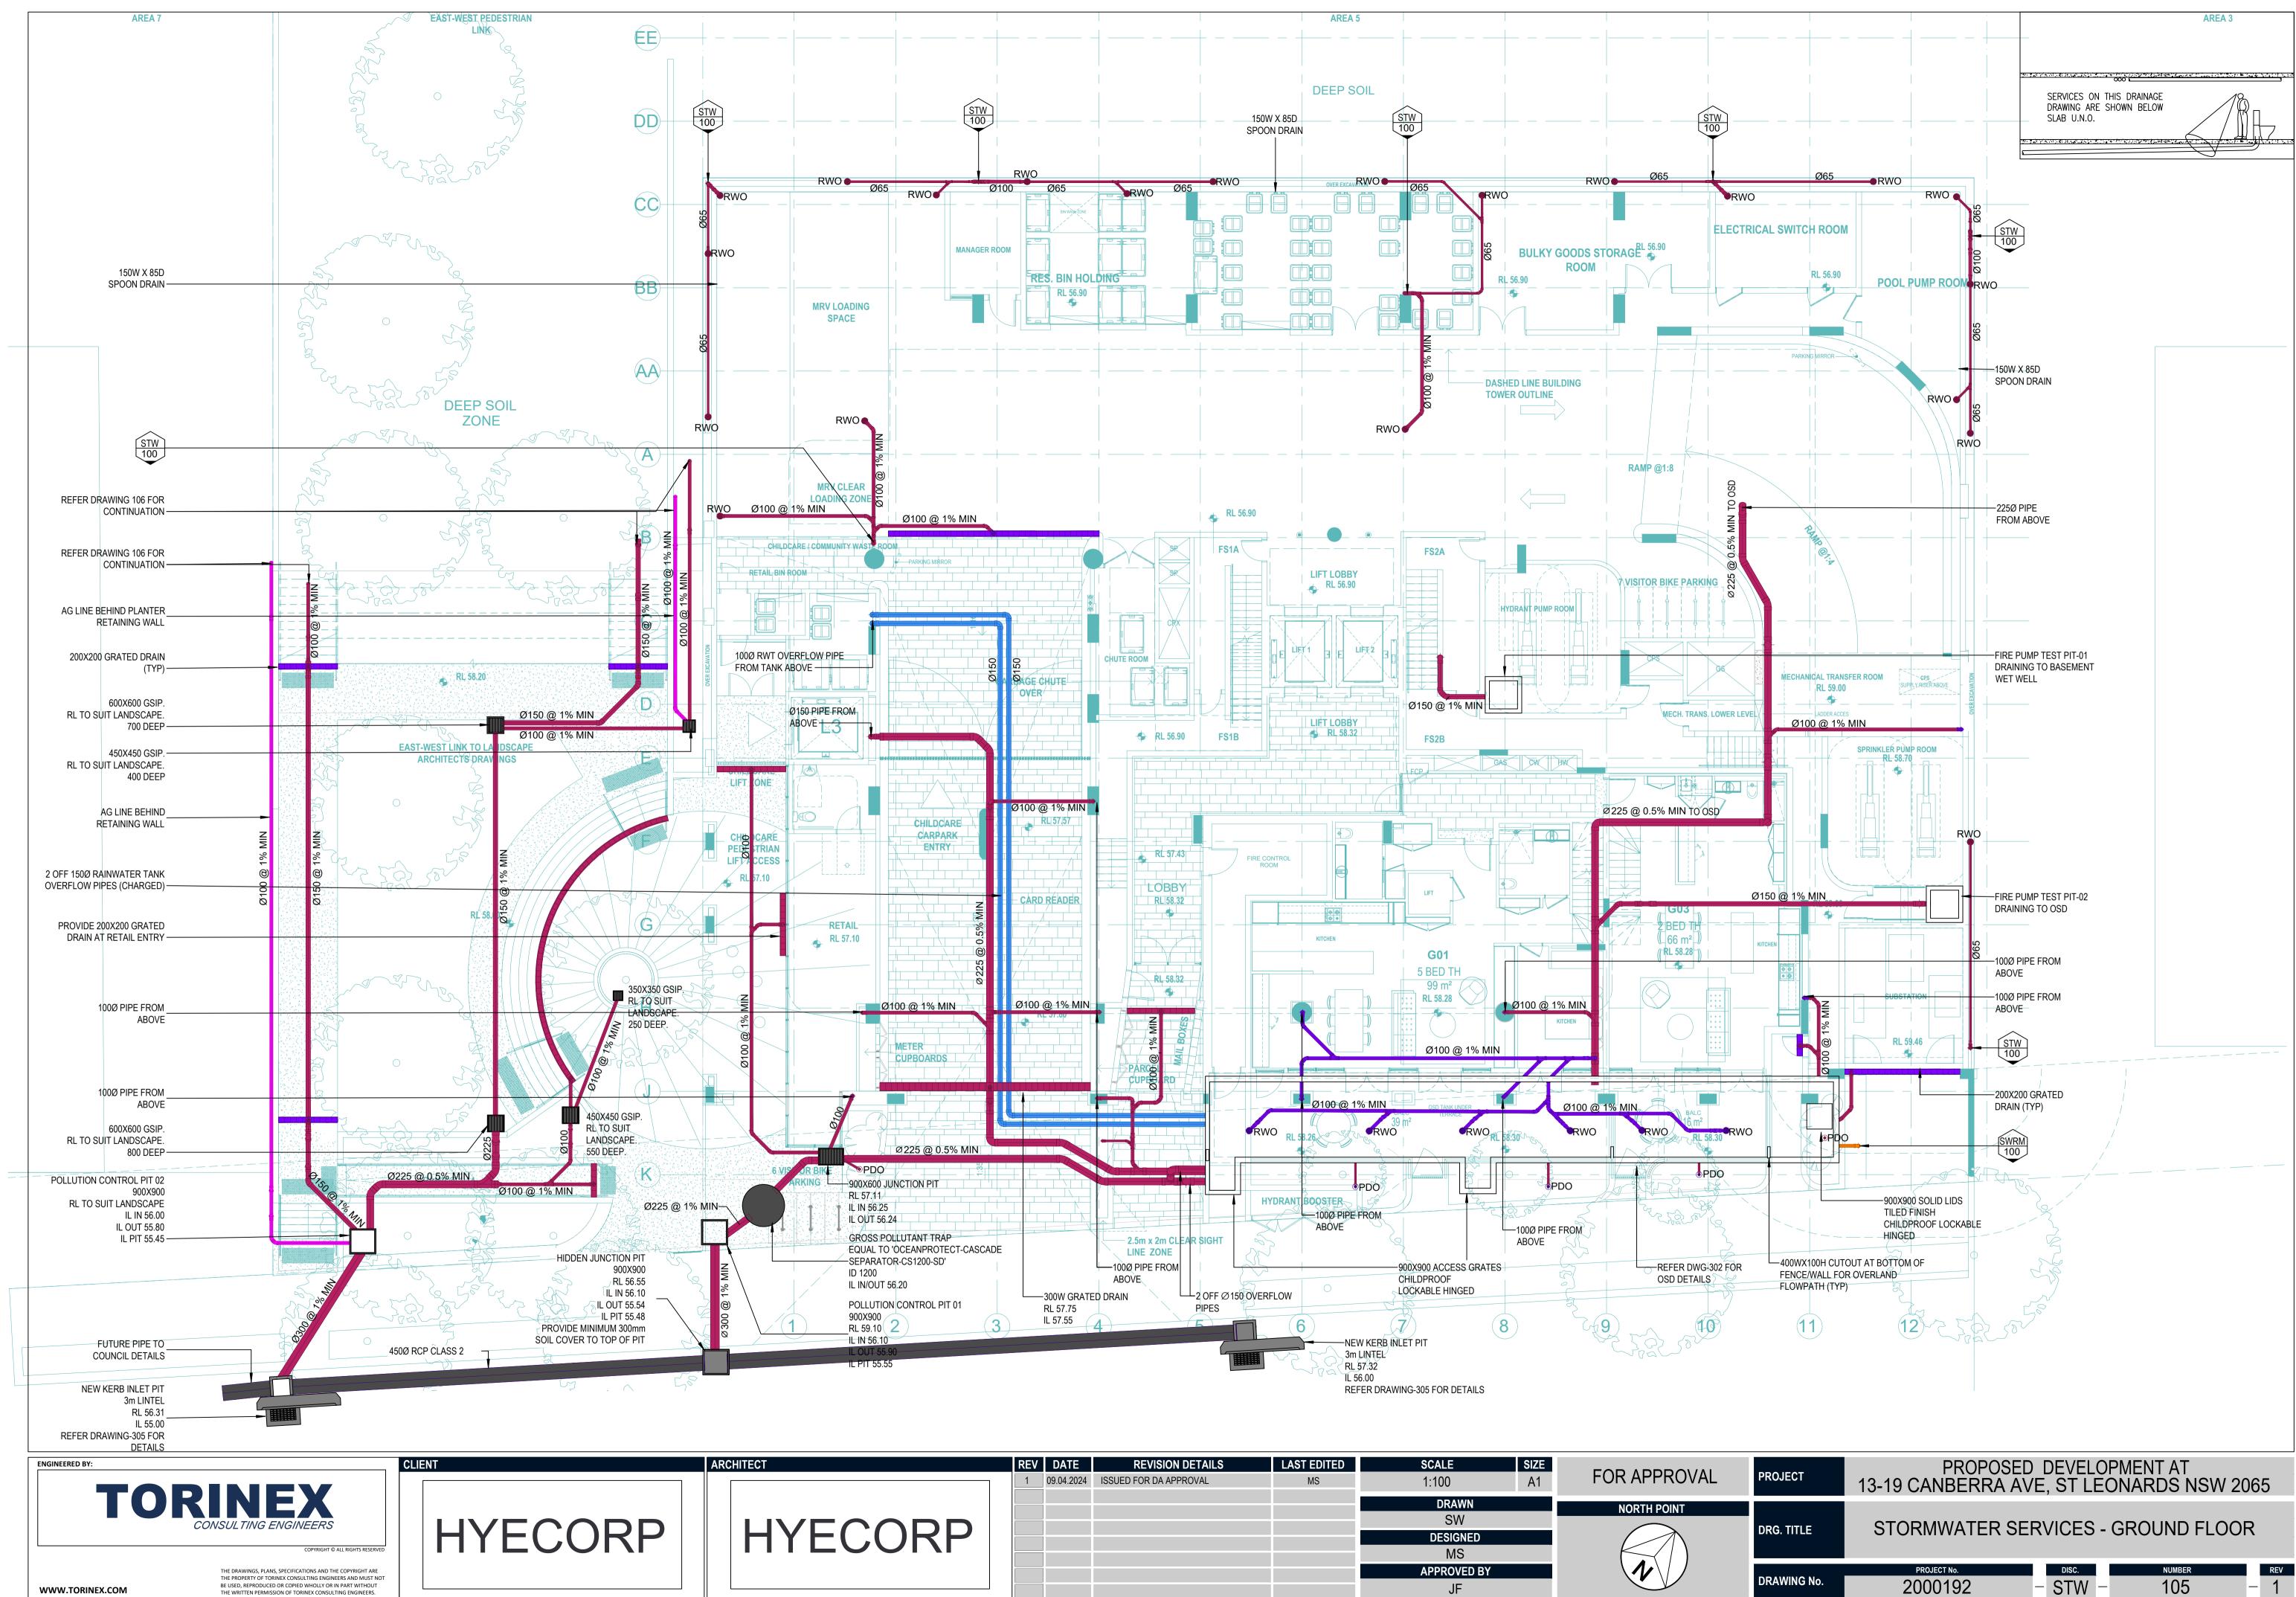







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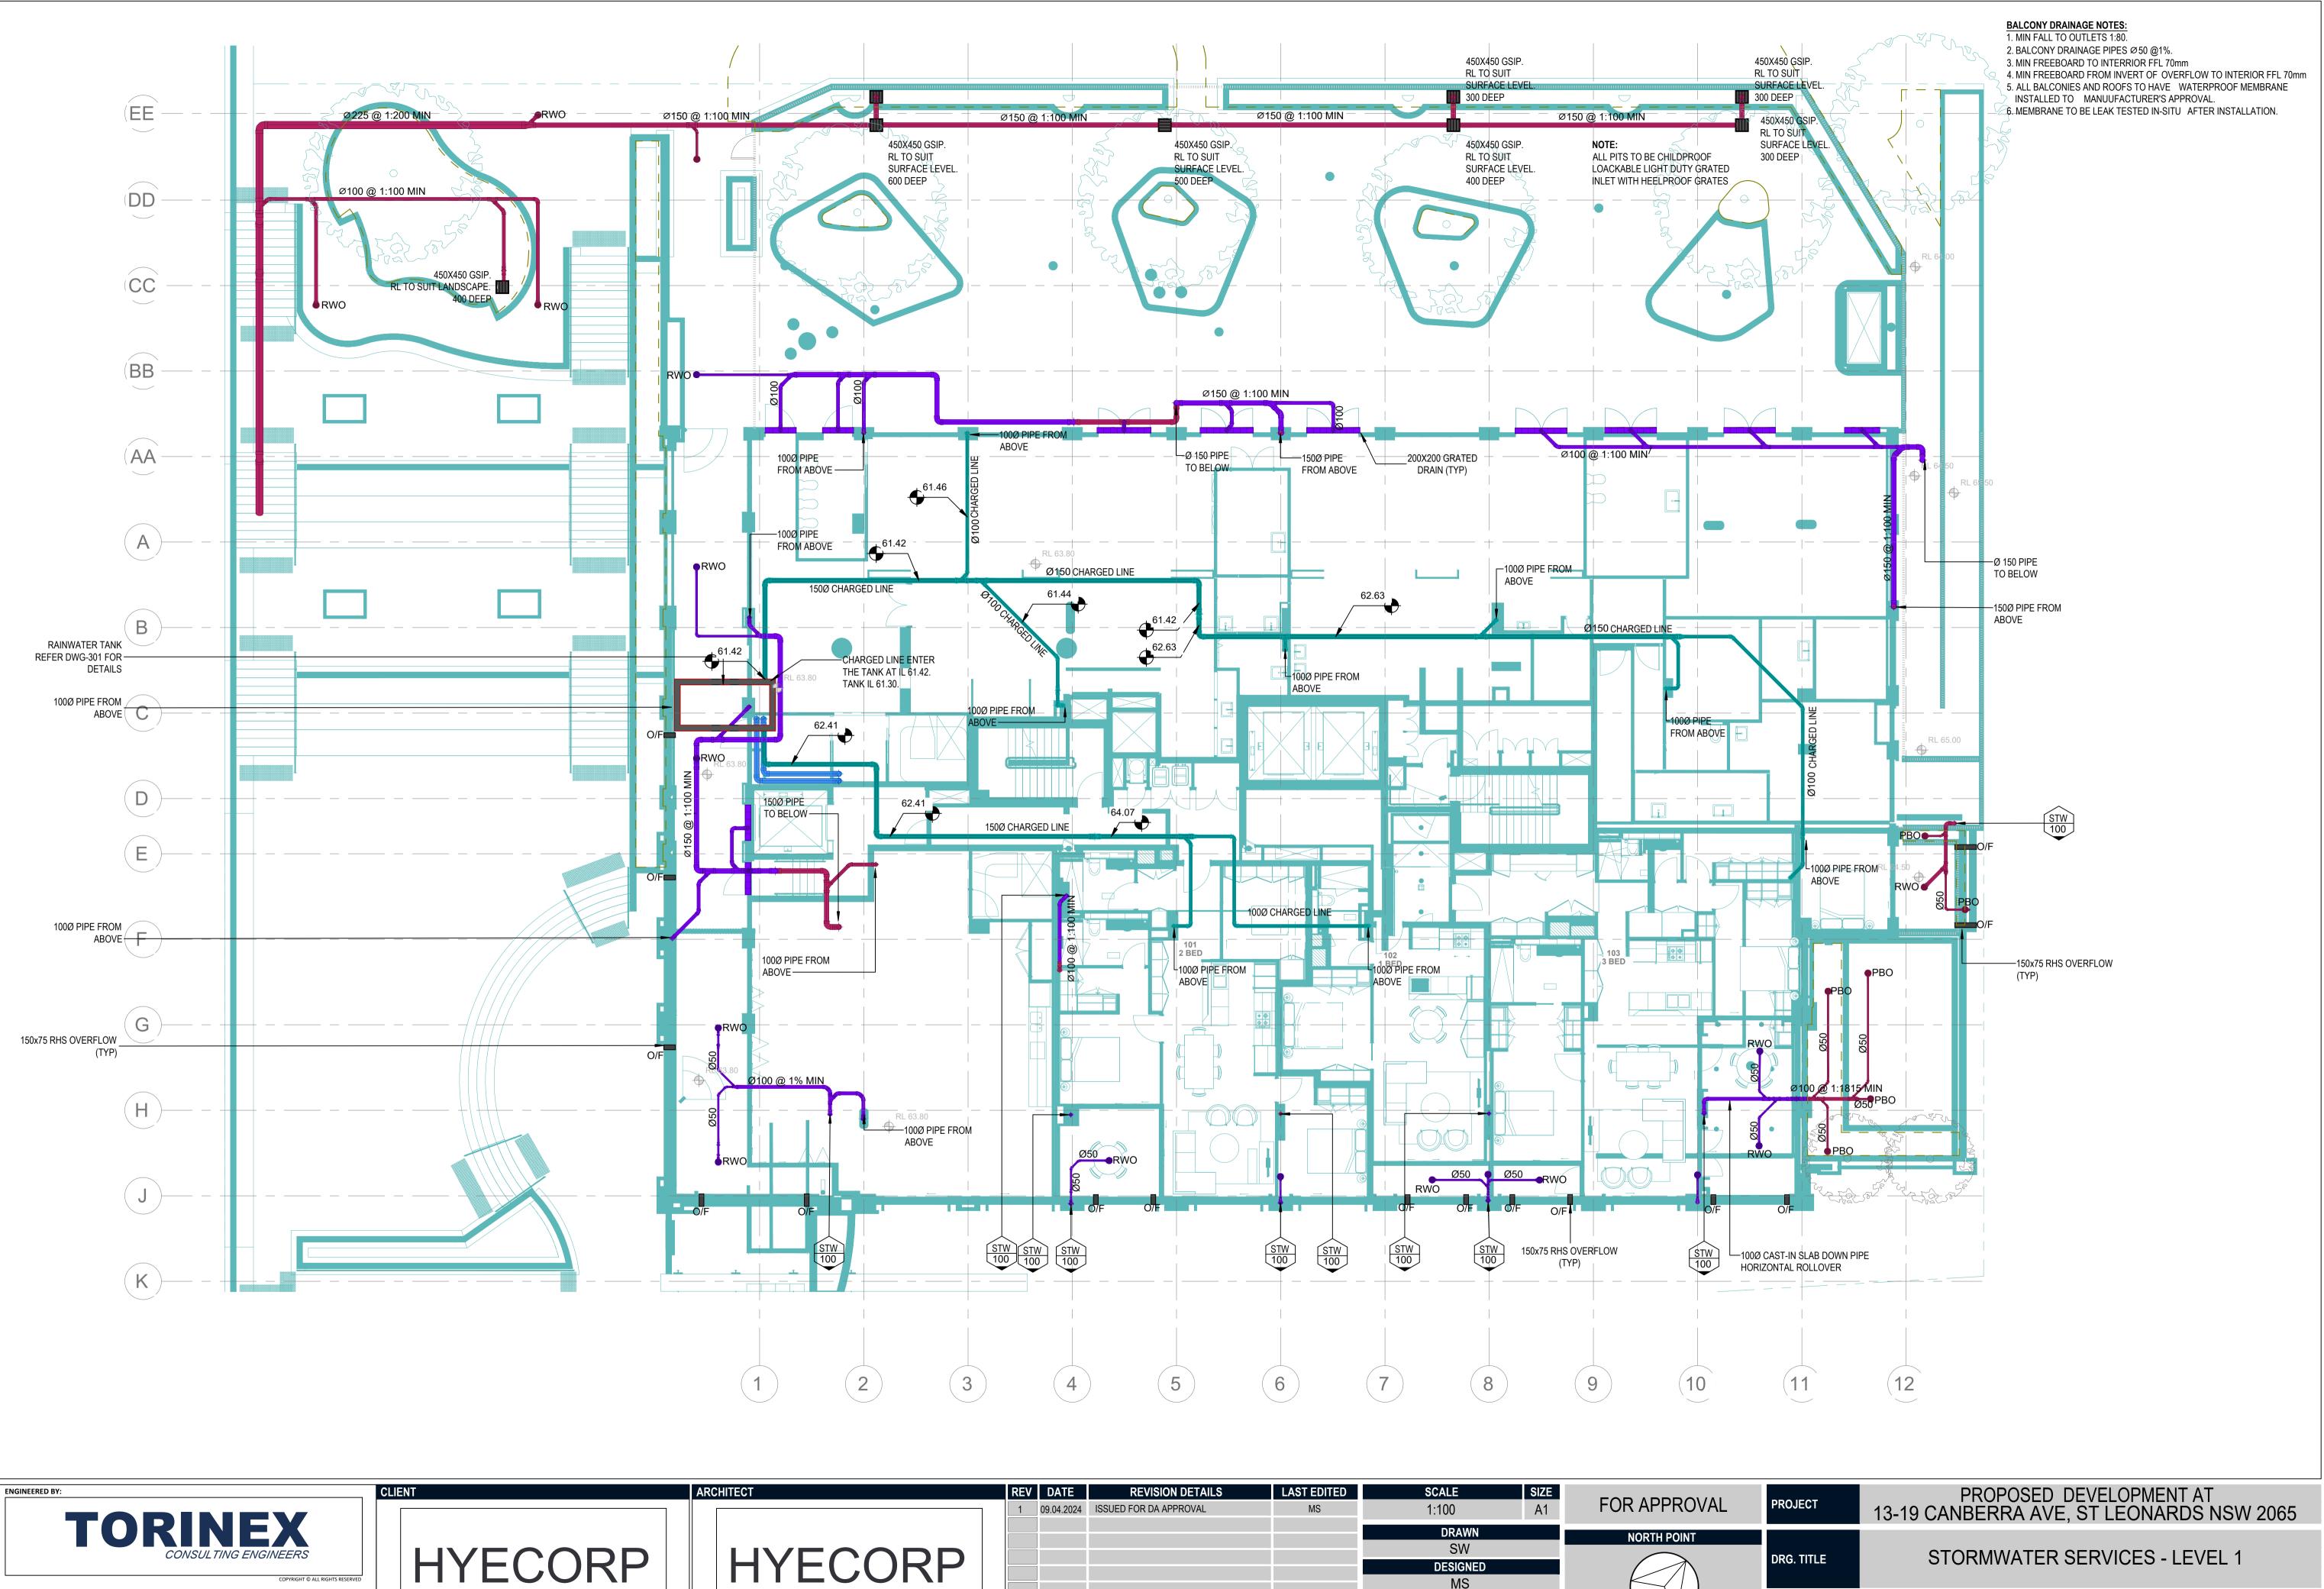
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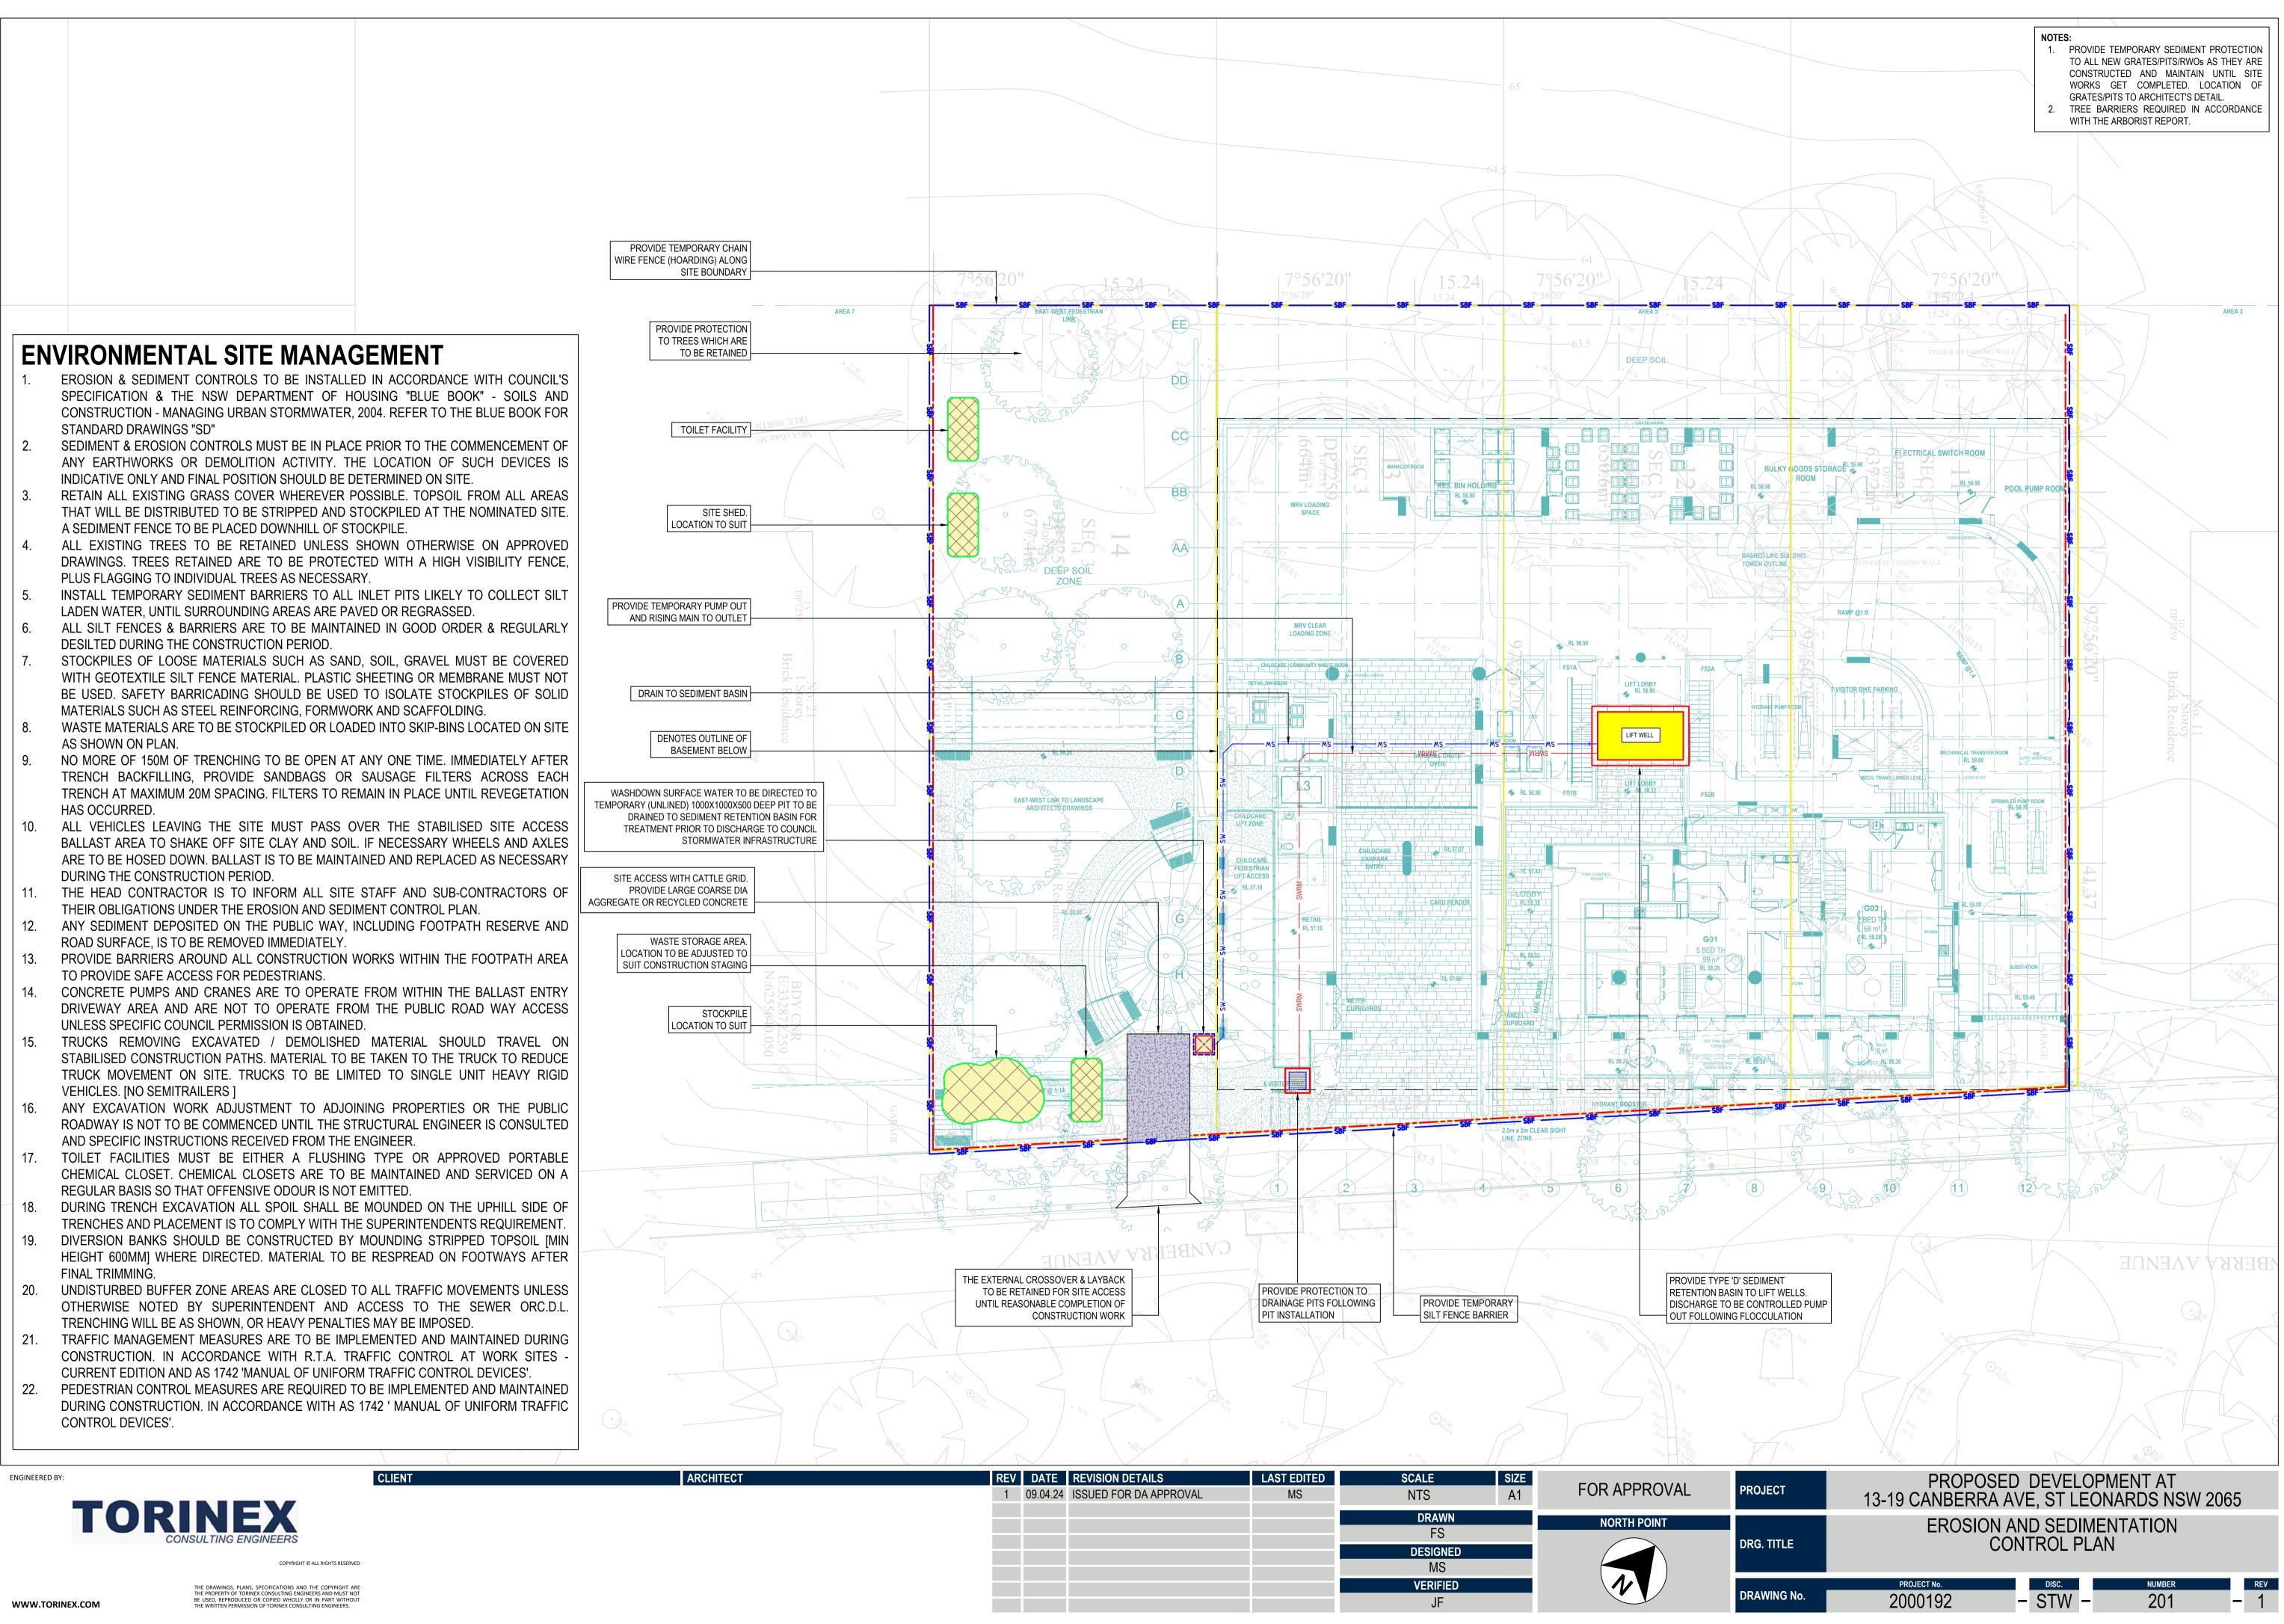


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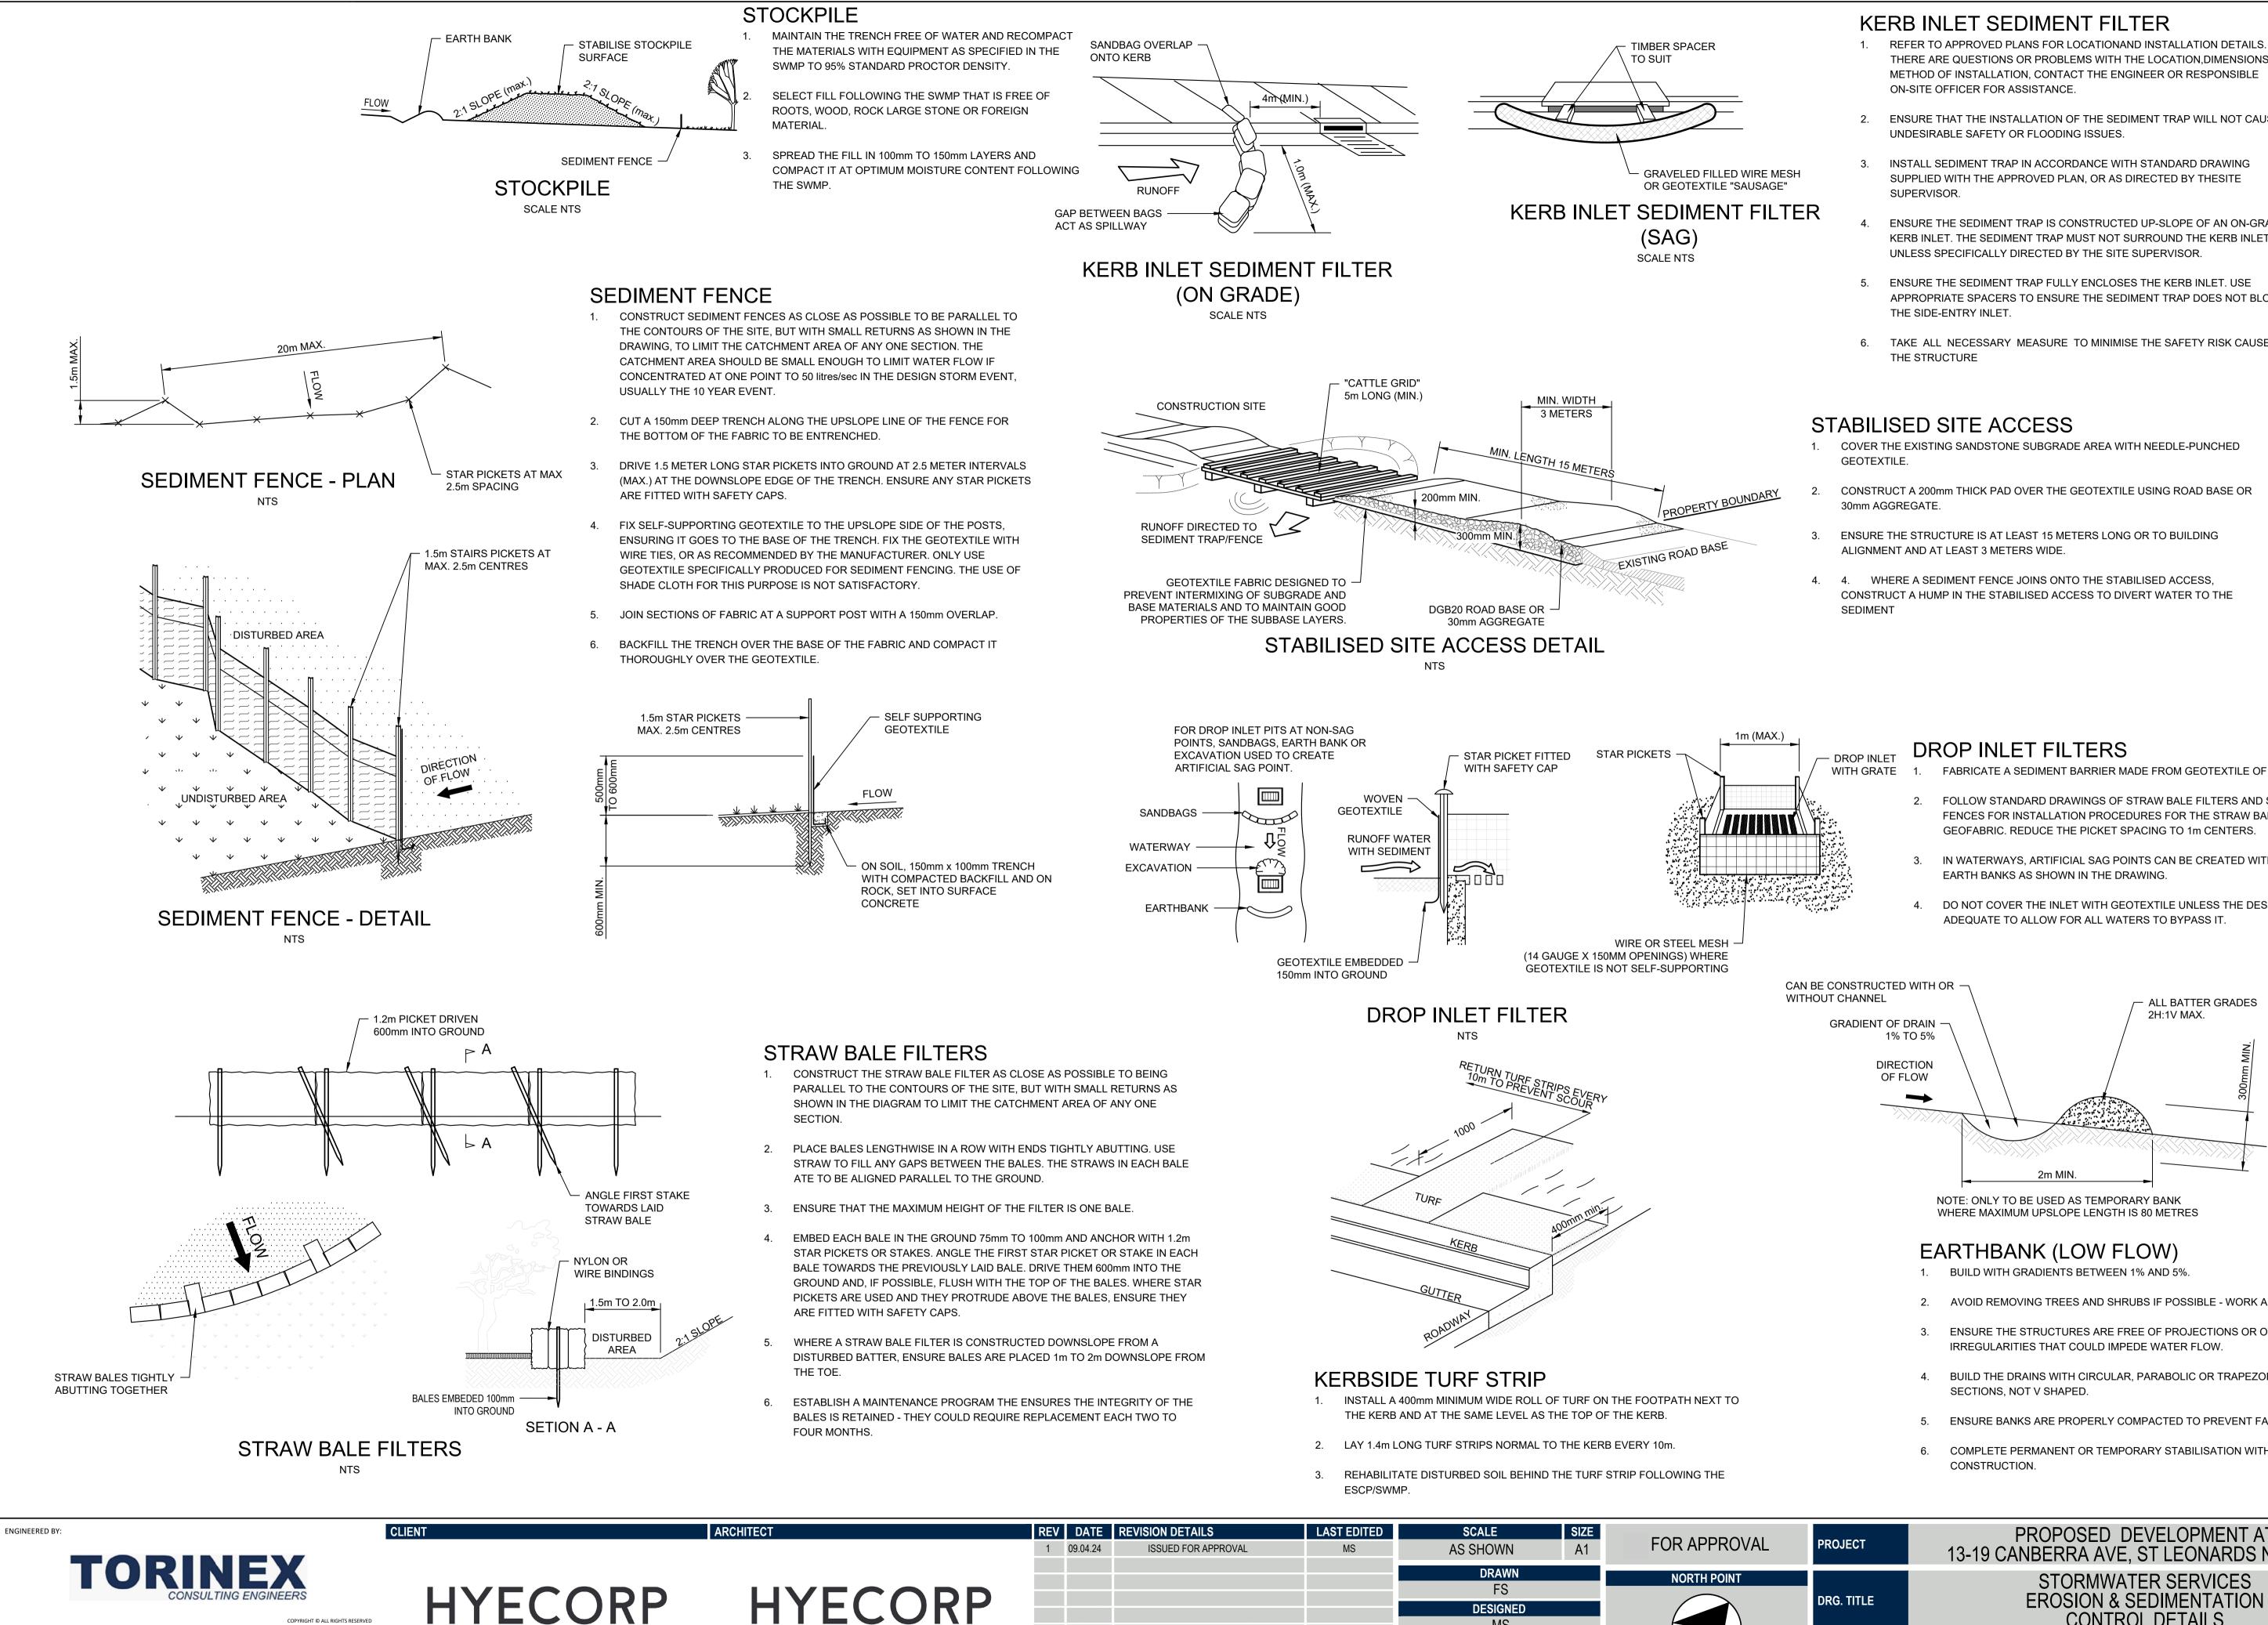


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]			APPROVED BY JF			DRAWING No.	PROJECT No. 2000192	– STW –	NUMBER 107	1

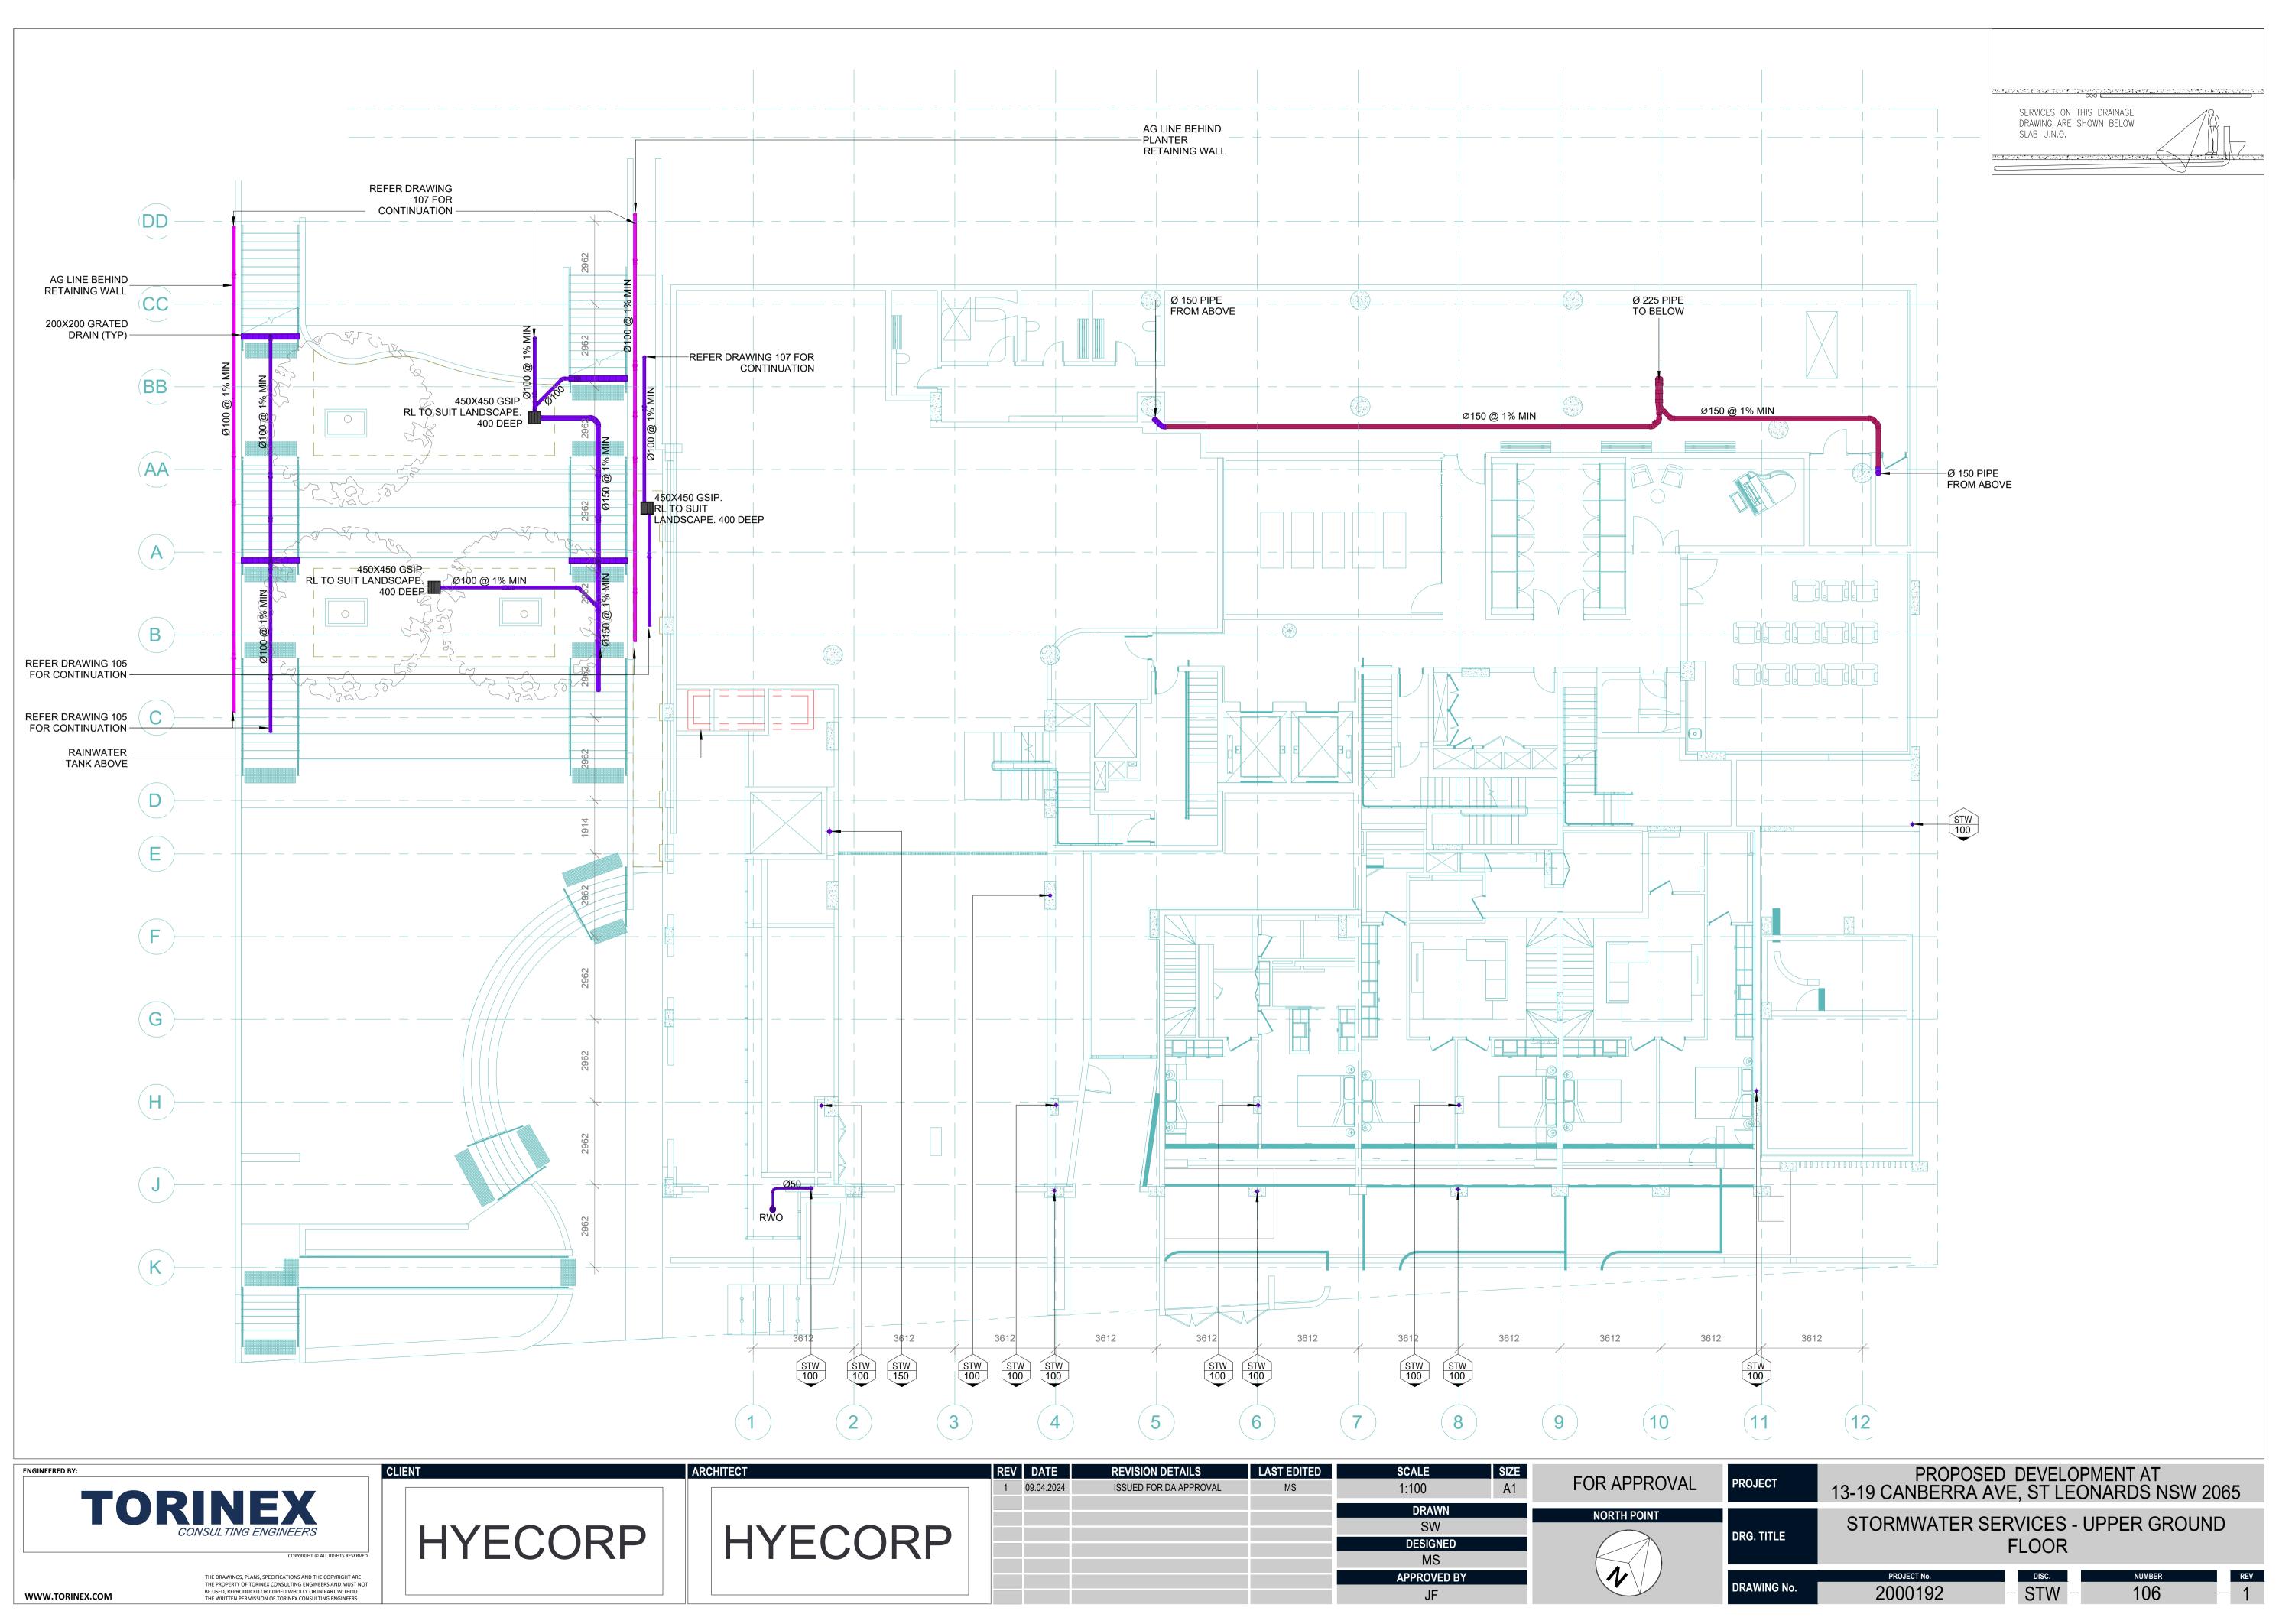

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- 1. REFER TO APPROVED PLANS FOR LOCATIONAND INSTALLATION DETAILS. IF THERE ARE QUESTIONS OR PROBLEMS WITH THE LOCATION, DIMENSIONS, OR
- 2. ENSURE THAT THE INSTALLATION OF THE SEDIMENT TRAP WILL NOT CAUSE
- ENSURE THE SEDIMENT TRAP IS CONSTRUCTED UP-SLOPE OF AN ON-GRADE KERB INLET. THE SEDIMENT TRAP MUST NOT SURROUND THE KERB INLET
- APPROPRIATE SPACERS TO ENSURE THE SEDIMENT TRAP DOES NOT BLOCK
- 6. TAKE ALL NECESSARY MEASURE TO MINIMISE THE SAFETY RISK CAUSED BY

- FABRICATE A SEDIMENT BARRIER MADE FROM GEOTEXTILE OF STRAW BALES.
- FOLLOW STANDARD DRAWINGS OF STRAW BALE FILTERS AND SEDIMENT FENCES FOR INSTALLATION PROCEDURES FOR THE STRAW BALES OR
- IN WATERWAYS, ARTIFICIAL SAG POINTS CAN BE CREATED WITH SANDBAGS OR
- DO NOT COVER THE INLET WITH GEOTEXTILE UNLESS THE DESIGN IS

- 2. AVOID REMOVING TREES AND SHRUBS IF POSSIBLE WORK AROUND THEM.
- ENSURE THE STRUCTURES ARE FREE OF PROJECTIONS OR OTHER
- BUILD THE DRAINS WITH CIRCULAR, PARABOLIC OR TRAPEZOIDAL CROSS
- ENSURE BANKS ARE PROPERLY COMPACTED TO PREVENT FAILURE.
- COMPLETE PERMANENT OR TEMPORARY STABILISATION WITHIN 10 DAYS OF

PROJECT	PROPOSED DEVELOPMENT AT 13-19 CANBERRA AVE, ST LEONARDS NSW 2065							
DRG. TITLE	EROSIO	WATER SERV N & SEDIMENT NTROL DETAIL	ATION					
DRAWING No.	PROJECT No. 2000192	– STW –	NUMBER	- 1				







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ARCHITECT





	Sou	rces	Residu	al Load	% Reduction		
	Pre	Post	Pre	Post	Pre	Post	
Flow (ML/yr)	2.23	2.86	2.23	2.86	0	0	
Total Suspended Solids (kg/yr)	219	299	219	59.9	0	80	
Total Phosphorus (kg/yr)	0.517	0.647	0.517	0.453	0	30	
Total Nitrogen (kg/yr)	4.66	6.15	4.66	4.31	0	29.9	
Gross Pollutants (kg/yr)	46.9	65.6	46.9	3.28	0	95	

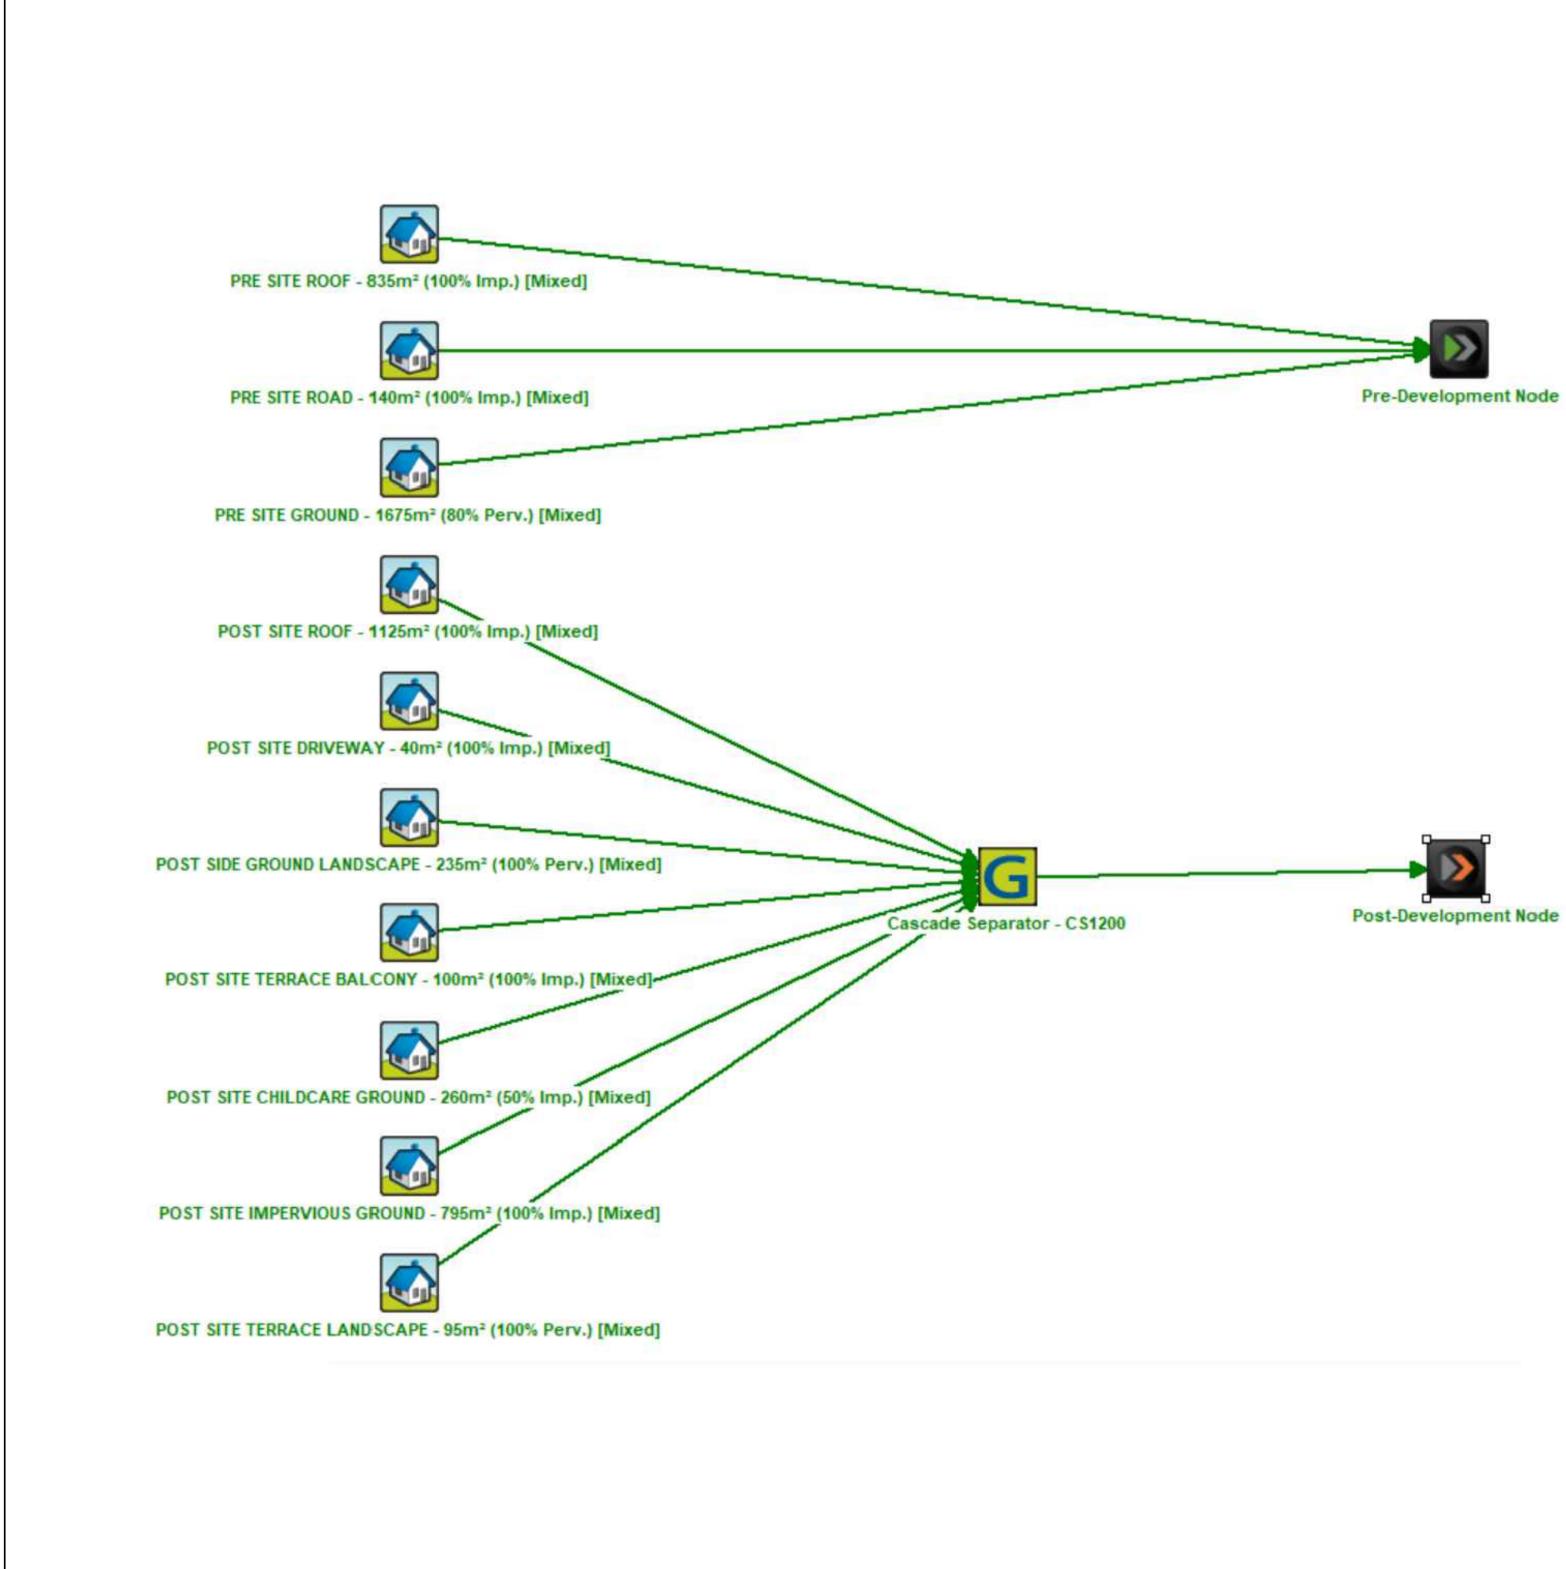19671	- 13-19	Canberra
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Pre-Development	Source (kg/yr)	Residual Load (kg/yr)	% Reduction
Flow (ML/yr)	2.23	2.23	0
Total Suspended	2.19E+02	2.19E+02	0
Total Phosphorus	5.17E-01	5.17E-01	0
Total Nitrogen (kg/yr)	4.66	4.66	0
Gross Pollutants	46.9	46.9	0
Post-Development	Source (kg/yr)	Residual Load (kg/yr)	% Reduction
Flow (ML/yr)	2.86	2.86	0
Total Suspended	2.99E+02	5.99E+01	80
Total Phosphorus	6.47 <mark>E-0</mark> 1	4.53E-01	30
Total Nitrogen (kg/yr)	6.15	4.31	30
Gross Pollutants	6.56E+01	3.28	95
NorBE	Pre-Development Load (kg/yr)	Post Development Load (kg/yr)	% Pre. Vs Post Reduction
Flow (ML/yr)	2.23	2.86	-28.3%
Total Suspended Solids (kg/yr)	2.19E+02	59.9	72.6%
Total Phosphorus (kg/yr)	0.517	0.453	12.4%
Total Nitrogen (kg/yr)	4.66	4.31	7.5%
Gross Pollutants (kg/yr)	46.9	3.28	93.0%
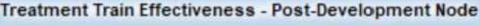
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PROJECT	PROPOSED DEVELOPMENT AT 13-19 CANBERRA AVE, ST LEONARDS NSW 2065							
DRG. TITLE	STORMWATER SERVICES MUSIC MODEL							
DRAWING No.	PROJECT No. 2000192	– STW –	NUMBER 203	- 1				



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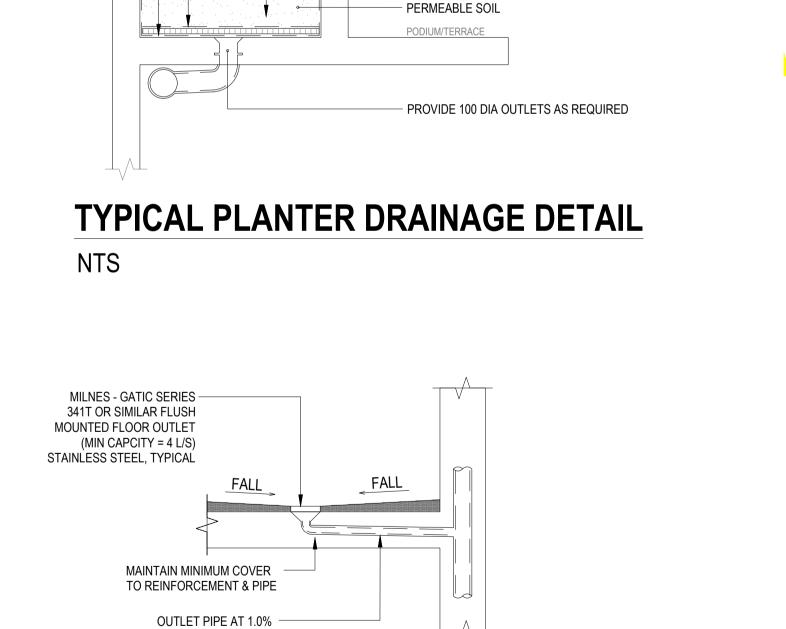
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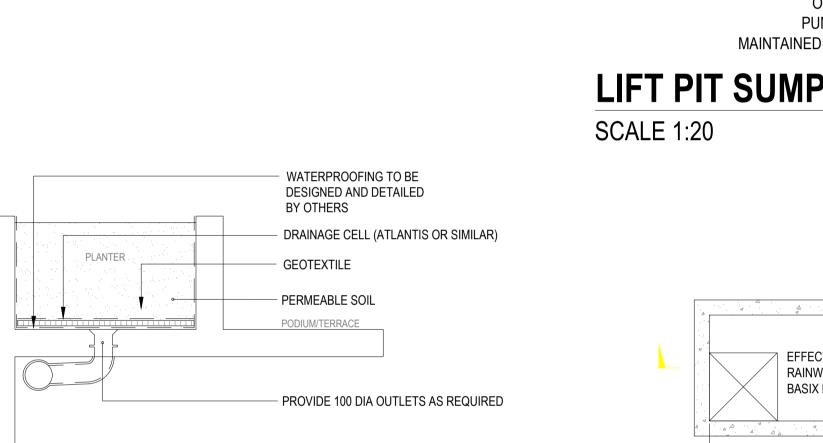



TYPICAL BALCONY FLOOR OUTLET DETAIL

RAINWATER USAGE AS PER BASIX REQUIREMENTS. **RAINWATER TANK**

DANGER

ENTER BY



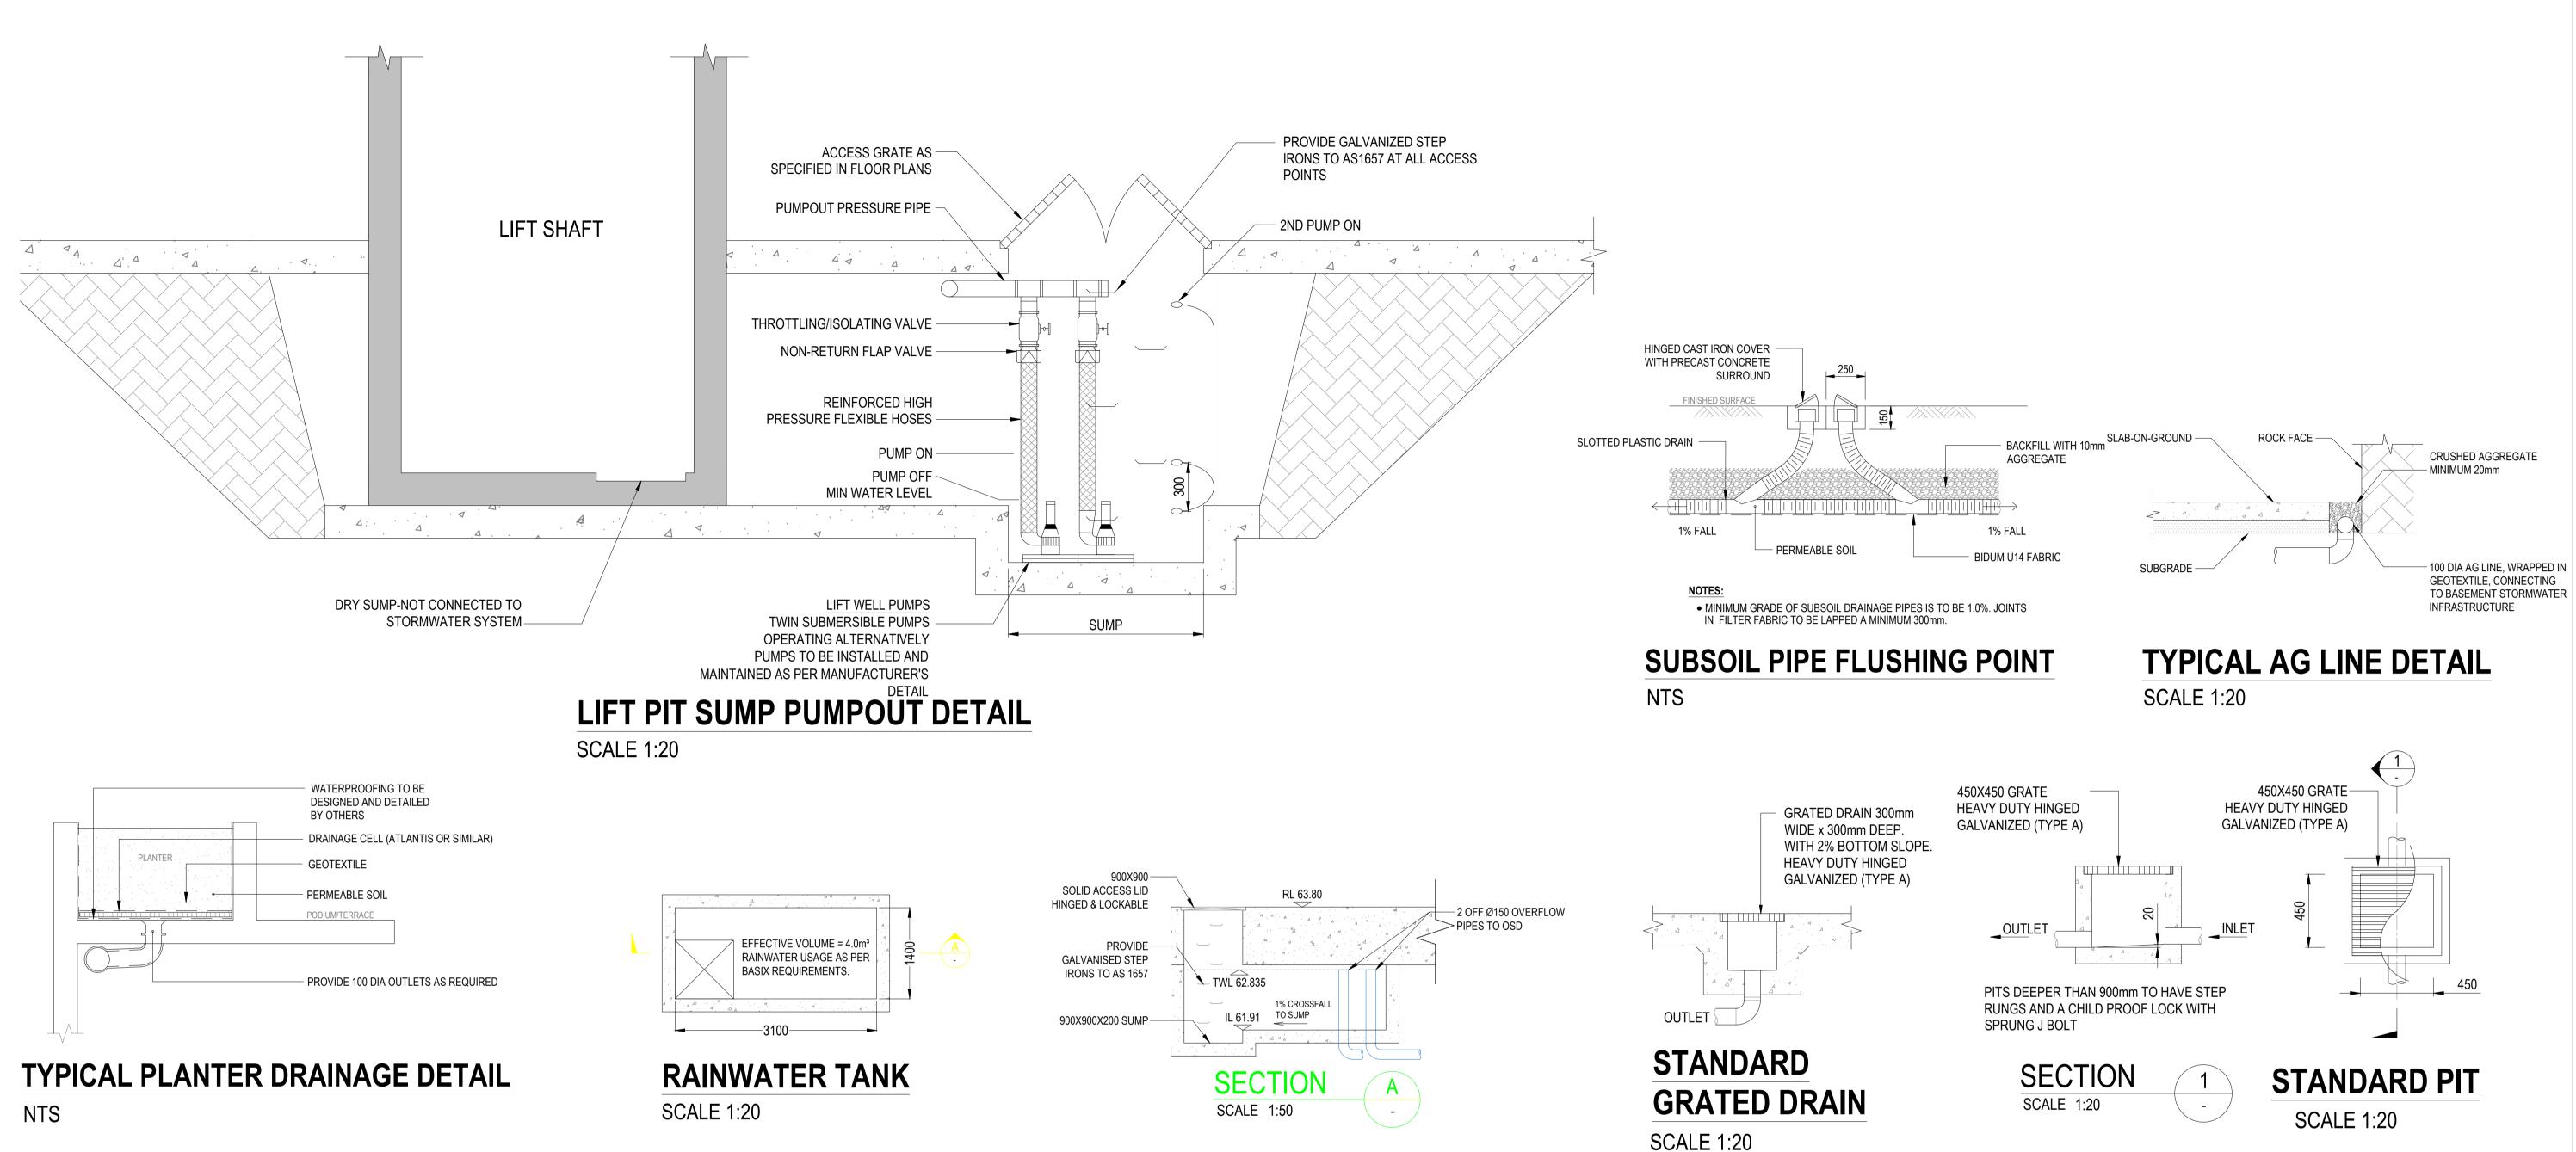



A CONFINED SPACE DANGER SIGN SHALL BE PROVIDED AT EACH ACCESS POINT OF TANK IN ACCORDANCE WITH COUNCIL'S SPECIFICATION

- A. A CONFINED SPACE DANGER SIGN SHALL BE POSITIONED IN A LOCATION AT ACCESS POINTS SUCH THAT IT IS CLEARLY VISIBLE TO PERSONS PROPOSING TO ENTER THE BELOW GROUND TANK.
- B. MINIMUM DIMENSIONS OF THE SIGN:
- 300mm X 450mm LARGE ENTRIES, SUCH AS DOORS 250mm X 180mm - SMALL ENTRIES, SUCH AS GATES & MANHOLES
- C. THE SIGN SHALL BE MANUFACTURED FROM COLOUR BONDED ALUMINIUM OR POLYPROPYLENE.
- D. SIGN SHALL BE AFFIXED USING SCREWS AT EACH CORNER OF THE SIGN AND/OR SUITABLE EPOXY GLUE/CEMENT.

CONFINED SPACE WARNING SIGN

								4. C
	REV	DATE	REVISION DETAILS	LAST EDITED	SCALE	SIZE		
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					MS APPROVED BY			
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MINIMUM INTERNAL DIMENSIONS FOR STORMWATER AND INLET PITS

		MINIMUM INTERNA	MINIMUM INTERNAL DIMENSIONS, mm		
DEPTH 1	O INVERT OF OUTLET	WIDTH	LENGTH		
	≤600	450	450		
>600	≤900	600	600		
>900	≤1200	600	900		
>1200		900	900		
TANDARD PIT	NOTES		900		
WHERE PIT DEP	TH IS DEEPER THAN 900.				
DEEP, SUBJECT	T NOTED IS ONLY REQUIRED FOR F TO COUNCIL REQUIREMENTS. PITS JIRE STRUCTURAL ENGINEERS DES	GREATER THAN 3000			
	T CONSTRUCTION MAY BE USED SI				

ENGINEERS APPROVAL 4. CONCRETE STRENGTH F'c = 32MPa

PROJECT

13-19 CANBERRA AVE, ST LEONARDS NSW 2065

PROPOSED DEVELOPMENT AT


STORMWATER SERVICES - TYPICAL DETAILS

PROJECT No. 2000192


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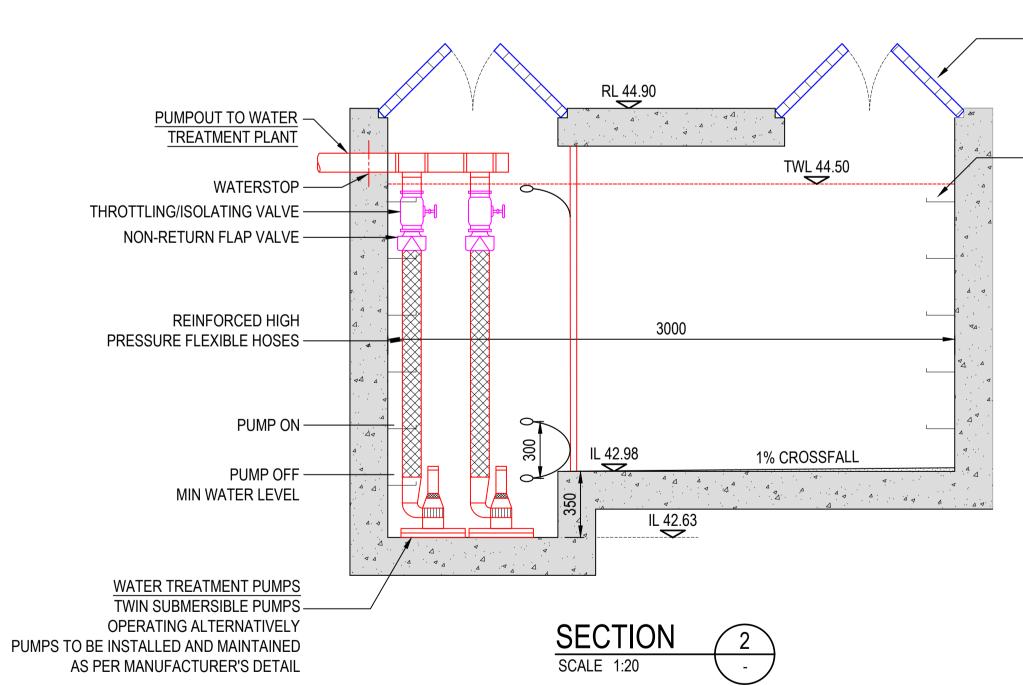
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REV





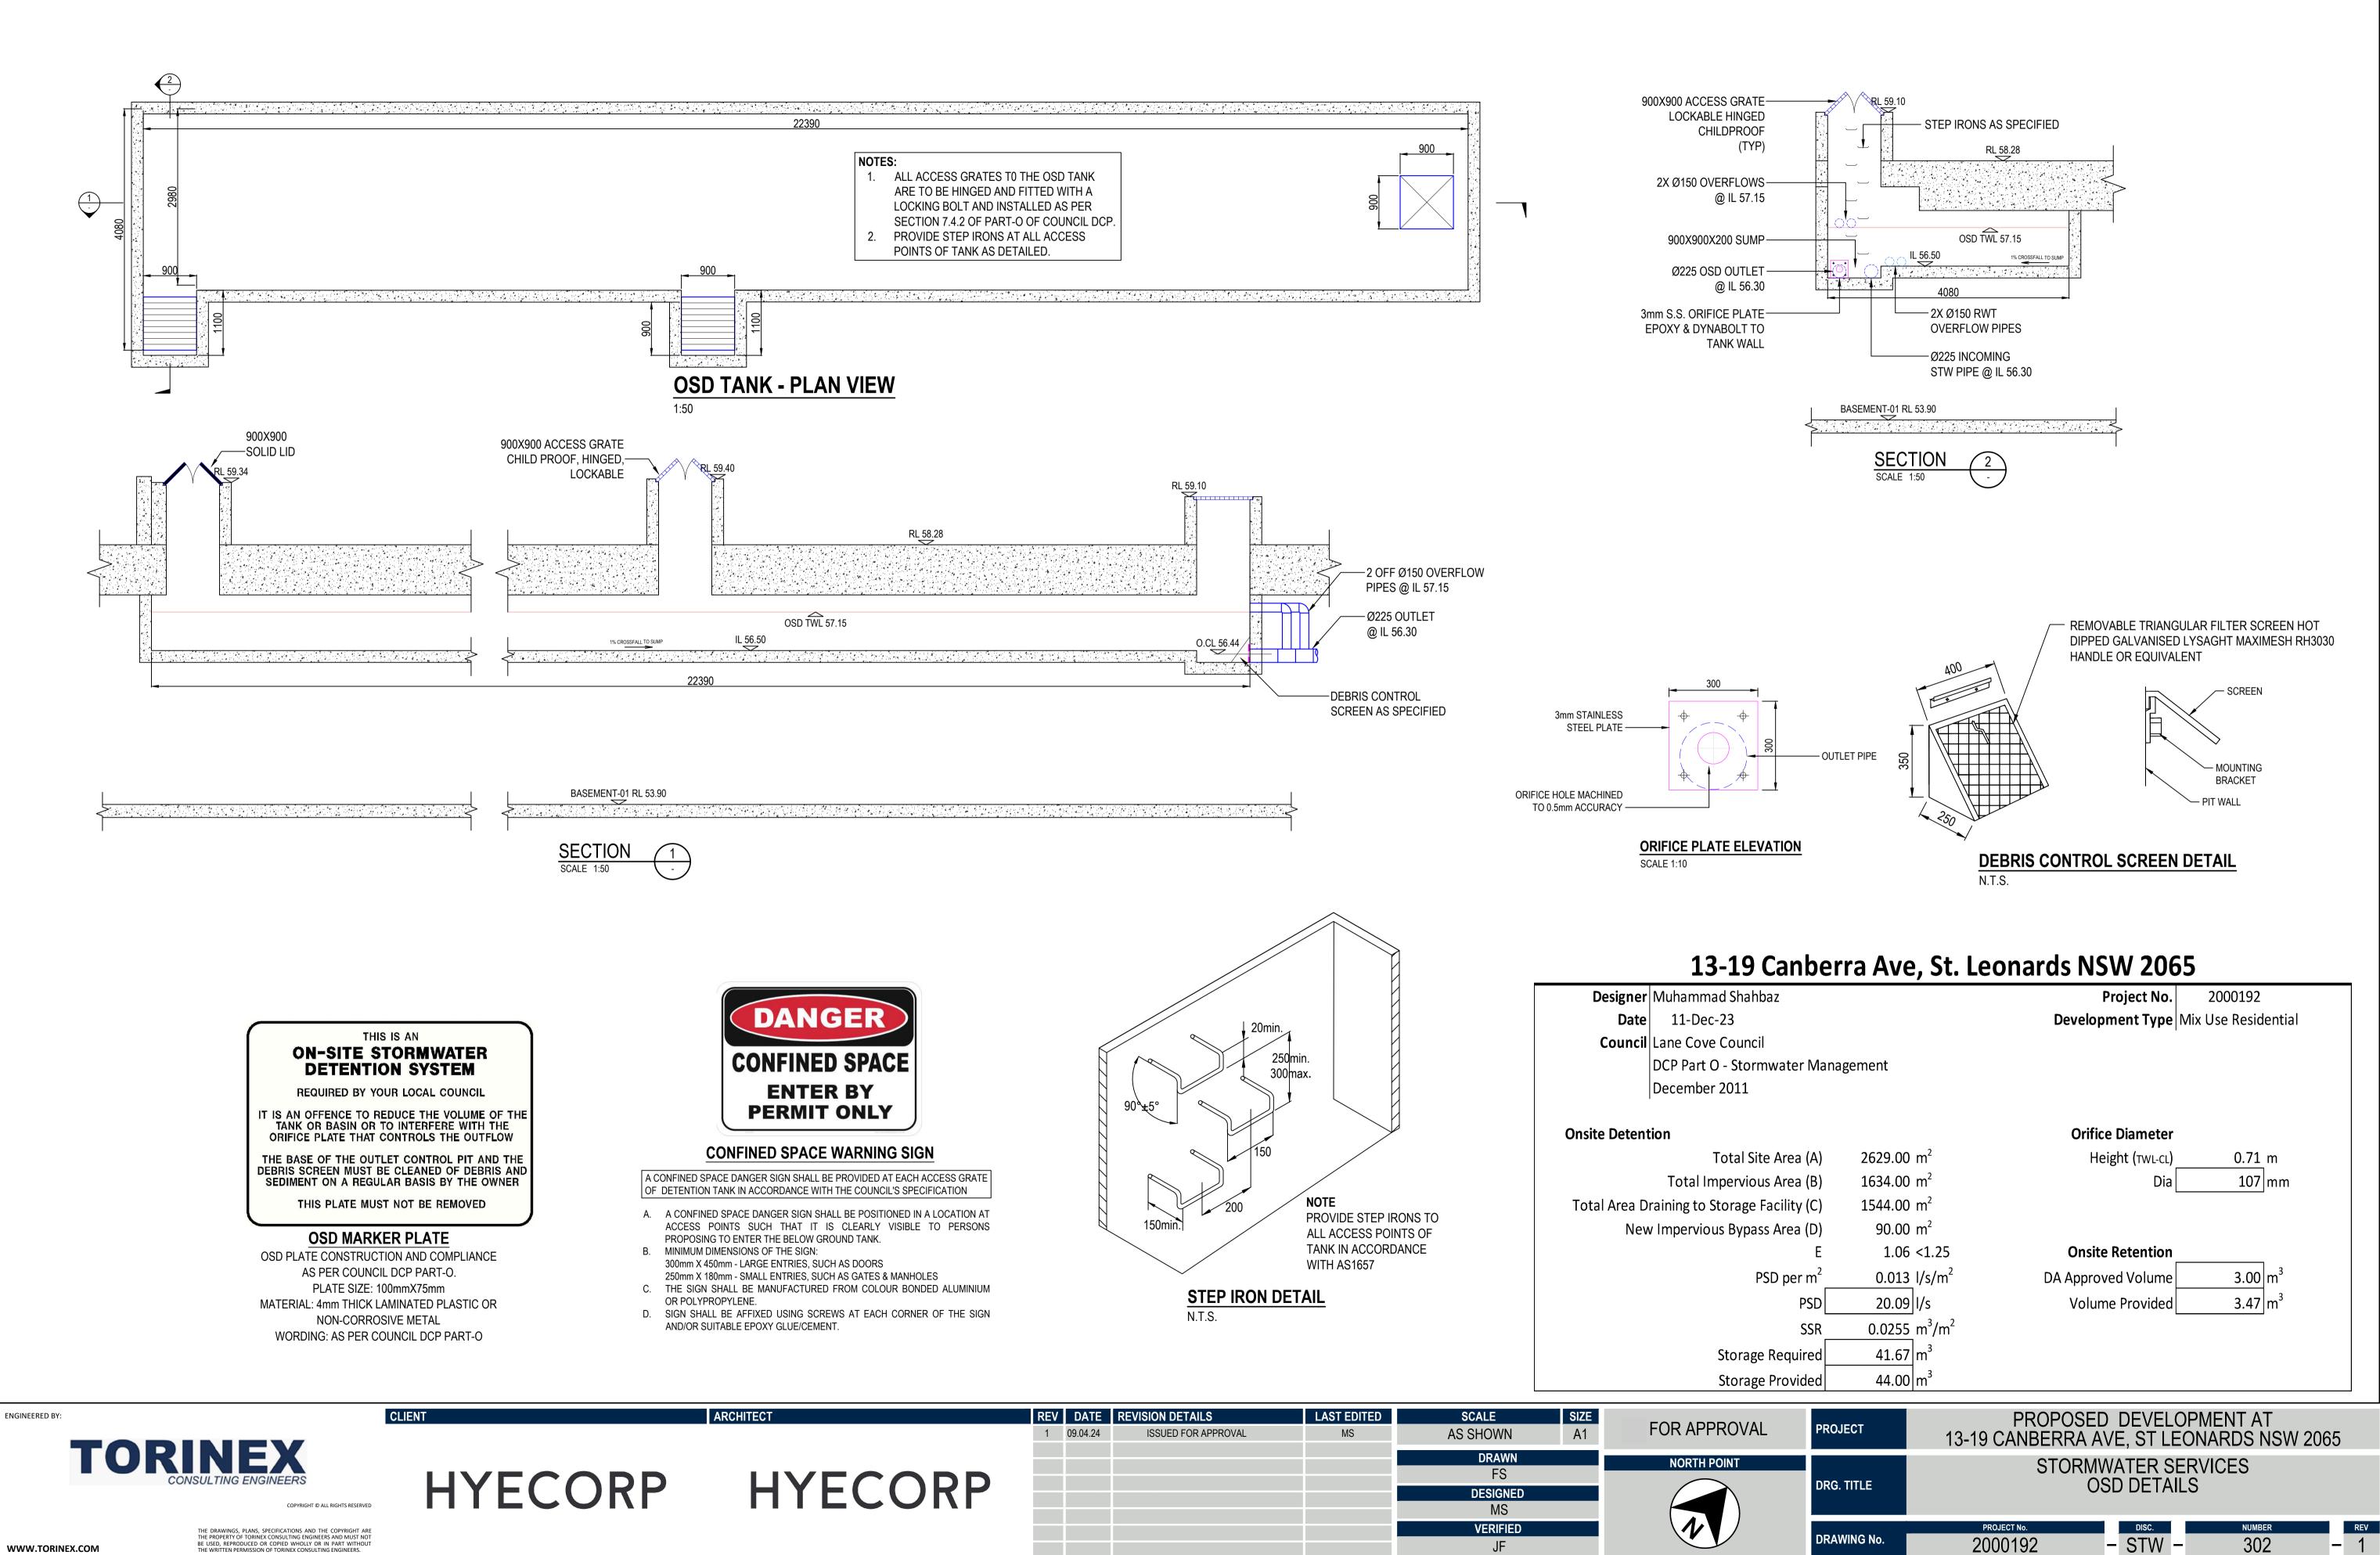

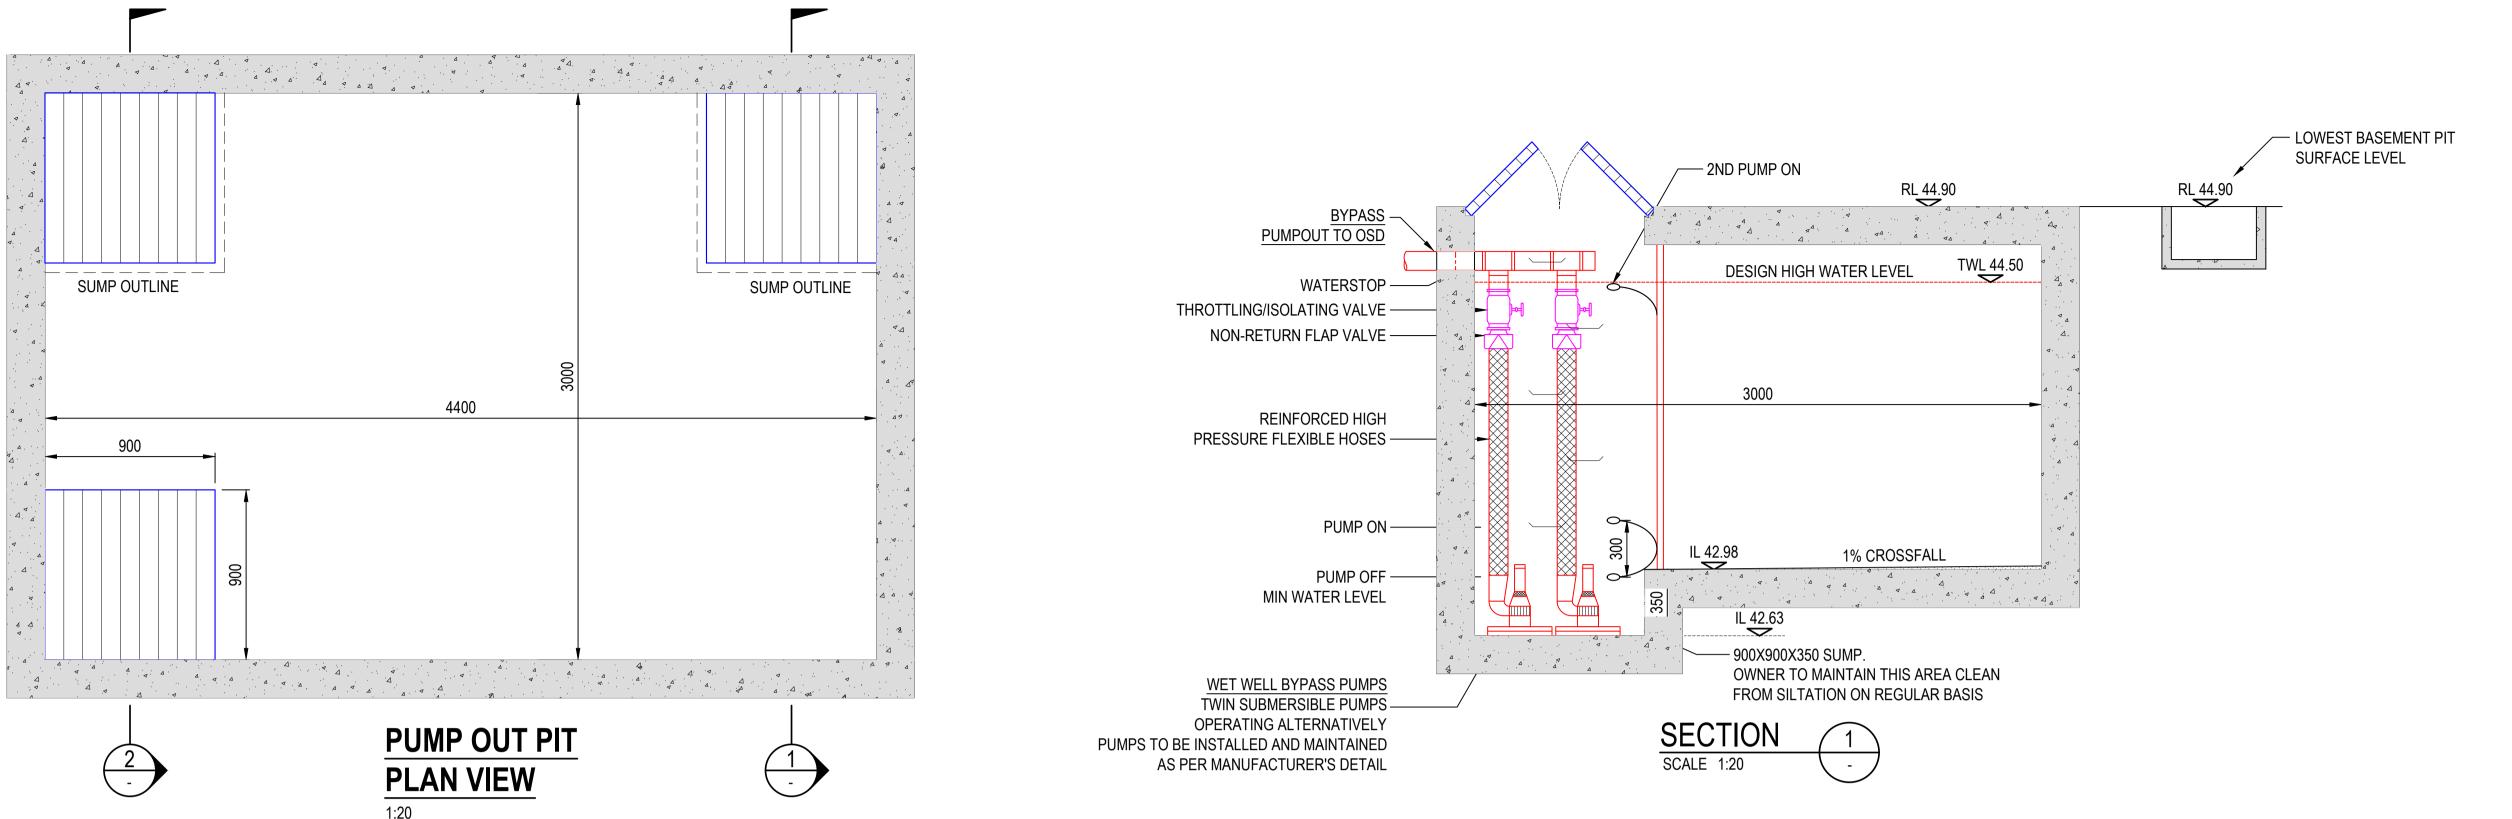

ARCHITECT

CLIENT

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HYECORP



ENGINEERED BY:

- GRATE (TYP)

900X900 HINGED

PROVIDE GALVANIZED STEP IRONS AT 200mm CENTERS IN ACCORDANCE WITH AS1657 AT ALL ACCESS POINTS OF TANK

WARNING **PUMP OUT SYSTEM**

FAILURE IN BASEMENT WHEN LIGHT IS FLASHING AND SIREN IS SOUNDING

NOTE

- SIGN SHALL BE PLACED IN A CLEAR AND VISIBLE 1. LOCATION WHERE VEHICLES ENTER THE BASEMENT.
- 2. COLOURS

WARNING - RED ALL OTHERS - BLACK

PUMP OUT FAILURE WARNING DETAILS

ARCHITECT	CHITECT REV DATE REVIS 1 09.04.24 1		MS	SCALE ASH SHOWN	SIZE A1	FOR APPROVAL PROJECT		PROPOSED DEVELOPMENT AT 13-19 CANBERRA AVE, ST LEONARDS NSW 2065			2065
HYECORP				DRAWN FS DESIGNED MS	FS SIGNED	NORTH POINT DRG. TITLE	DRG. TITLE	STORMWWATER SERVICES PUMPOUT PIT DETAILS			
				VERIFIED			DRAWING No.	PROJECT No. 2000192	– STW –	NUMBER 303	- 1

Pum	pout Pit Size		
	Exposed Area Draining to Basement	0	m²
	1% AEP @ 5 minutes	259.9	mm/hr
	50% AEP @ 5 minutes	124	mm/hr
	Groundwater Inflow Annual Avg	3	ML/year
	24 Hr Seepage Volume	8.22	m ³
	24 Hr Seepage Volume @ 1% AEP	17.23	m ³
	Total Voulme Required	17.23	m³
	Total Voulme Provided	20.06	m³

Pump Capacity


amp capacity			
	Water Treatment Pumps	1 l/s @ 5m	each pump
	Wet Well Bypass Pumps	10 l/s @ 18m	each pump
	Lift Well Pumps	5 l/s @ 3m	each pump


STANDARD PUMP-OUT **DESIGN NOTES**

THE PUMP OUT SYSTEM SHALL BE DESIGNED TO BE OPERATED IN THE FOLLOWING MANNER:

1. THE PUMPS SHALL BE PROGRAMMED TO WORK ALTERNATELY SO AS TO ALLOW BOTH PUMPS TO HAVE AN EQUAL OPERATION LOAD AND PUMP LIFE.

- 2. A LOW LEVEL FLOAT SHALL BE PROVIDED TO ENSURE THAT THE MINIMUM REQUIRED WATER LEVEL IS MAINTAINED WITHIN THE SUMP AREA OF THE BELOW GROUND TANK. IN THIS REGARD THIS FLOAT WILL FUNCTION AS AN OFF SWITCH FOR THE PUMPS.
- A SECOND FLOAT SHALL BE PROVIDED AT A HIGHER 3. LEVEL, APPROXIMATELY 300mm ABOVE THE MINIMUM WATER LEVEL, WHEREBY ONE OF THE PUMPS WILL OPERATE AND DRAIN THE TANK TO THE LEVEL OF THE LOW LEVEL FLOAT.
- 4. A THIRD FLOAT SHALL BE PROVIDED AT A HIGH LEVEL, WHICH IS APPROXIMATELY THE ROOF LEVEL OF THE BELOW GROUND TANK. THIS FLOAT SHOULD START THE OTHER PUMP THAT IS NOT OPERATING AND ACTIVATE THE ALARM.
- 5. AN ALARM SYSTEM SHALL BE PROVIDED WITH A FLASHING STROBE LIGHT AND A PUMP FAILURE WARNING SIGN WHICH ARE TO BE LOCATED AT THE DRIVEWAY ENTRANCE TO THE BASEMENT LEVEL. THE ALARM SYSTEM SHALL BE PROVIDED WITH A BATTERY BACK-UP IN CASE OF POWER FAILURE.

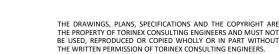

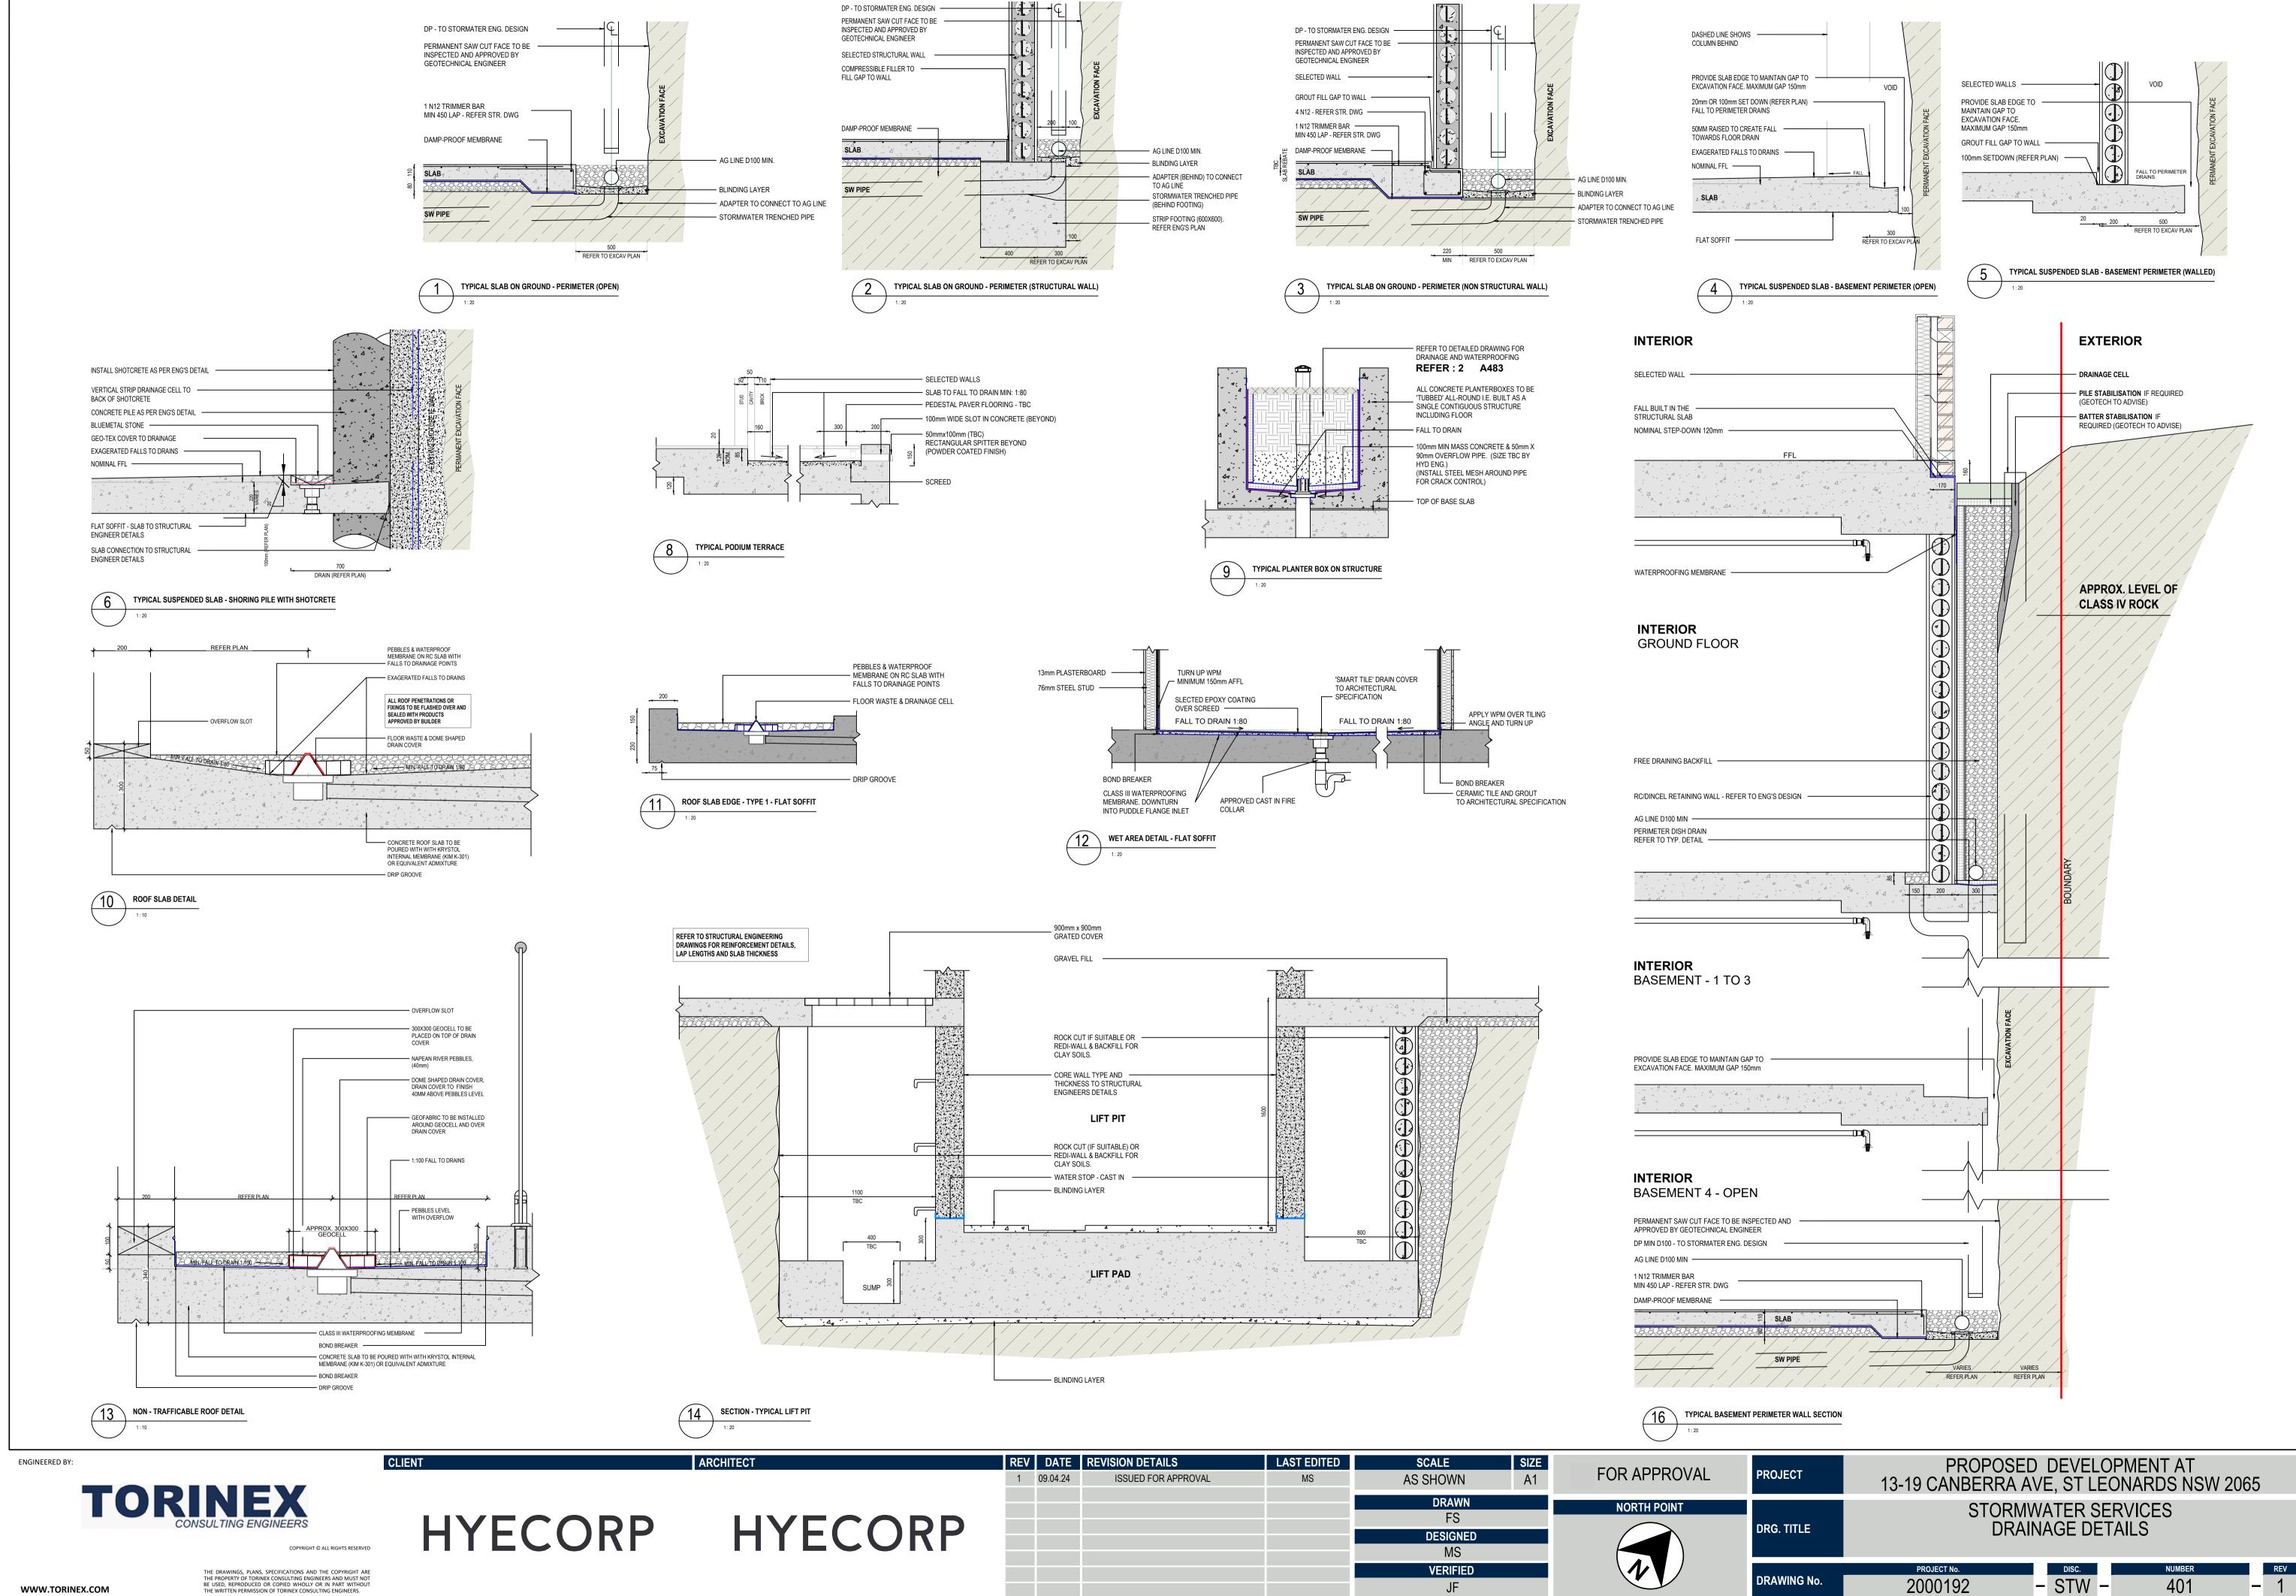

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